# 2023 GREEN INFRASTRUCTURE UPGRADES

# FREDERICK J GAENSLEN K-8 SCHOOL SITE #185

1250 E. BURLEIGH STREET, MILWAUKEE, WI 53212 FINAL PLAN SET

# **INDEX OF DRAWINGS**

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# **GENERAL**

**LEGEND AND NOTES** 

SITE & C	CIVIL
C001	EXISTING CONDITIONS
C002	MGIS EXISTING CONDITIONS
C003	SITE PREPARATION AND EROSION CONTROL PLAN
C004	ASPHALT BASE COURSE REMOVAL PLAN
C005	MGIS SITE PREPARATION AND EROSION CONTROL PLAN
C100	SITE PLAN
C200	GRADING PLAN
C201	MGIS GRADING PLAN
C300	STORM SEWER PLAN
C400	PAVEMENT PLAN
C500	DETAILS
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## LANDSCAPE

LANDOGALE		
L100	MATERIALS	
L200	PAVEMENT MARKINGS PLAN	
L300	PLANTING PLAN	
L400	SITE DETAILS	
L401	SITE DETAILS	
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L403	SITE DETAILS	
L404	SITE DETAILS	
L405	SITE DETAILS	
L500	PLANTING DETAILS	
L501	PLANTING DETAILS	



1" = 400' MGIS SITE MAP DEPOSIT LOCATION FOR CUT MATERIAL AT MILWAUKEE GERMAN IMMERSION SCHOOL (MGIS) REFER TO C002, C005, C201



PROJECT NUMBER: 8176 (DIVISION 2)

## **PROJECT APPROVAL BY:**



MILWAUKEE PUBLIC SCHOOLS DIVISION OF FACILITIES AND MAINTENANCE SERVICES 1124 NORTH 11TH STREET **MILWAUKEE**, WI 53205-0259 PHONE: 414-283-4600 FAX: 414-283-4682



# PRIME CONSULTANT

**Stormwater Solutions Engineering, LLC.** 247 W Freshwater Way, Suite 410 Milwaukee WI 53204 Phone: 414-810-1245 Kara Koch, P.E., ENV. SP Senior Project Engineer kara@stormwater-solutions-engineering.com



# LANDSCAPE ARCHITECT CONSULTANT

**Learning Landscapes Design, LLC** 4241 SW Tunnelwood Street Portland, OR 97221

## **ALTERNATE NOTES:**

## **MANDATORY ALTERNATE BID #1**

**OVERHEAD STRUCTURE:** INSTALL OVERHEAD STRUCTURE WITH FOOTINGS PRIOR TO THE INSTALLATION OF THE CONCRETE PAD. INSTALL IN ENTIRETY, METAL POLYGON STRUCTURE WITH THE GUTTER AND DOWNSPOUT. COORDINATE WITH ENGINEER ON LOCATION FOR DOWNSPOUT AND ROOF PITCH.

#### MANDATORY ALTERNATE BID #2 **NATURE PLAY:**

BASE BID INCLUDES THE INSTALLATION OF THE CONCRETE CURB AND ENGINEERED WOOD FIBER SURFACING. ADD ALTERNATE FOR THE INSTALLATION OF NATURE PLAY AS SPECIFIED.


#### MANDATORY ALTERNATE BID #3 MILL AND OVERLAY BASKETBALL COURT:


AS ALTERNATE, MILL BASKETBALL COURT AREA AND OVERLAY ASPHALT

# **CONSTRUCTION BARRICADE NOTES:**

FOR CONSTRUCTION BARRICADING WHERE A SEPARATION IS NEEDED BETWEEN AN AREA TO BE RECONSTRUCTED AND AN AREA TO REMAIN, BUT THERE IS NO EXISTING FENCING, A TEMPORARY 6 FOOT HIGH CHAIN LINK FENCE, SELF SUPPORTED, FREE STANDING SHALL BE USED AND MAINTAINED UNTIL THE PROJECT IS COMPLETE.

CONSTRUCTION BARRICADING SHALL BE MAINTAINED ON A DAILY BASIS TO ASSURE THAT AT THE END OF EACH WORK DAY THE SITE IS SECURED.

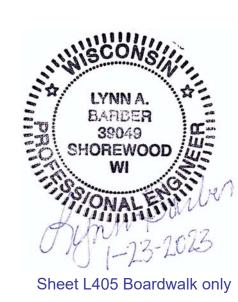

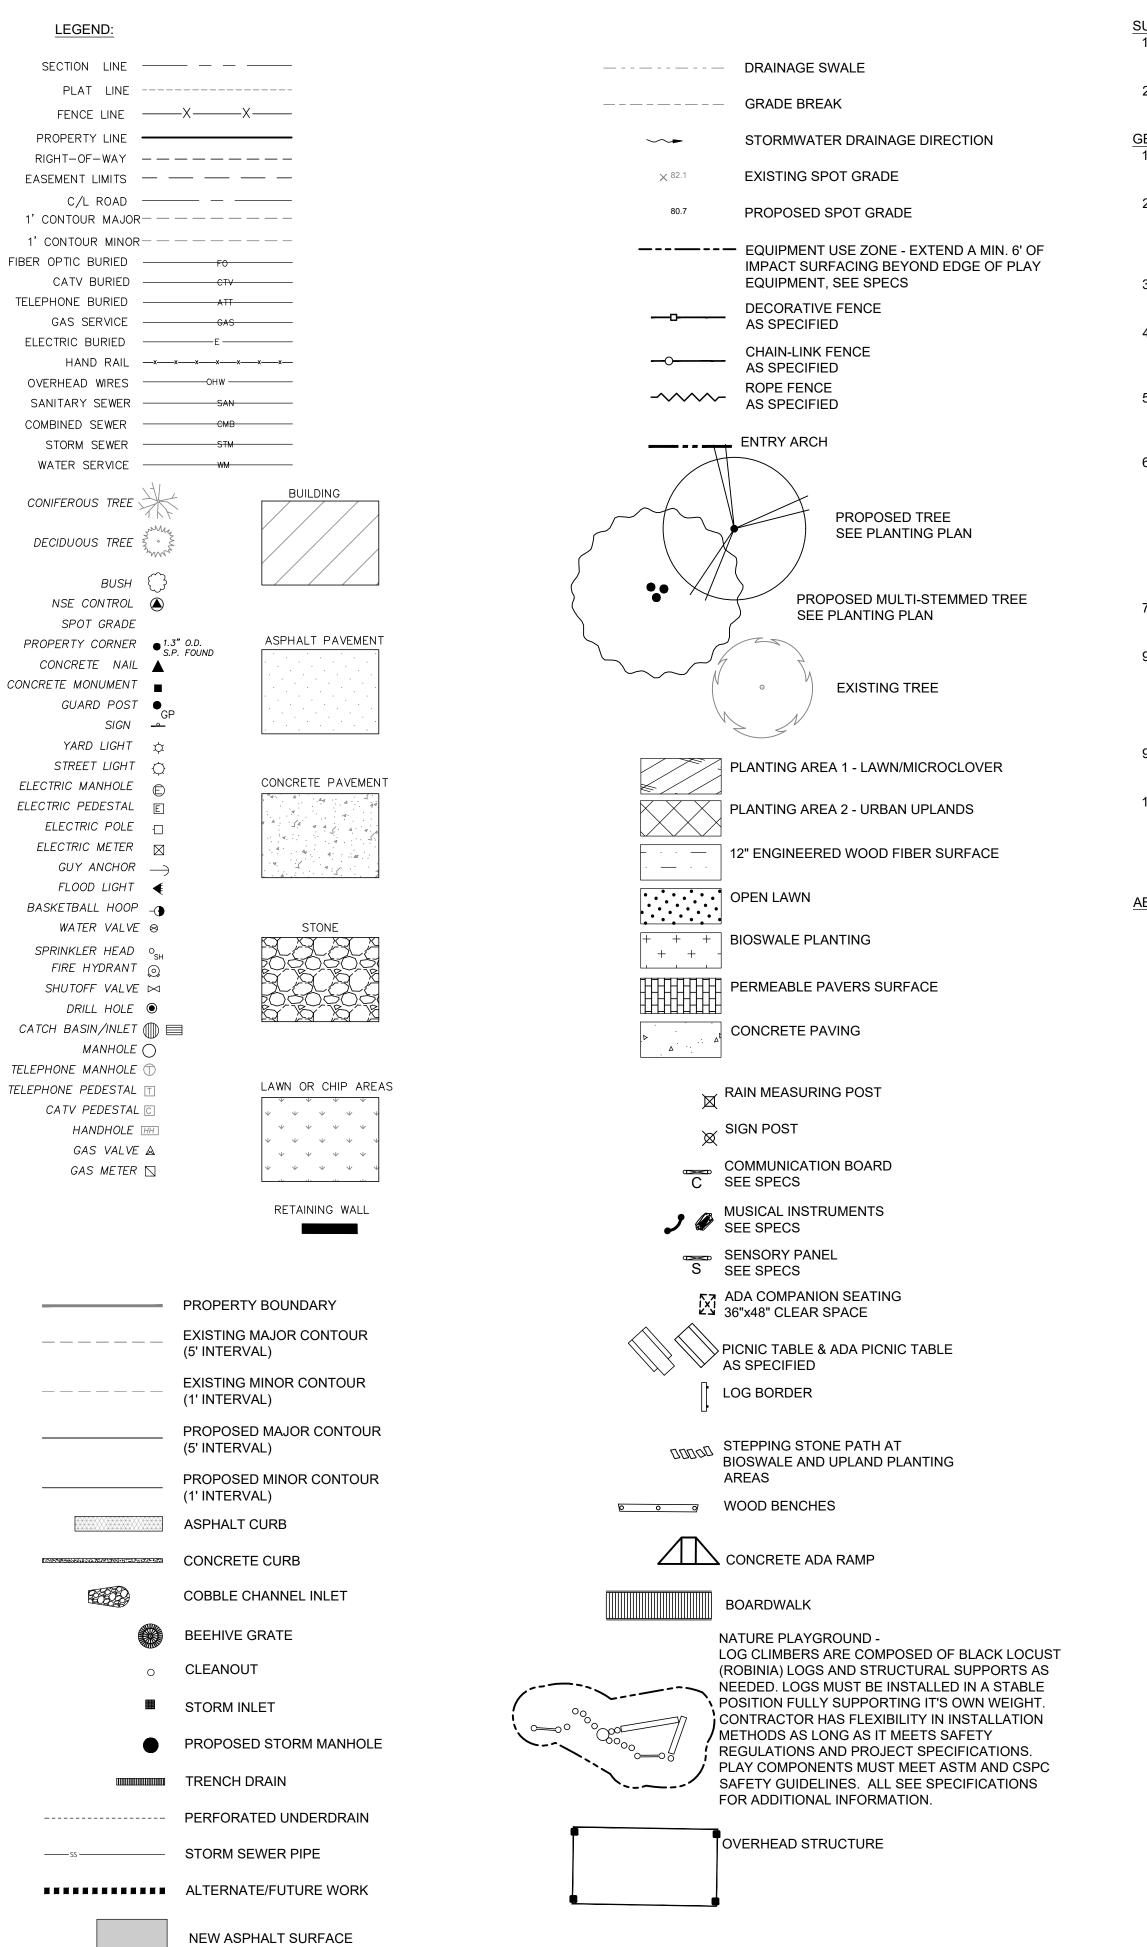

- SURVEY PREPARED BY NORTH SHORE ENGINEERING, INC. REFER TO PLAT OF SURVEY FOR ALL EXISTING CONDITION
- 2) UTILITIES MARKED BY DIGGERS HOTLINE AND ALL LINES UTILITY SERVICE.

### **GENERAL NOTES:**

1. THE CONTRACTOR TO COMPLY WITH ALL APPLICABLE CODES AND REGULATIONS OF AUTHORITIES HAVING JURISDICTION OVER THE WORK.

- CONTRACTOR TO VERIFY DIMENSIONS INDICATED ON DRAWINGS WITH FIELD MEASUREMENTS BEFORE FABRICATION OR ORDERING OF MATERIALS PRIOR TO COMMENCEMENT OF ANY DEMOLITION OR CONSTRUCTION.
- DO NOT SCALE DRAWINGS. 3. CONTRACTOR TO NOTIFY ENGINEER OF EXISTING CONDITIONS DIFFERING FROM THOSE INDICATED ON THE
- DRAWINGS. CONTRACTOR TO CONTACT PUBLIC AND PRIVATE UNDERGROUND UTILITY LOCATING SERVICES TO HAVE THE SITE MARKED PRIOR TO ANY DIGGING OR EARTHWORK.
- CONTRACTOR TO REPLACE ANY INSTALLED MATERIAL NOT MEETING THE SPECIFICATION OR PLAN REQUIREMENTS WITH MATERIAL THAT MEETS THESE REQUIREMENTS WITHOUT ADDITIONAL COST TO THE OWNER.
- CONTRACTOR TO REPLACE PAVEMENT, CURB AND GUTTER, TREES, LAWN AREA, ANY ABOVE GROUND APPARATUSES, OR ANY OTHER ITEM THAT WAS DAMAGED AS A RESULT OF CONSTRUCTION RELATED ACTIVITIES AS DEEMED BY OWNERS REPRESENTATIVE THAT WAS NOT CALLED OUT FOR REMOVAL OR REPLACEMENT. CONTRACTOR TO REPLACE/REPAIR DAMAGED ITEM TO THE SATISFACTION OF THE OWNER'S REPRESENTATIVE AT NO ADDITIONAL COST TO THE OWNER.
- 7. SURVEY PREPARED BY NORTH SHORE ENGINEERING, INC. REFER TO PLAT OF SURVEY FOR FULL EXISTING CONDITION DETAILS.
- 9. FOR CONSTRUCTION BARRICADING WHERE A SEPARATION IS NEEDED BETWEEN AN AREA TO BE RECONSTRUCTED AND AN AREA TO REMAIN, BUT THERE IS NO EXISTING FENCING, A TEMPORARY 6 FOOT HIGH CHAIN LINK FENCE, SELF SUPPORTED, FREE STANDING SHALL BE USED AND MAINTAINED UNTIL THE PROJECT IS COMPLETE.
- CONSTRUCTION BARRICADING SHALL BE MAINTAINED ON A DAILY BASIS TO ASSURE THAT AT THE END OF EACH WORK DAY THE SITE IS SECURED.
- 10. CONTRACTOR IS TO SECURE CONSTRUCTION AREA FOR SAFETY. INCLUDING BUT NOT LIMITED TO: TRAFFIC CONTROL SIGNAGE, BARRICADE ENTRANCE, AND PLACE CONSTRUCTION FENCE AROUND OPEN TRENCHES AND SAWCUT AREAS.

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W/

WS

TOPO

BBRE	VIATIONS	
	<u>D</u>	AT
	6	PERCENT SLOPE, '/', FT/FT
	ABDN	ABANDONED
	AGGR	AGGREGATE
	ALT ADDDOX	ALTERNATE
	APPROX	APPROXIMATE
	APVD ASTM	APPROVED
F	49 I M	THE AMERICAN SOCIETY OF TESTING AND MATERIALS
,	AVE	AVENUE
	BLDG	BUILDING
	BM	BENCHMAR
	CB	CATCH BASIN
	CJ	CONSTRUCTION JOINT
	C/L	CENTERLINE
	DIA	DIAMETER
	SGN	DESIGNER
	DWG	DRAWING
Е		EASTING, EAST
	ĒΑ	EACH
	G	EXISTING GRADE
	L	ELEVATION
	LEV	ELEVATION
	QL 	EQUAL SUNT
	J X	EXPANSION JOINT EXISTING
	:X :T	FOOT, FEET
	SND	GROUND
	SR	GRADE
	HORIZ	HORIZONTAL
	iP	HIGH POINT
H	HYD	HYDRANT
II.	NV	INVERT
L	.F	LINEAL FEET
	.Т	LEFT
	ЛАХ	MAXIMUM
	ЛH	MANHOLE
	AIN AISC	MINIMUM
	/ISC /MSD	MISCELLANEOUS MILWAUKEE METROPOLITAN
IV.	AINISD	SEWERAGE DISTRICT
N	J	NORTH, NORTHING
	, IE	NORTHEAST
	10	NUMBER
	#	NUMBER
N	NTS	NOT TO SCALE
N	1W	NORTHWEST
F	PROP	PROPOSED
	PVMT	PAVEMENT
	RT.	RIGHT
	VMS	REMOVE
	ROW R/W	RIGHT OF WAY RIGHT OF WAY
	5/ VV S	SOUTH, SLOPE
	SE	SOUTHEAST
	SPEC	SPECIFICATIONS
	3Q	SQUARE
	ST	STREET
	STA	STATION
S	STD	STANDARD
	SW	SOUTHWEST
	T&B	TOP AND BOTTOM
	OC	TOP OF CURB
Т	TOS.	TOP OF SLOPE

TOP OF SLOPE

TOPOGRAPHIC

WATER SURFACE

TYPICAL

WITH

#### QUANTITY NOTES:

**GENERAL & SITE PREP** 

Mobilization

Sawcutting

Asphalt removal

Chain Link Fence Removal

Stone base course removal

Storm sewer pipe removal

Storm catch basin removal

Haul to MGIS excess material

Rough & fine grading

Provide, install, maintain, and remove silt sock

Provide, install, and maintain inlet protection

Remove basketball backboard and hoops

Clearing understory of invasive species

6" perforated PVC underdrain and fittings

6" solid PVC storm sewer pipe and fittings

6" Clean out with cast iron lid and fitting

Metal lockable beehive grate (Nyloplast)

Neenah rim and solid lid for catch basin

Dura slope trench with galvanized grate

Core into existing trapped manhole

2" Stilling well attached to standpipe

Adjust rim elevation of existing catch basin

NDS 9" catch basin kit with galvanized grate and risers

6" gate valve, extension stem, and associated fittings

18 in diameter standpipe (Nyloplast)

Fabco Beehive Overflow Filter

36 in diameter Catch Basin

Bioswale engineered media

Bioswale No. 1 clear stone

Bioswale pea gravel

Bioswale jute mat

Cobble drain inlet

UNDERGROUND CISTERN

Cistern - Freight

HARDSCAPE

Asphalt curb

Painted Play

**FURNITURE & EQUIPMENT** 

Musical instruments

Rain Measuring Post

Metal edging, steel

Bioswale seed

Shade trees, 3" cal.

Cedar mesh fence

Low Rope Fence

4' Ht Chainlink Fence

Topsoil, imported and placed

No-Mow Lawn / Microclover Seed

Perennials and grasses, plugs

Tree protection staking

Wood Boardwalk

**Entrance Arch** 

Sign Post

LANDSCAPE

FENCING

Basketball Hoops

Wood bench

Picnic Tables

Sensory Panel

Asphalt paving / patch

Raised concrete curb

ADA concrete ramp

EWF aggregate subbase

5" concrete slab / walkway

12" engineered wood fiber (EWF)

Crack fill & clean asphalt surface

Existing Play Structure Improvements - Slide

Existing Play Structure Improvements - Panels (3)

Log border - horizontal (assumes 8' ave. length)

Urban Erosion Control Mat for Urban Planting areas

Cistern sand bedding layer

Cistern backfill, No. 1 stone

Cistern Geotextile Fabric, M200 for tank

Cistern Geotextile Fabric, M200 for excavation

Maintenance ports, boots, misc. materials

Permeable paver, setting bed, and joint stone

Permeable paver No. 1 clear stone

Underground storage tanks (Single R-Tank LD, stacked double)

Cobble channel inlet

6" Animal guard

1) THE BELOW QUANTITIES ARE APPROXIMATIONS AND ARE NOT INTENDED TO BE USED DURING CONSTRUCTION ACTIVITIES. CONTRACTORS ARE RESPONSIBLE FOR QUANTIFYING ITEMS PRIOR TO COMMENCING WORK.

Quantity Unit

1 LS

1 EA

2 EA

102 LF

1107 LF

29245 SF

243 CY

29248 SF

1865 SF

83 LF

2 EA

553 CY

105 LF

170 LF 2 EA

1 EA

1 EA

1 EA

1 EA

0 EA

8 LF

1 EA

0 EA

1 EA

1 EA

0 EA

103 CY

504 SY

1 EA

2 EA

3 EA

363 SY

488 SY

430 EA

1 LS

1 LS

955 SF

134 LF

3394 SF

2077 SF

86 LF

955 SF

47274 SF

15 TONS

1 LS

2 EA 2 LS

24 EA

2 EA

3 LS

1 LS

1 LS

1 EA

1 LS

1 EA

1 EA

350 LF

113 LF

346 CY

828 SY 1520 SF

6637 SF

33 EA

3141 EA

24 EA

252 SY

22 LF

132 LF

100 LF

23 TONS

20 TONS


22 TONS

96 TONS

27 TONS

- 2) DISCREPANCIES TO BE COMMUNICATED WITH MPS AND THE PROJECT ENGINEER.
- 3) VOLUMES PROVIDED ARE MEASURED AS IN-PLACE CUBIC YARDS.

1	1 OVERHEAD STRUCTURE	
	Overhead Structure	1
2	2 NATURE PLAY	
	Nature Play (log steppers and balancing logs)	1
3	MILL AND OVERLAY BASKETBALL COURT	
	Mill and Overlay	2816

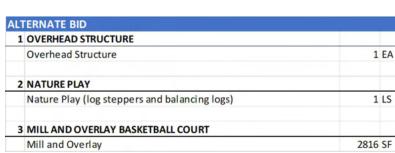

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**STORMWATER** 

**ENGINEERING**<sub>100</sub>

SOLUTIONS



LEARNING LANDSCAPES DESIGN, LLC **4241 SW TUNNELWOOD STREET** PORTLAND, OR 97221



**DIVISION OF FACILITIES AND** MAINTENANCE SERVICES

1124 NORTH 11TH STREET **MILWAUKEE, WI 53205-0259** PHONE: 414-283-4600 FAX: 414-283-4682

SHEET NAME: LEGEND AND NOTES	PROJECT NAME: 2023 GREEN INFRASTRUCTURE UPGRADES	PROJECT ADDRESS: FREDERICK J GAENSLEN K-8 SCHOOL 1250 E. BURLEIGH STREET, MILWAUKEE, WI 53212
1SSUED FOR 50% CD 90% CD	REV:	<b>DATE:</b> 11/14/2022 12/22/2022
100% CD		1/23/2023

**EMP** 

KLK

CBG

January 2023

Know what's **below**. Call before you dig.

PROJECT NUMBER: 8176 (DIVISION 2)

SITE NUMBER: 146

**DRAWN BY:** 

DATE:

**REVIEWED BY:** 

**APPROVED BY:** 


**SEAL AND SIGNATURE** 


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SHEET:

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LIMIT OF WORK



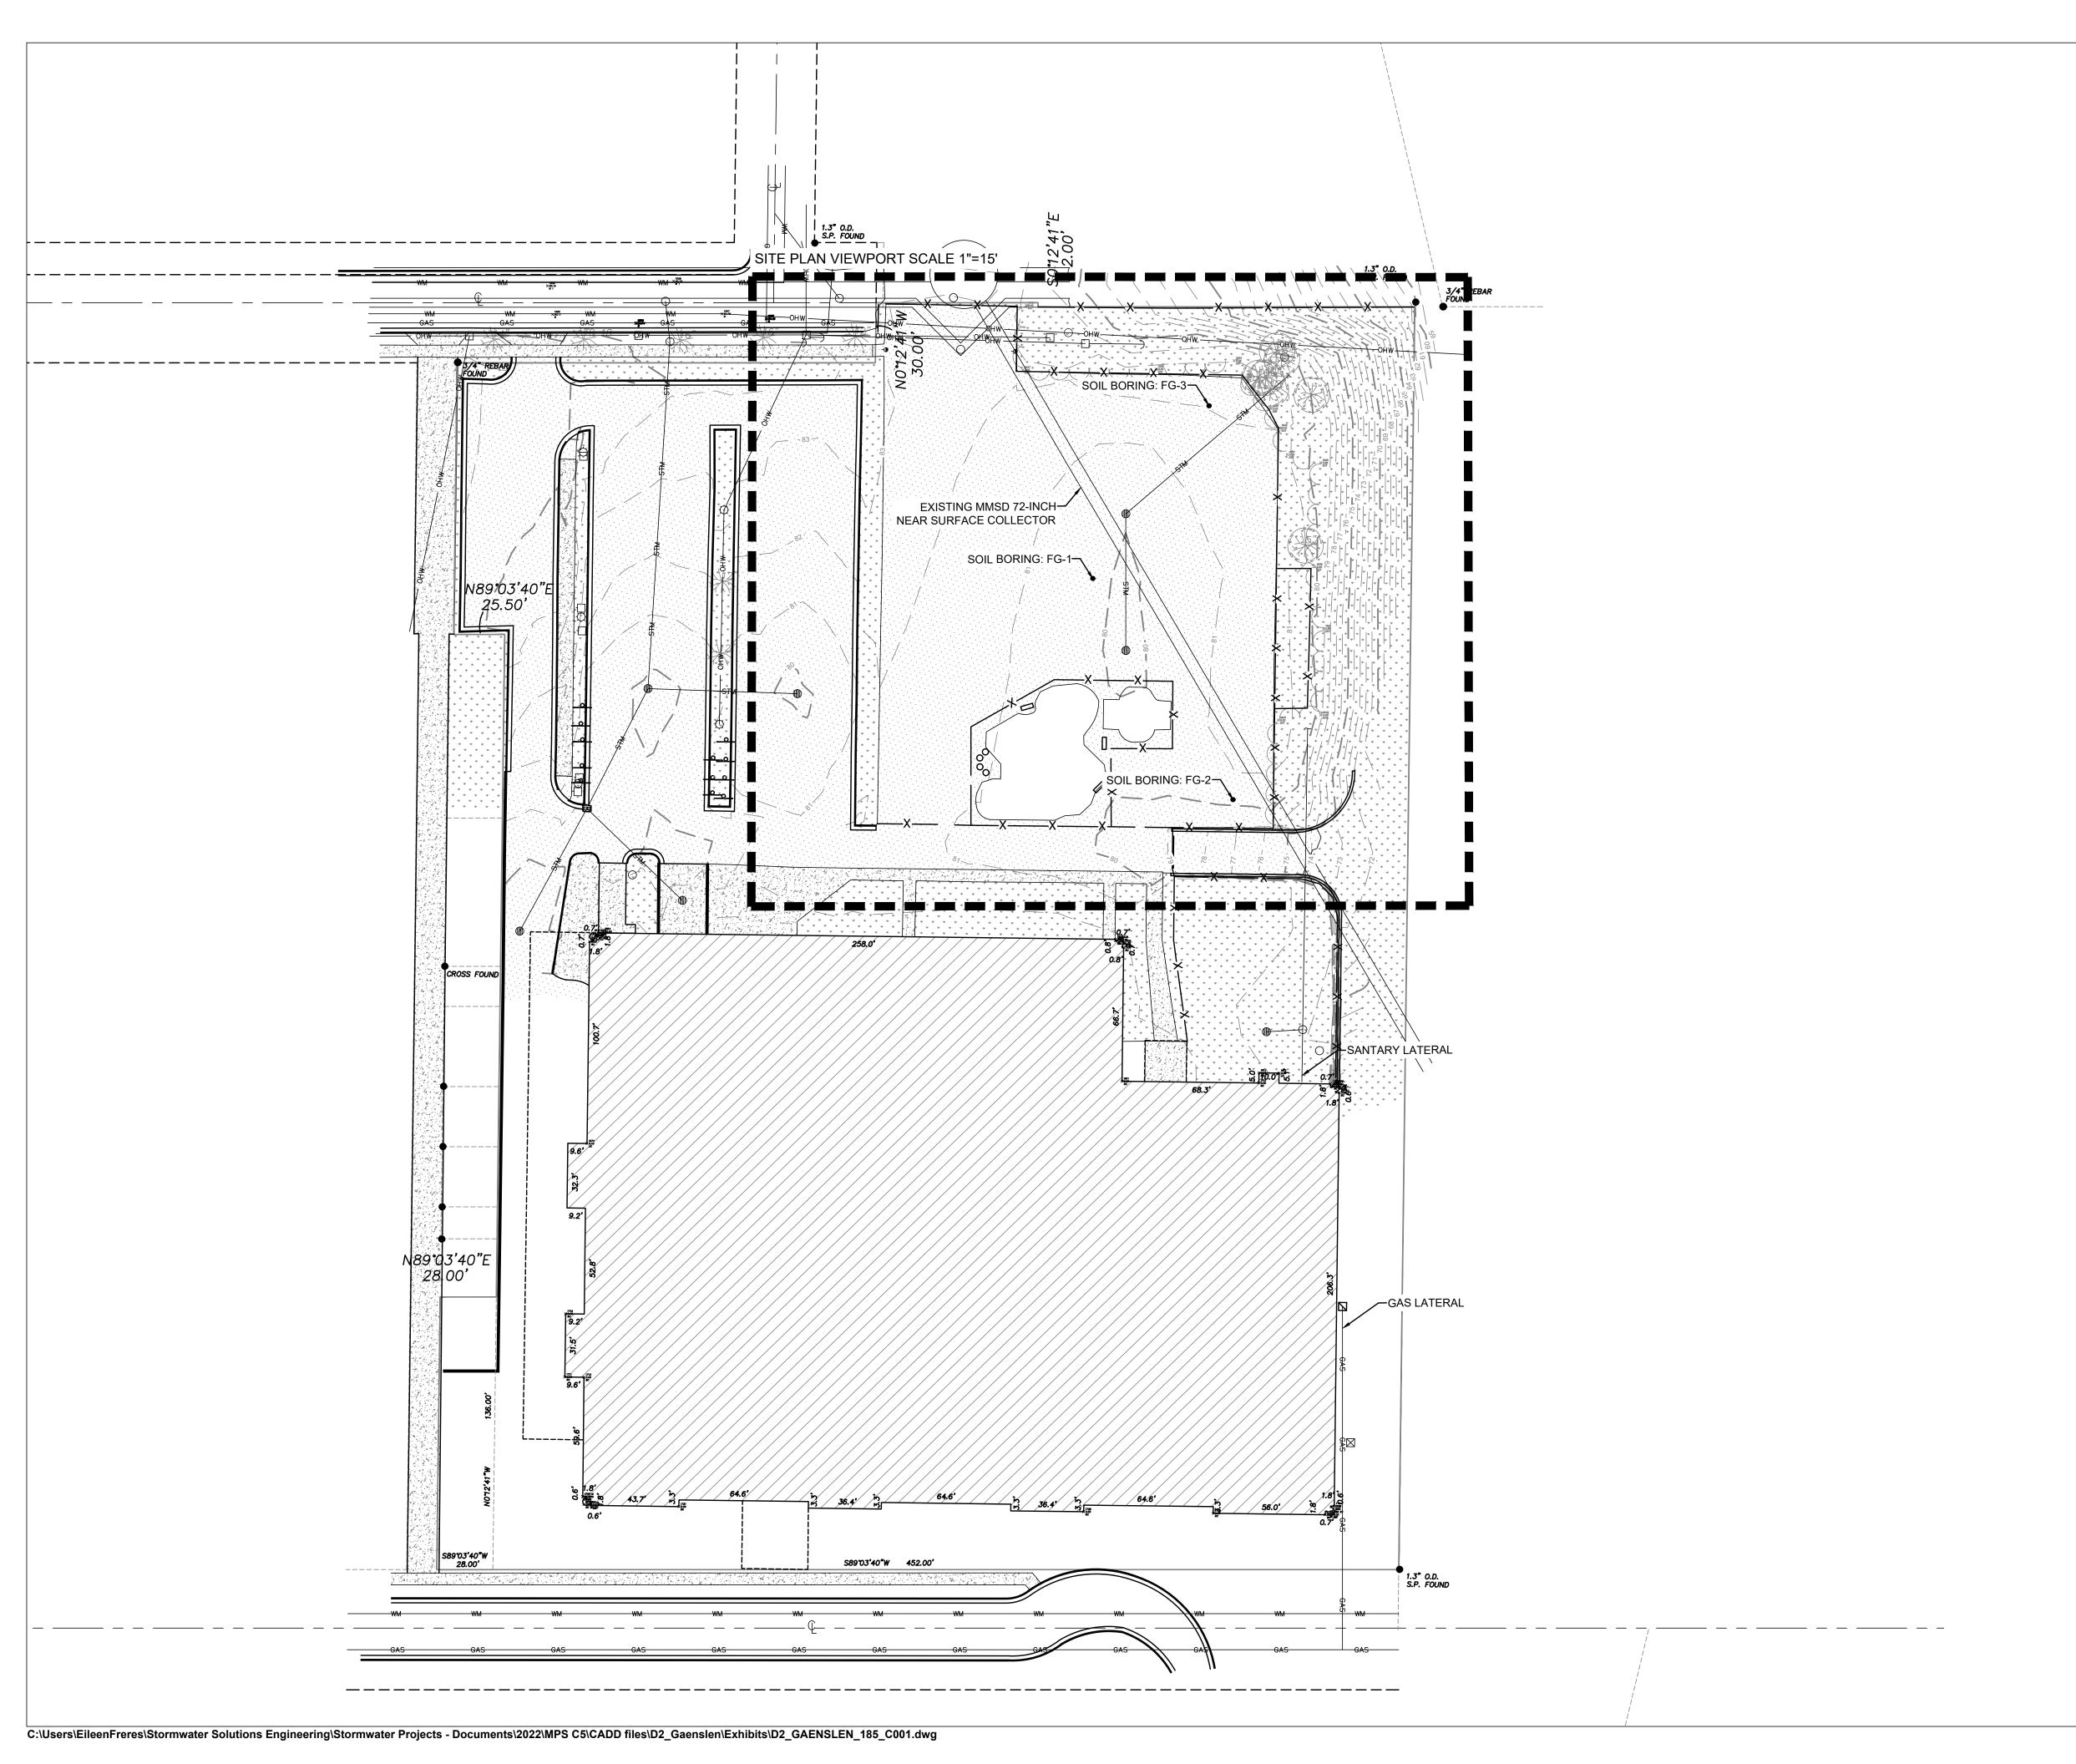

ASPHALT PAVEMENT

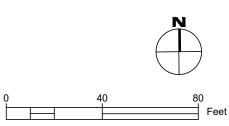STONE

LAWN OR CHIP AREAS

V V V **V V V** 

Ψ Ψ Ψ

 $\forall$   $\forall$ 

RETAINING WALL

LEGEND:

CONIFEROUS TREE

DECIDUOUS TREE 💈 ·

NSE CONTROL SPOT GRADE

PROPERTY CORNER • 1.3" O.D. S.P. FOUND

GUARD POST

YARD LIGHT 🌣 STREET LIGHT 💍 ELECTRIC MANHOLE

SIGN 🚢

CONCRETE NAIL

CONCRETE MONUMENT

ELECTRIC PEDESTAL

ELECTRIC POLE \_

GUY ANCHOR -

FLOOD LIGHT ◀

WATER VALVE ⊗

MANHOLE (

ELECTRIC METER 🖂

BASKETBALL HOOP -

SPRINKLER HEAD OSH FIRE HYDRANT 👩 SHUTOFF VALVE 🖂 DRILL HOLE 🔘 CATCH BASIN/INLET (11)

TELEPHONE MANHOLE

TELEPHONE PEDESTAL [

CATV PEDESTAL []

HANDHOLE HH

GAS VALVE △

GAS METER  $\square$ 

PROPERTY LINE ---

SECTION LINE — — — — PLAT LINE -----FENCE LINE ——X——X——

RIGHT-OF-WAY -----EASEMENT LIMITS — — — — —

1' CONTOUR MINOR-----

CATV BURIED — CTV TELEPHONE BURIED — ATT GAS SERVICE GAS ELECTRIC BURIED ————E————

HAND RAIL —<del>\*— \*— \*— \*— \*— \*</del>

SANITARY SEWER SAN

STORM SEWER STM WATER SERVICE WM

INC. REFER TO PLAT OF SURVEY FOR FULL EXISTING

COMBINED SEWER CMB

C/L ROAD -----1' CONTOUR MAJOR-----

BUSH ()



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SHEET NAME:  EXISTING CONDITIONS	PROJECT NAME: 2023 GREEN INFRASTRUCTURE UPGRADES	PROJECT ADDRESS: FREDERICK J GAENSLEN K-8 SCHOOL 1250 E. BURLEIGH STREET, MILWAUKEE, WI 53212
ISSUED FOR	: REV:	DATE:
50% CD 90% CD		1 <u>1/14/2</u> 022 1 <u>2/22/2</u> 022
007000		1212212022

**EMP** 

KLK

CBG

January 2023

**GENERAL NOTES:** SURVEY PREPARED BY NORTH SHORE ENGINEERING,

- CONDITION DETAILS. 2. UTILITIES MARKED BY DIGGERS HOTLINE AND
- LOCATED BY ALL LINES.
- 3. 4-INCH DIAMETER PAVEMENT CORES WERE COLLECTED AT THE SOIL BORING LOCATIONS IDENTIFIED ON THE PLANS BY GESTRA ENGINEERING, INC. FOLLOWING, A 4-FOOT SUBGRADE SAMPLE WAS COLLECTED BELOW THE CORE SAMPLES. RESULTS ARE PRESENTED IN THE 'DRILLING AND LABORATORY TESTING SUMMARY', DATED OCTOBER 7, 2022.

BENCHMARK NOTES:

- 1. MAIN BENCHMARK: REFERENCE BENCHMARK FOR SECTION CORNER LOCATION: N. OAKLAND AVENUE & E. KENWOOD BLVD. DESCRIPTION: FIRE HYDRANT BEHIND CURB LINE NE. CORNER OF INTERSECTION, TOP OF NOZZLE ELEVATION = 87.03 (CITY OF MILWUAKEE
- 2. SITE BENCHMARK: SEWER MANHOLE LOCATION: IN THE TERRACE, NORTH OF THE SUBJECT PROPERTY, AS SHOWN ON SURVEY DESCRIPTION: MANHOLE RIM ELEVATION =84.97 (CITY OF MILWAUKEE DATUM)



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PROJECT NUMBER: 8176 (DIVISION 2)

SITE NUMBER: 185

100% CD

**DRAWN BY:** 


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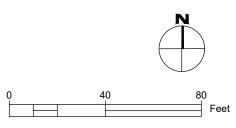
**REVIEWED BY:** 

**APPROVED BY:** 

SEAL AND SIGNATURE

SHEET:



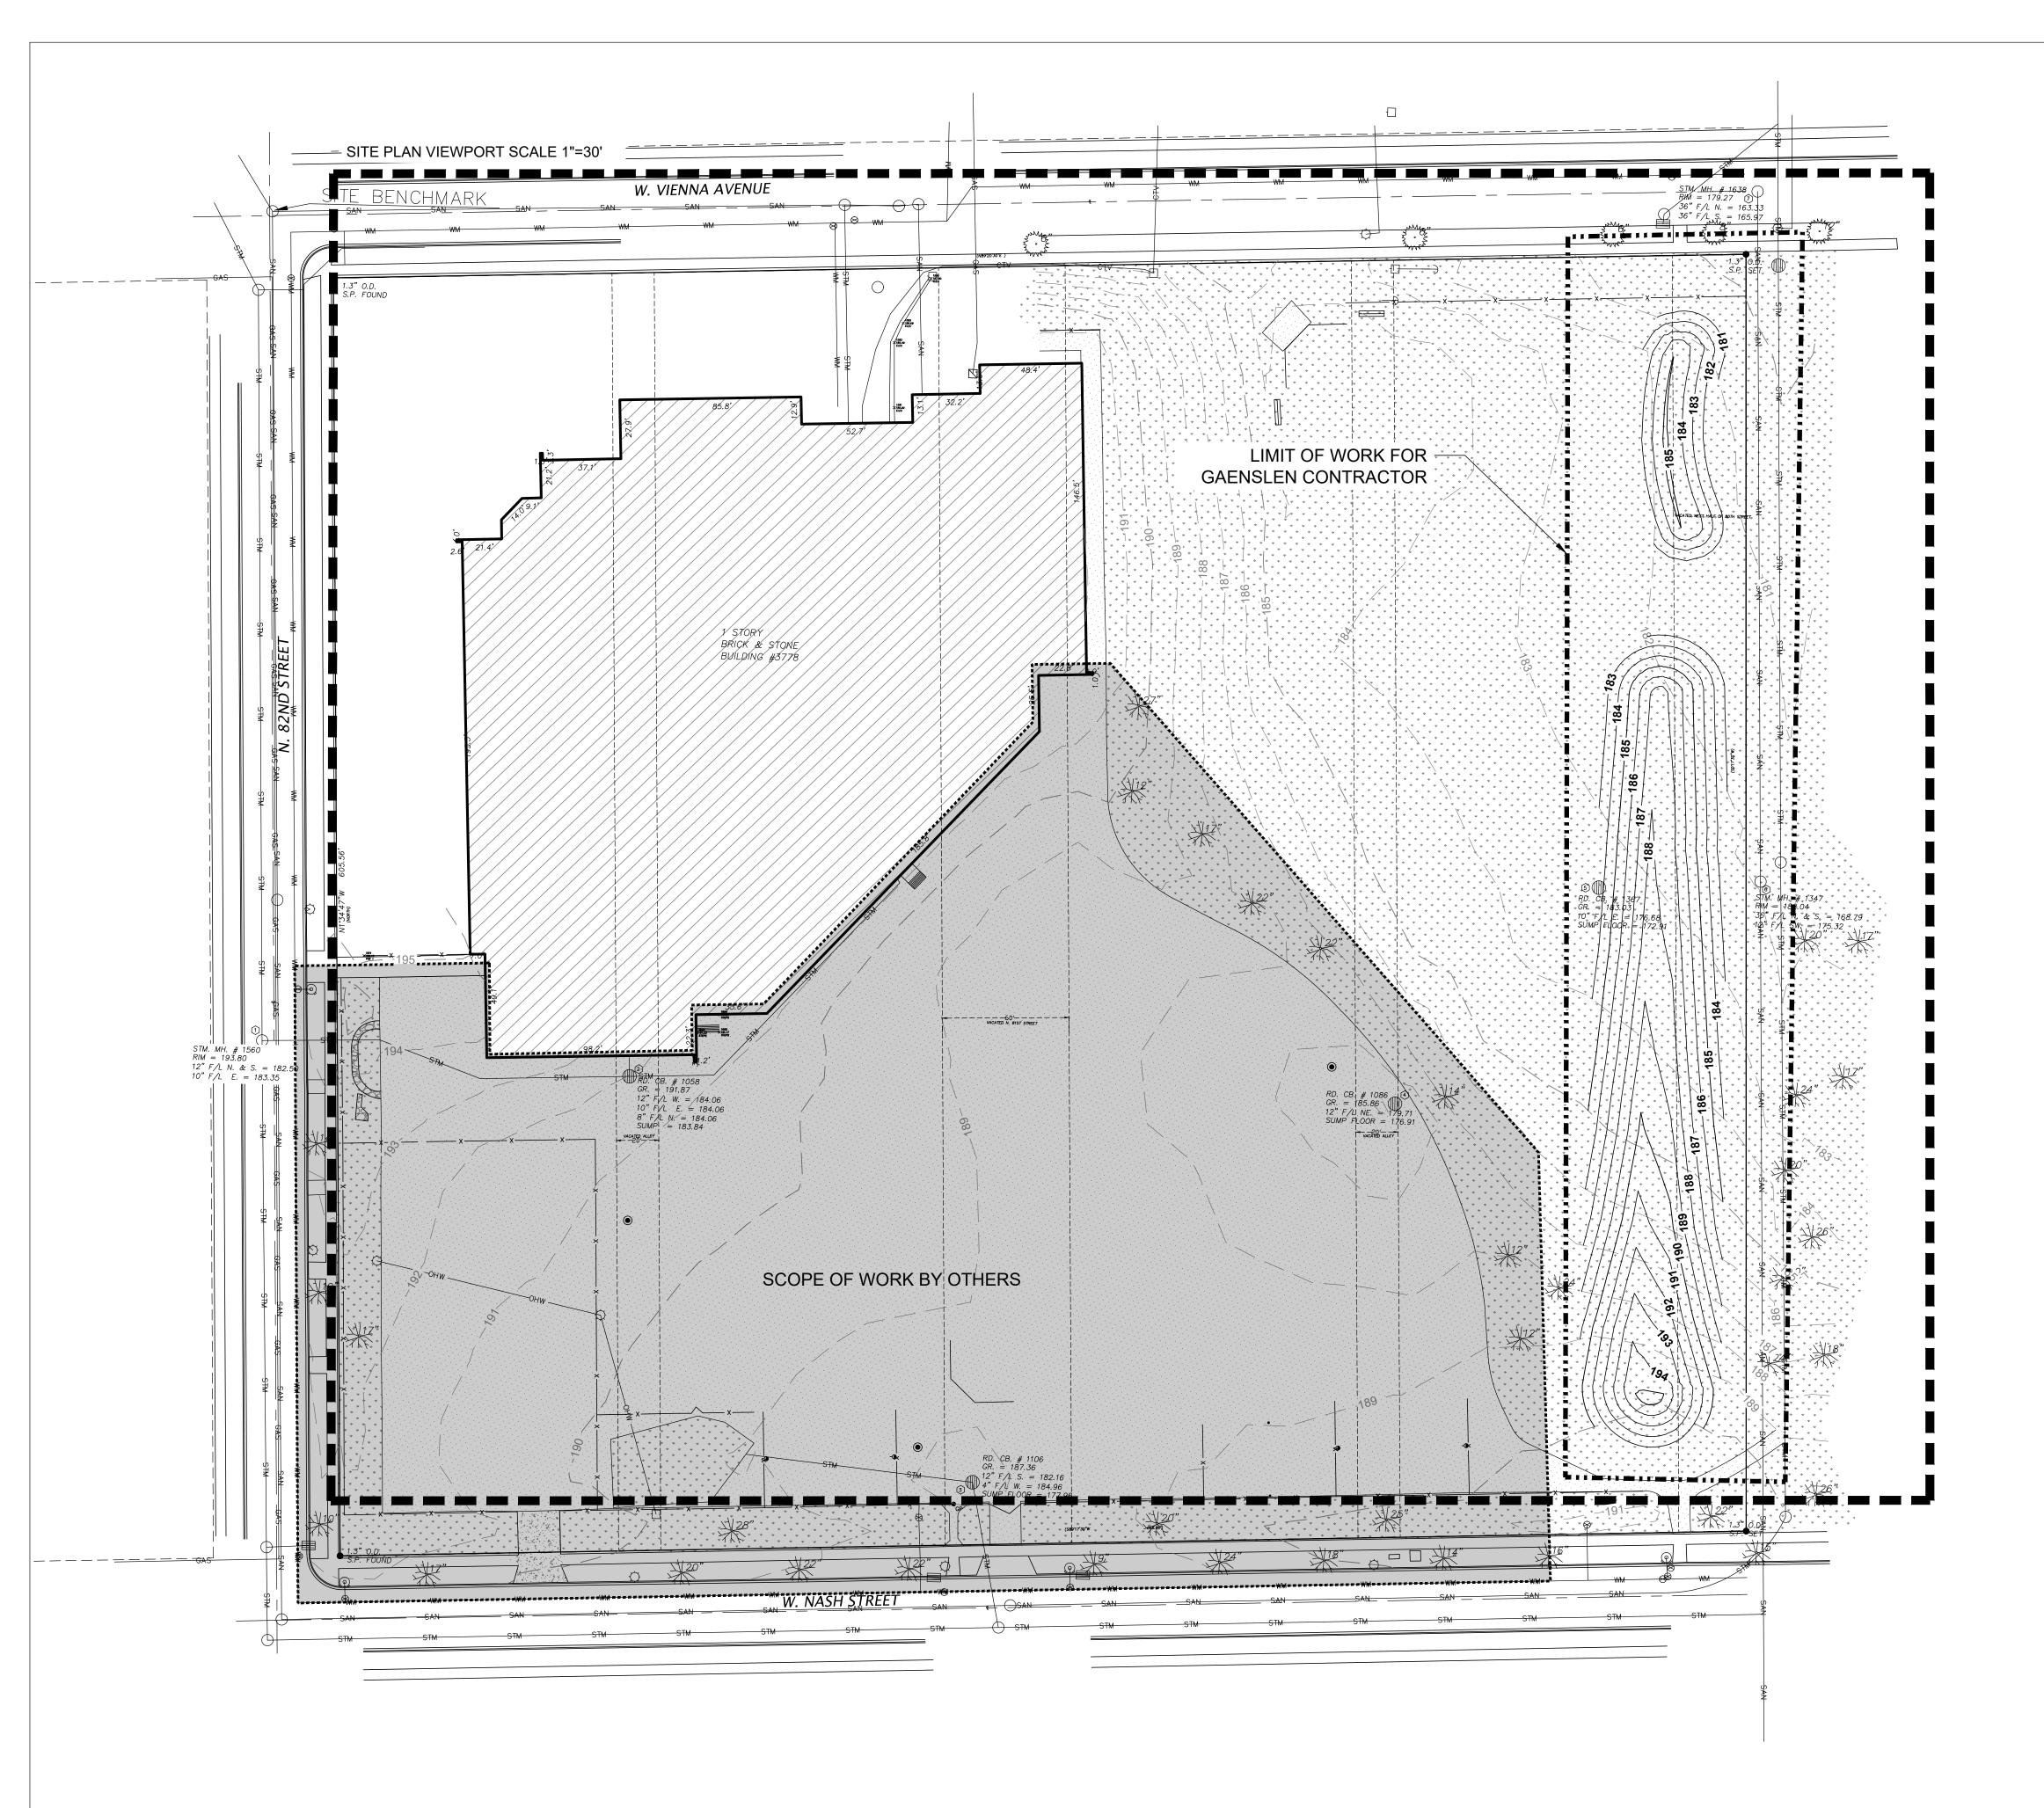

ASPHALT PAVEMENT

STONE

LAWN OR CHIP AREAS

**\* \* \* \*** 

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LEGEND:

CONIFEROUS TREE

DECIDUOUS TREE 💈 ° ,

NSE CONTROL SPOT GRADE

CONCRETE NAIL A
CONCRETE MONUMENT

PROPERTY CORNER • 1.3" O.D. S.P. FOUND

GUARD POST •

YARD LIGHT ☆
STREET LIGHT ☆

ELECTRIC MANHOLE ©

ELECTRIC PEDESTAL ©

ELECTRIC POLE ①

ELECTRIC METER ⊠

GUY ANCHOR →

BASKETBALL HOOP \_

FLOOD LIGHT 🍕

WATER VALVE ⊗

SPRINKLER HEAD °<sub>SH</sub>
FIRE HYDRANT ⊙
SHUTOFF VALVE ⋈
DRILL HOLE ⊙

CATCH BASIN/INLET ( □

MANHOLE (

HANDHOLE HH

GAS VALVE 🛆

GAS METER □

PLAT LINE -----x-x-----

1' CONTOUR MINOR-----

FIBER OPTIC BURIED FO

TELEPHONE BURIED — ATT

OVERHEAD WIRES OHW

SANITARY SEWER SAN

COMBINED SEWER CMB

STORM SEWER STM

WATER SERVICE -----

2. UTILITIES MARKED BY DIGGERS HOTLINE AND

 MAIN BENCHMARK: REFERENCE BENCHMARK FOR SECTION CORNER LOCATION: N. 84TH STREET & W.

CAPITOL DRIVE DESCRIPTION: FIRE HYDRANT

2. SITE BENCHMARK: SANITARY MANHOLE LOCATION: INTERSECTION OF N. 82ND STREET AND W. VIENNA

AVENUE, AS SHOWN ON SURVEY DESCRIPTION: MANHOLE RIM ELEVATION = 189.93 (CITY OF

BEHIND CURB LINE SE. CORNER OF INTERSECTION, TOP OF NOZZLE ELEVATION = 192.02 (CITY OF

1. SURVEY PREPARED BY NORTH SHORE

CATV BURIED — CTV

TELEPHONE MANHOLE 🗇

TELEPHONE PEDESTAL []

CATV PEDESTAL []

**GENERAL NOTES:** 

BENCHMARK NOTES:

ENGINEERING, INC.

MILWAUKEE DATUM)

MILWUKEE DATUM)

LOCATED BY ALL LINES.

SIGN -

 $BUSH \{ \}$ 

STORMWATER SOLUTIONS ENGINEERING LLC

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> CT NAME: SHEET N PROJEC **2023** ( **ISSUED FOR:** DATE: 50% CD 1<u>1/14/2</u>022 90% CD 1<u>2/22/2</u>022 100% CD <u>1/23/2</u>023 **DRAWN BY:** KLK **REVIEWED BY:** CNH **APPROVED BY:** CBG DATE: January 2023 SEAL AND SIGNATURE

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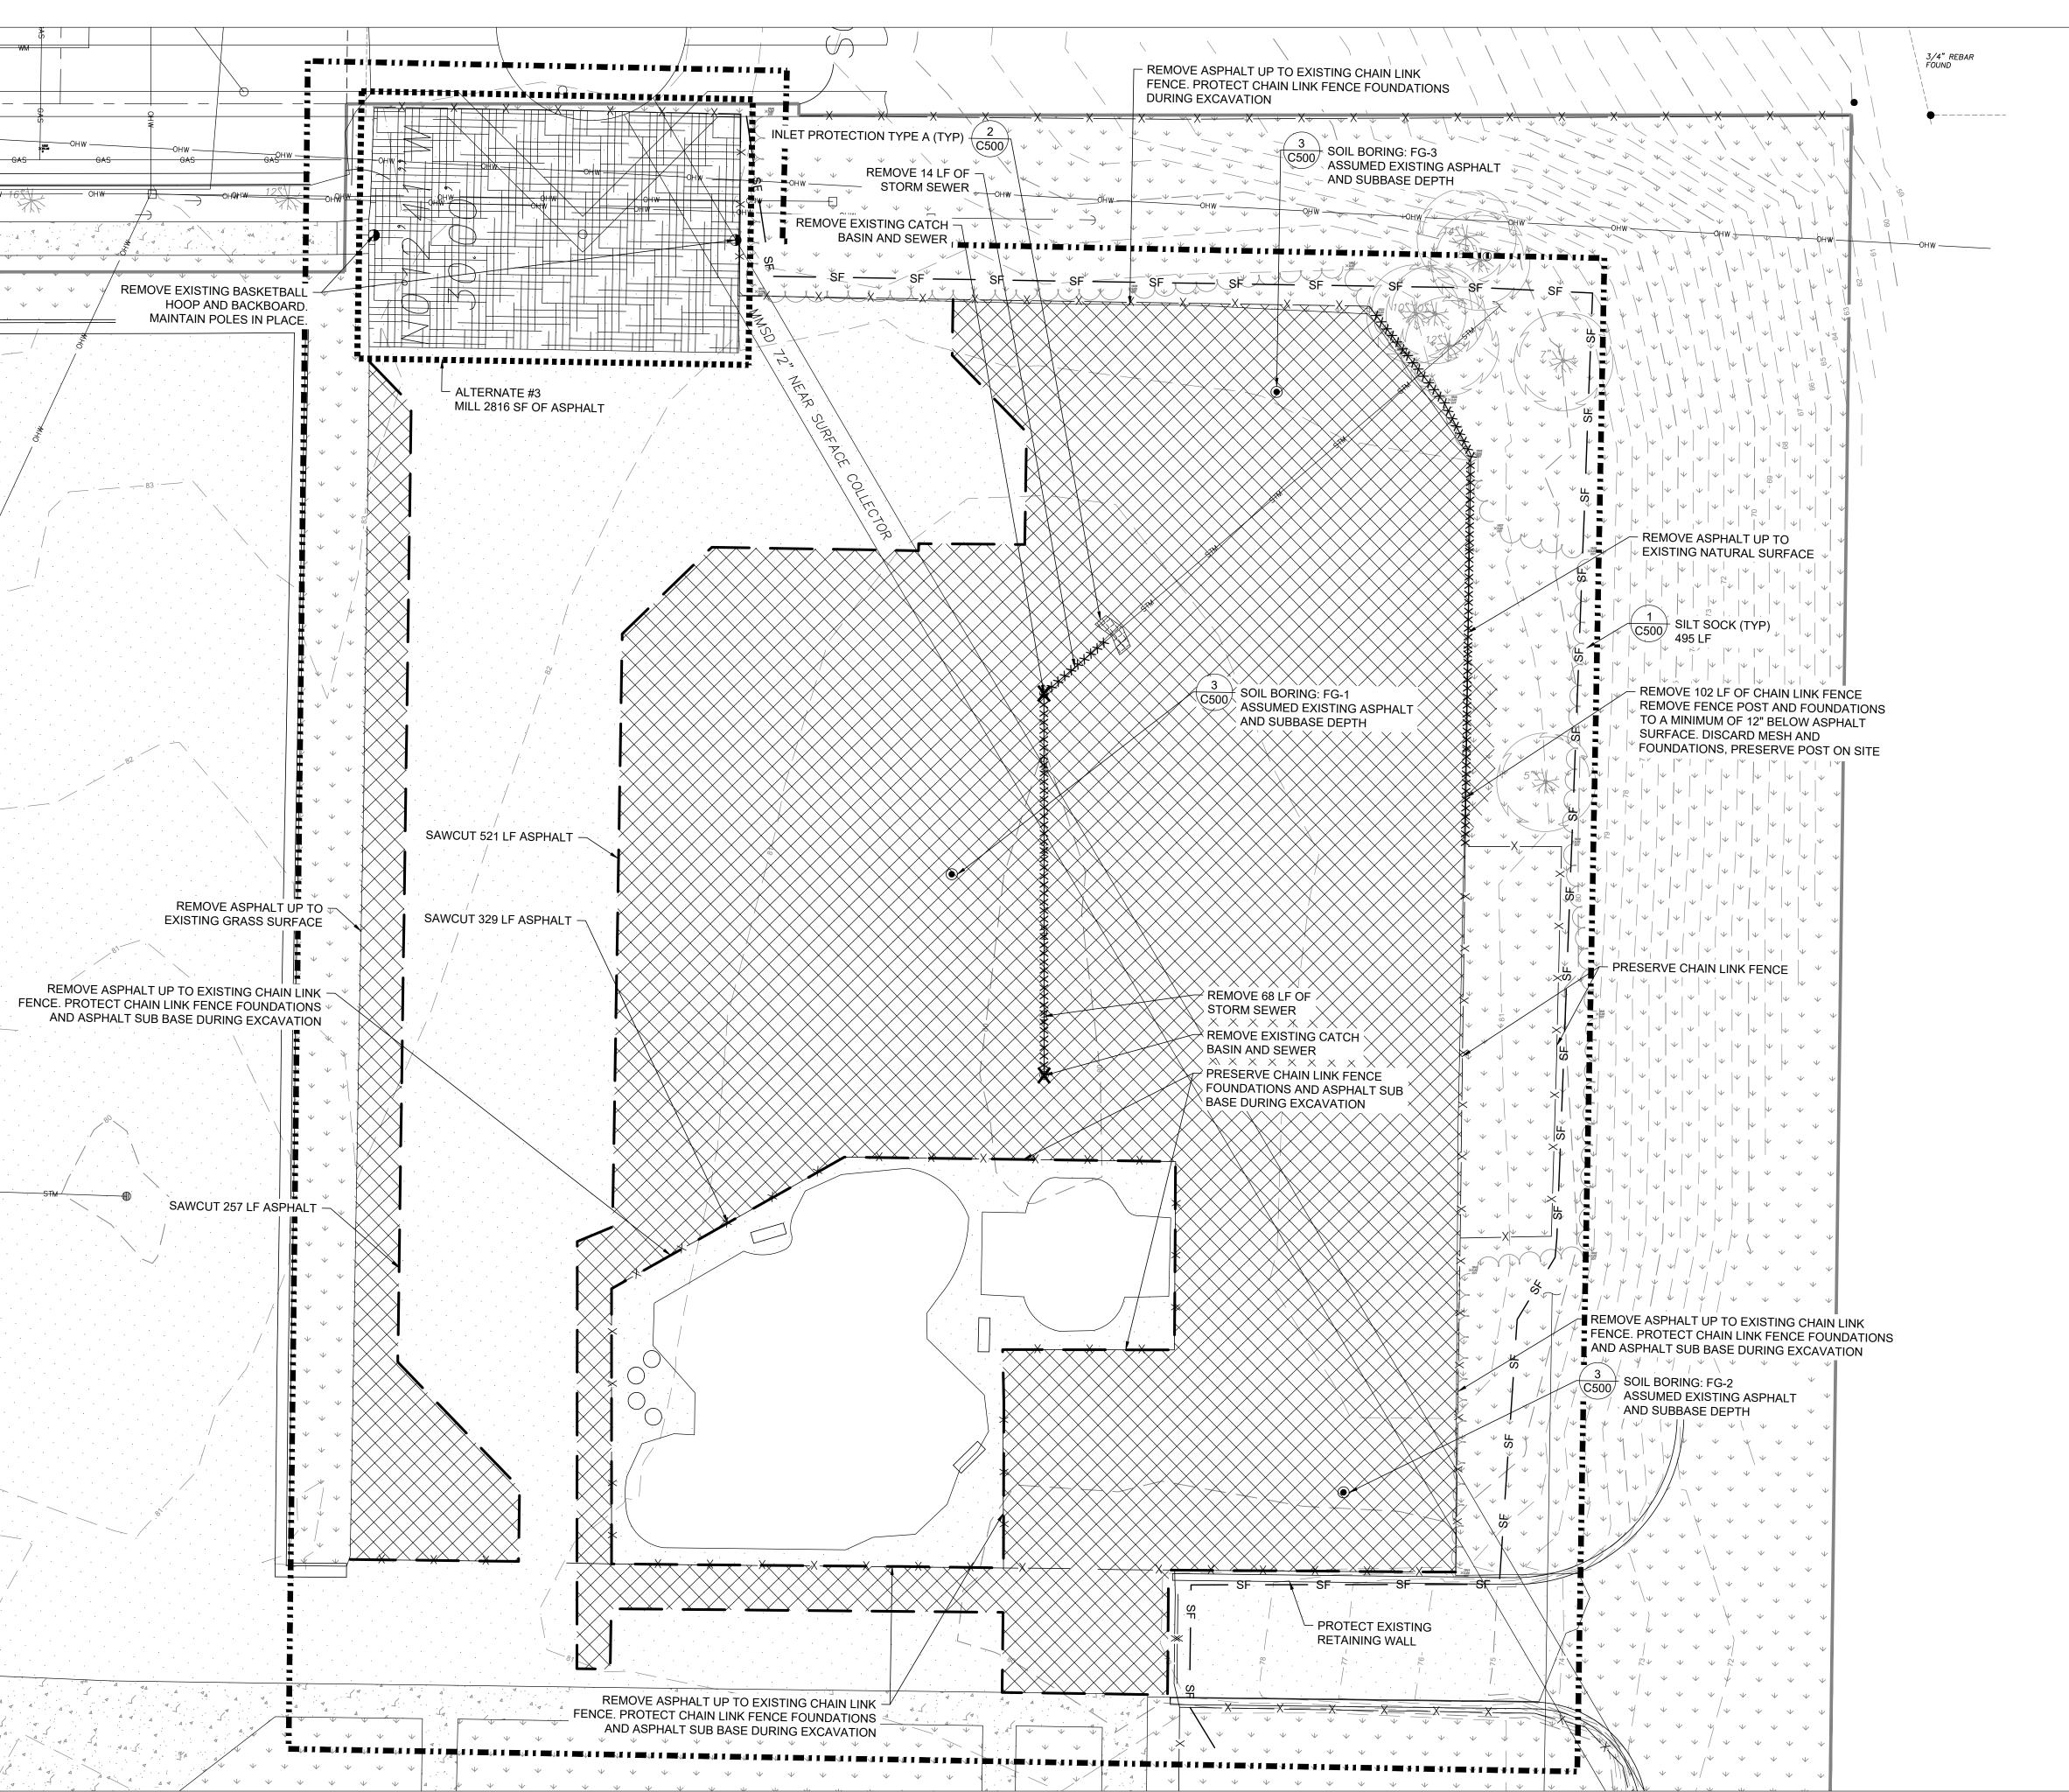
PROJECT NUMBER:

SITE NUMBER:

SHEET:

C002

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OSION CONTROL	
JRE UPGRADES	
8 SCHOOL	

# OR REPLACEMENT. CONTRACTOR TO REPLACE/REPAIR DAMAGED ITEM TO THE SATISFACTION OF THE OWNER'S REPRESENTATIVE AT NO ADDITIONAL COST TO THE OWNER. 7. SURVEY PREPARED BY NORTH SHORE ENGINEERING, LLC. REFER TO PLAT OF SURVEY FOR FULL EXISTING CONDITION

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## GENERAL EROSION CONTROL NOTES

**LEGEND**:

-XXXXXXXXXXX

**GENERAL NOTES:** 

OVER THE WORK.

PROPERTY BOUNDARY

(5' INTERVAL)

(1' INTERVAL)

**EXISTING MAJOR CONTOUR** 

**EXISTING MINOR CONTOUR** 

ASPHALT SAW CUT LINE

ASPHALT REMOVAL

ASPHALT MILLING

REMOVALS (AS NOTED)

REMOVALS (AS NOTED)

SILT SOCK / SILT FENCE

THE CONTRACTOR TO COMPLY WITH ALL APPLICABLE CODES

AND REGULATIONS OF AUTHORITIES HAVING JURISDICTION

DRAWINGS WITH FIELD MEASUREMENTS BEFORE FABRICATION

OR ORDERING OF MATERIALS PRIOR TO COMMENCEMENT OF

ALTERNATE/FUTURE WORK

2. CONTRACTOR TO VERIFY DIMENSIONS INDICATED ON

4. CONTRACTOR TO CONTACT PUBLIC AND PRIVATE

ADDITIONAL COST TO THE OWNER.

ANY DEMOLITION OR CONSTRUCTION. DO NOT SCALE

3. CONTRACTOR TO NOTIFY ENGINEER OF EXISTING CONDITIONS

UNDERGROUND UTILITY LOCATING SERVICES TO HAVE THE SITE MARKED PRIOR TO ANY DIGGING OR EARTHWORK.

5. CONTRACTOR TO REPLACE ANY INSTALLED MATERIAL NOT

MEETING THE SPECIFICATION OR PLAN REQUIREMENTS WITH MATERIAL THAT MEETS THESE REQUIREMENTS WITHOUT

TREES, LAWN AREA, ANY ABOVE GROUND APPARATUSES, OR ANY OTHER ITEM THAT WAS DAMAGED AS A RESULT OF

CONSTRUCTION RELATED ACTIVITIES AS DEEMED BY OWNERS

REPRESENTATIVE THAT WAS NOT CALLED OUT FOR REMOVAL

DIFFERING FROM THOSE INDICATED ON THE DRAWINGS.

6. CONTRACTOR TO REPLACE PAVEMENT, CURB AND GUTTER,

LIMIT OF WORK

INLET PROTECTION TYPE A

INLET PROTECTION TYPES B AND C

- 1. CONSTRUCTION SITE EROSION CONTROL AND SEDIMENTATION CONTROL TO COMPLY WITH THE REQUIREMENTS OF THE CITY OF MILWAUKEE. CONTRACTOR TO EMPLOY EROSION CONTROL METHODS AS SHOWN AND SPECIFIED.
- 2. TEMPORARY EROSION CONTROL DEVICES TO BE INSTALLED PRIOR TO LAND DISTURBANCE ACTIVITIES.
- 3. CONTRACTOR TO CONDUCT ALL ACTIVITIES ON THE SITE IN A LOGICAL SEQUENCE TO MINIMIZE THE AREA OF UNSTABILIZED SOIL AT ANY ONE TIME.
- 4. EROSION CONTROL MEASURES TO REMAIN IN PLACE AND BE MAINTAINED UNTIL SUCH TIME WHEN CONSTRUCTION HAS BEEN COMPLETED AND FINAL STABILIZATION HAS BEEN ESTABLISHED.
- CONTRACTOR TO PERFORM PERIODIC STREET, PLAYGROUND, AND PARKING LOT SWEEPING TO MAINTAIN THE PUBLIC STREET FREE OF DUST AND SOIL.
- 6. ALL DISTURBED GROUND LEFT INACTIVE FOR SEVEN OR MORE DAYS TO BE STABILIZED BY TEMPORARY OR PERMANENT SEEDING, MULCHING, SODDING, COVERING WITH TARPS, OR EQUIVALENT BEST MANAGEMENT PRACTICES. IF TEMPORARY SEEDING IS USED, CONTRACTOR TO INSTALL A PERMANENT COVER AS PART OF THE FINAL SITE STABILIZATION.
- 7. CONTRACTOR TO NOTIFY PERMITTING AGENCIES IN ACCORDANCE WITH PERMIT REQUIREMENTS.
- 8. CONTRACTOR TO REPAIR ANY SILTATION OR EROSION DAMAGE TO ADJOINING SURFACES AND DRAINAGE WAYS RESULTING FROM LAND DEVELOPMENT OR LAND DISTURBING ACTIVITIES.
- 9. KEEP A COPY OF THE EROSION CONTROL PLAN ON SITE FOR THE DURATION OF THE PROJECT.



PROJECT NUMBER: 8176 (DIVISION 2)

SITE NUMBER: 185

SHEET SITE

50% CD

90% CD

**DRAWN BY:** 

DATE:

**REVIEWED BY:** 

**APPROVED BY:** 

**SEAL AND SIGNATURE** 

ISSUED FOR:

1<u>1/14/2</u>022

<u>1/23/2</u>023

**EMP** 

KLK


CBG

January 2023

SHEET:

C003

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**DIVISION OF FACILITIES AND** MAINTENANCE SERVICES

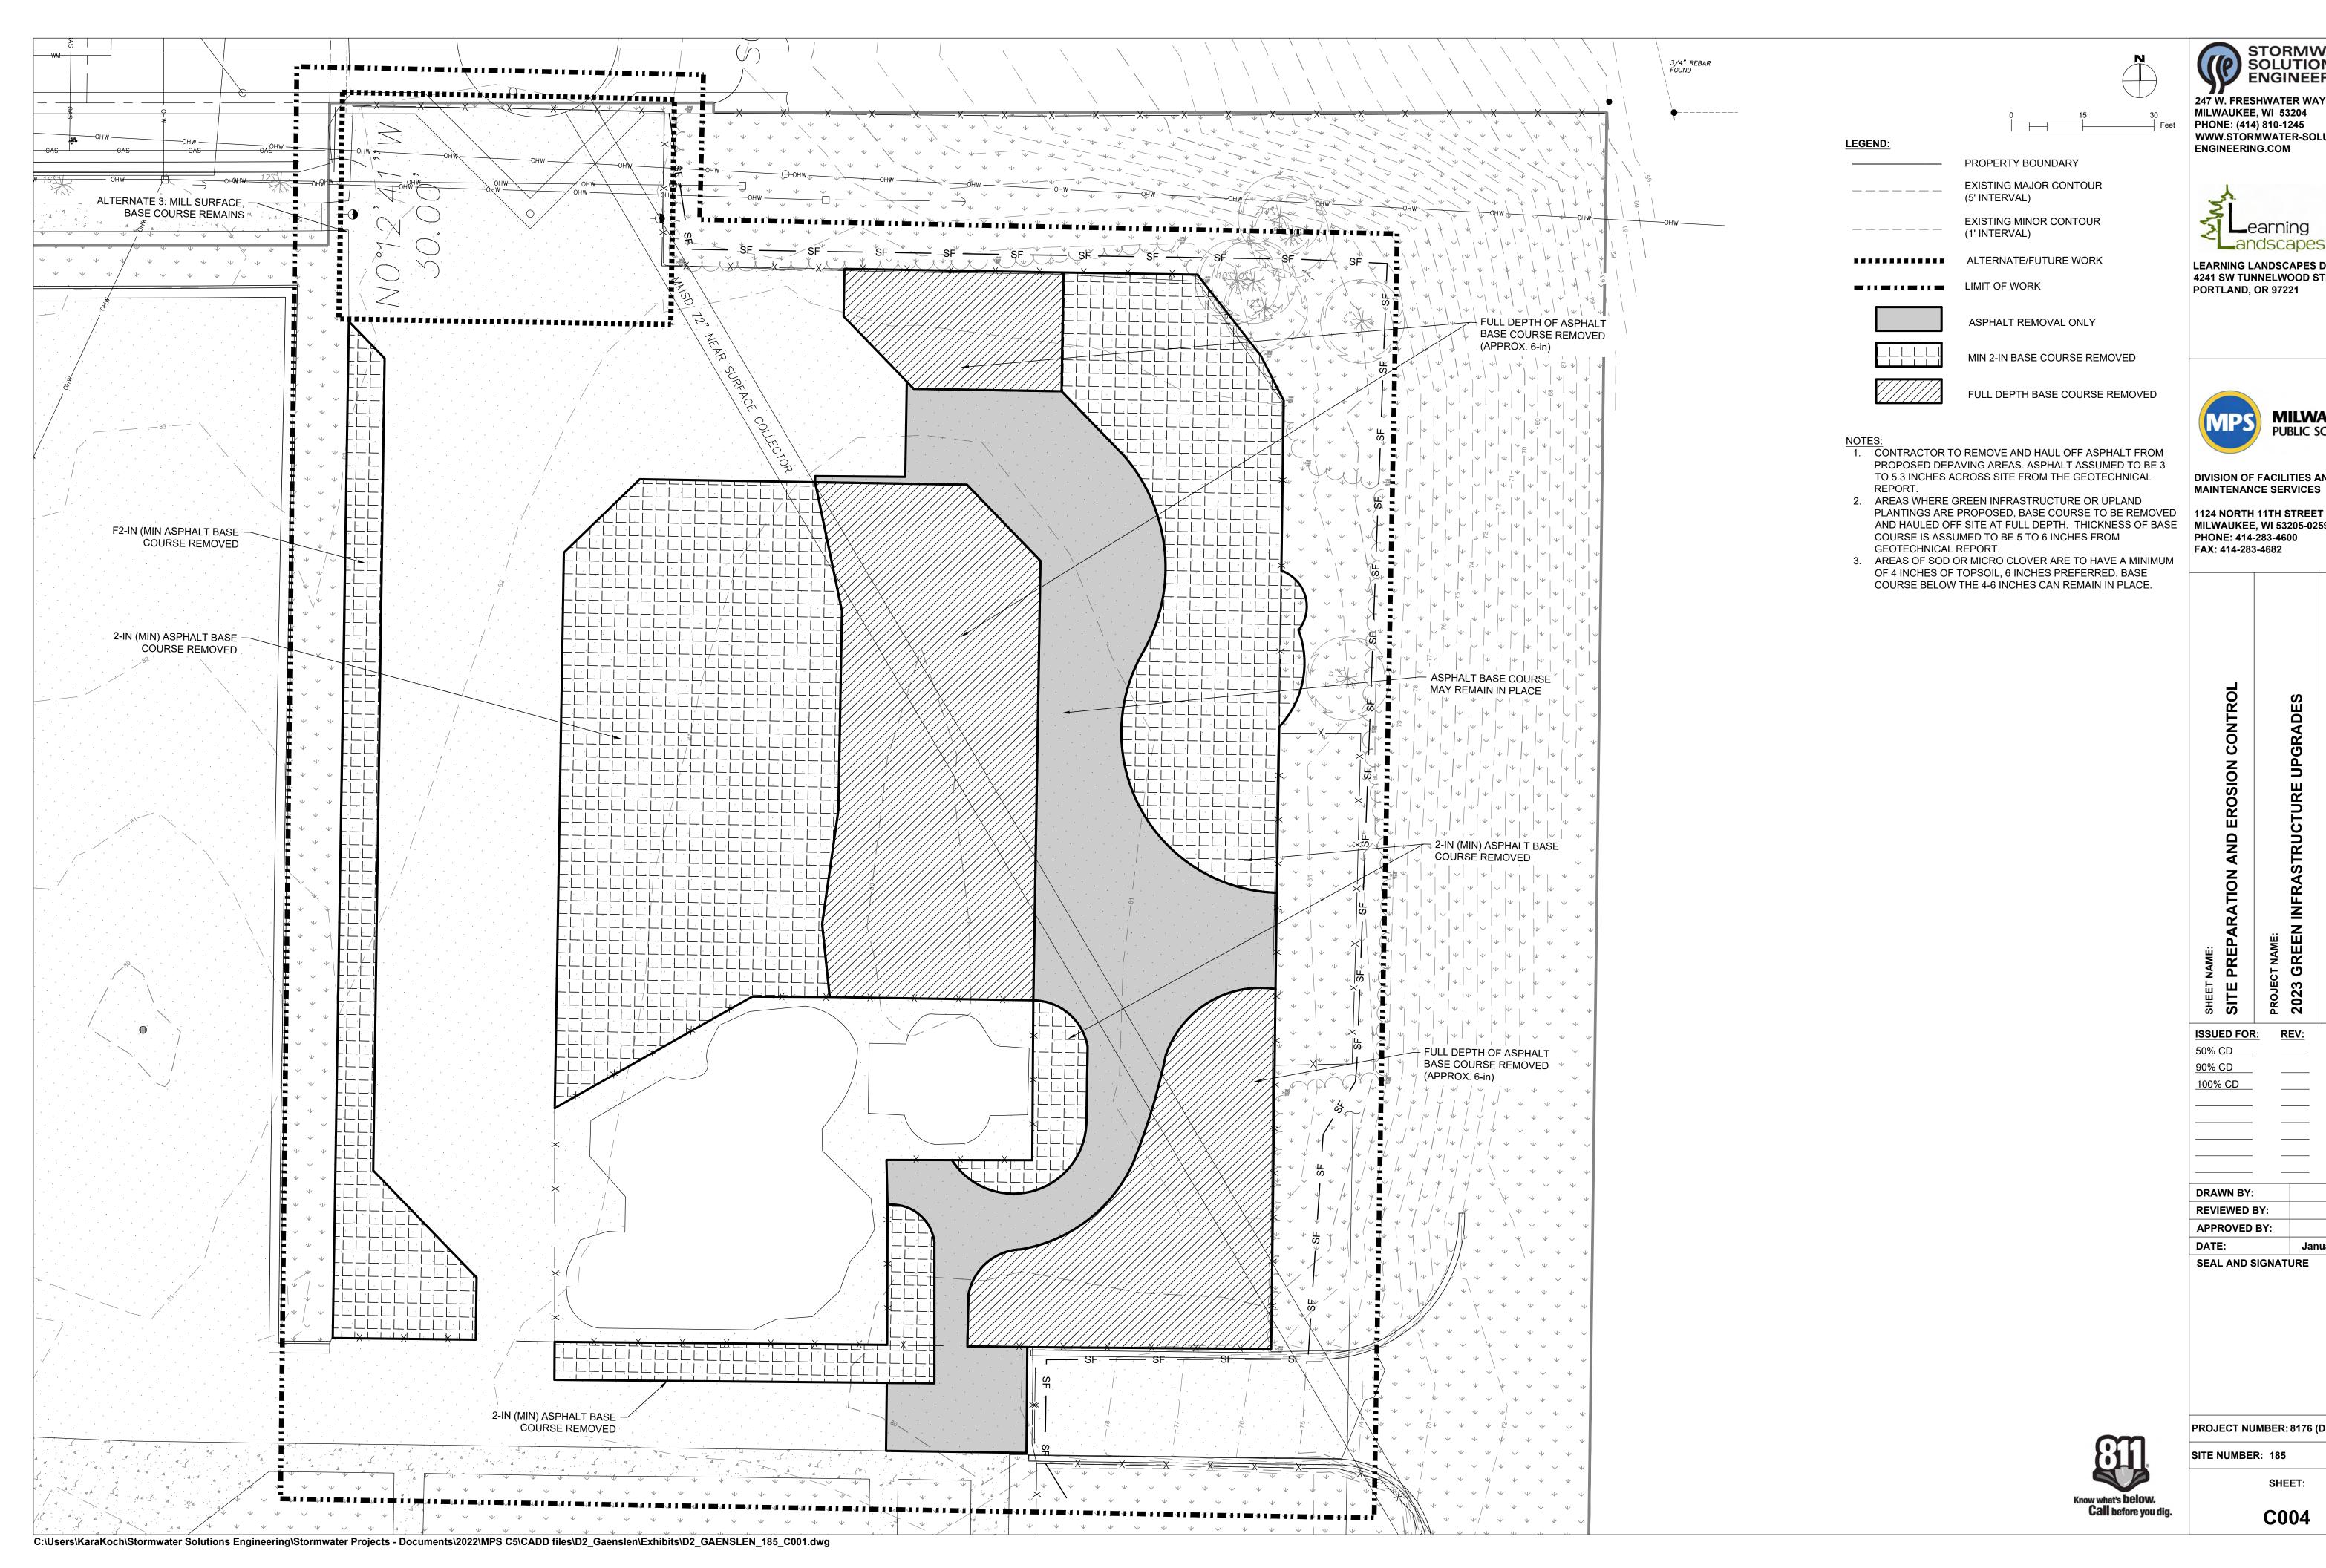MILWAUKEE, WI 53205-0259 PHONE: 414-283-4600 FAX: 414-283-4682

SHEET NAME: SITE PREPARATION AND EROSION CONTRO	PROJECT NAME: 2023 GREEN INFRASTRUCTURE UPGRADES	PROJECT ADDRESS: FREDERICK J GAENSLEN K-8 SCHOOL 1250 E. BURLEIGH STREET, MILWAUKEE, WI
ISSUED FOR	R: REV:	DATE:
50% CD		1 <u>1/14/2</u> 022
90% CD		1 <u>2/22/2</u> 022
100% CD		<u>1/23/2</u> 023

**EMP** 

KLK

CBG

January 2023

PROJECT NUMBER: 8176 (DIVISION 2)

SITE NUMBER: 185

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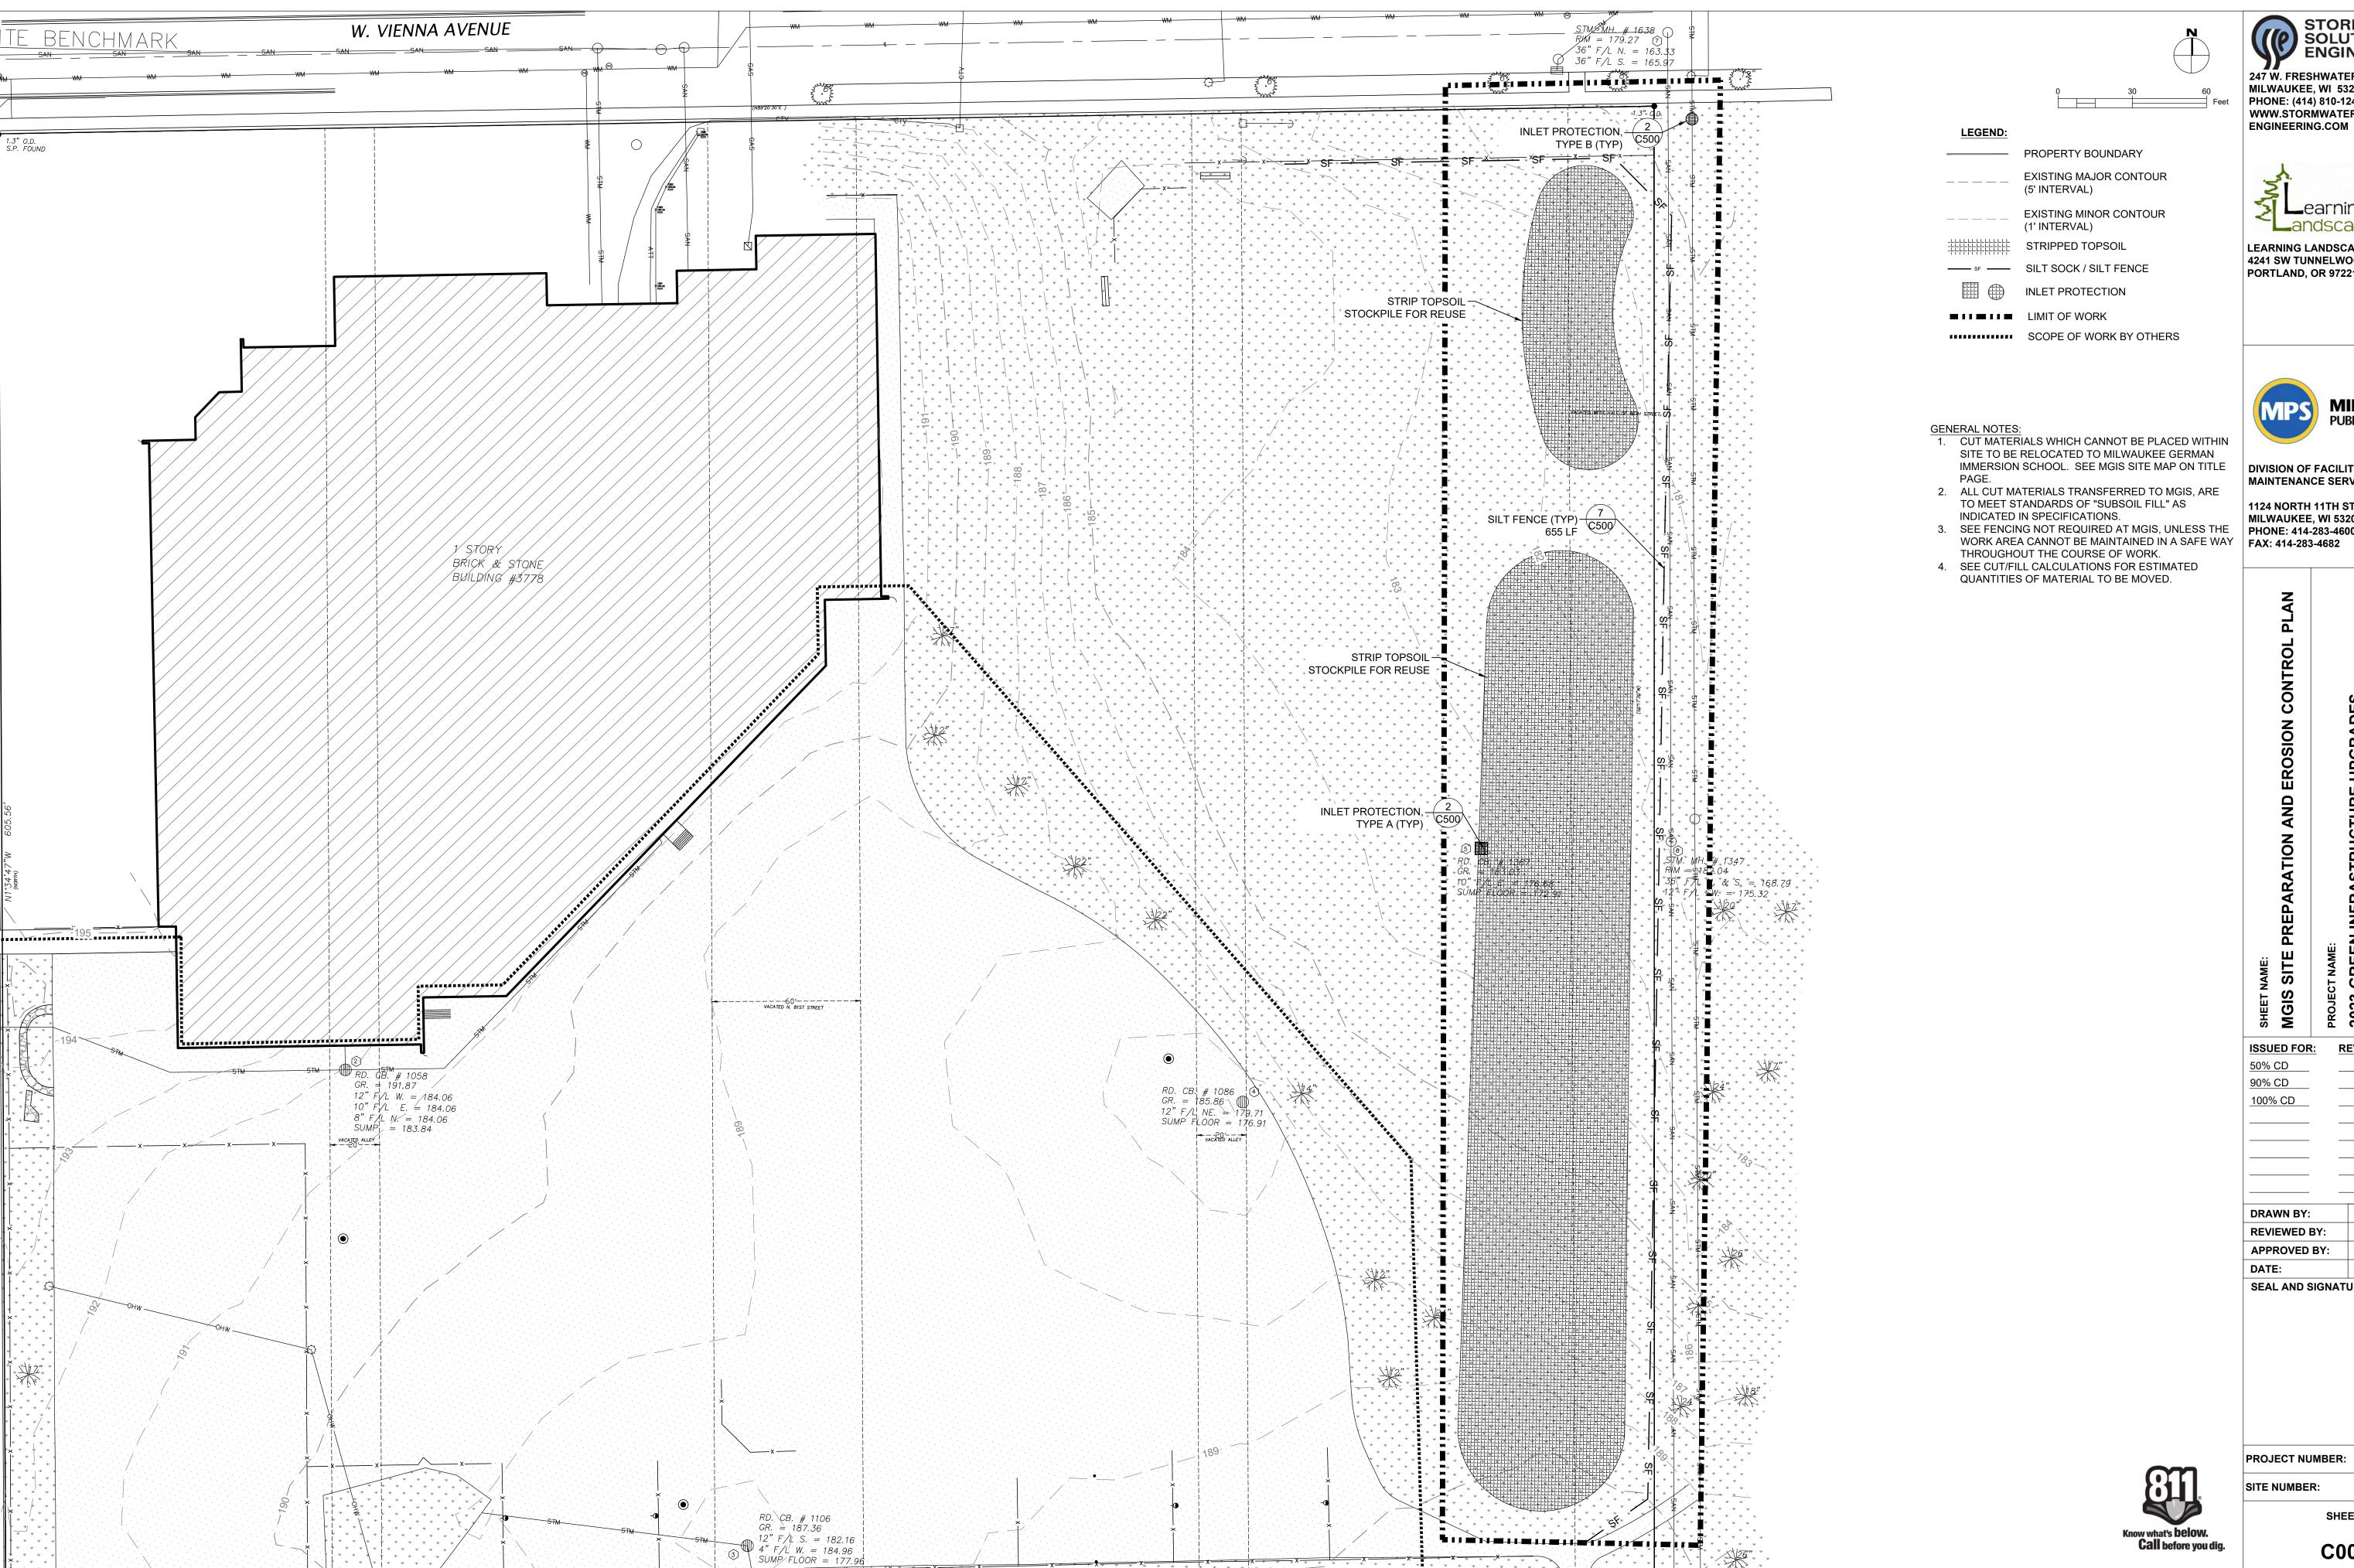
DATE:

**REVIEWED BY:** 

**APPROVED BY:** 

SEAL AND SIGNATURE

SHEET:



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1124 NORTH 11TH STREET

MILWAUKEE, WI 53205-0259 PHONE: 414-283-4600 FAX: 414-283-4682

> PROJECT NAME: 2023 GREEN I 1<u>1/14/2</u>022

> > KLK


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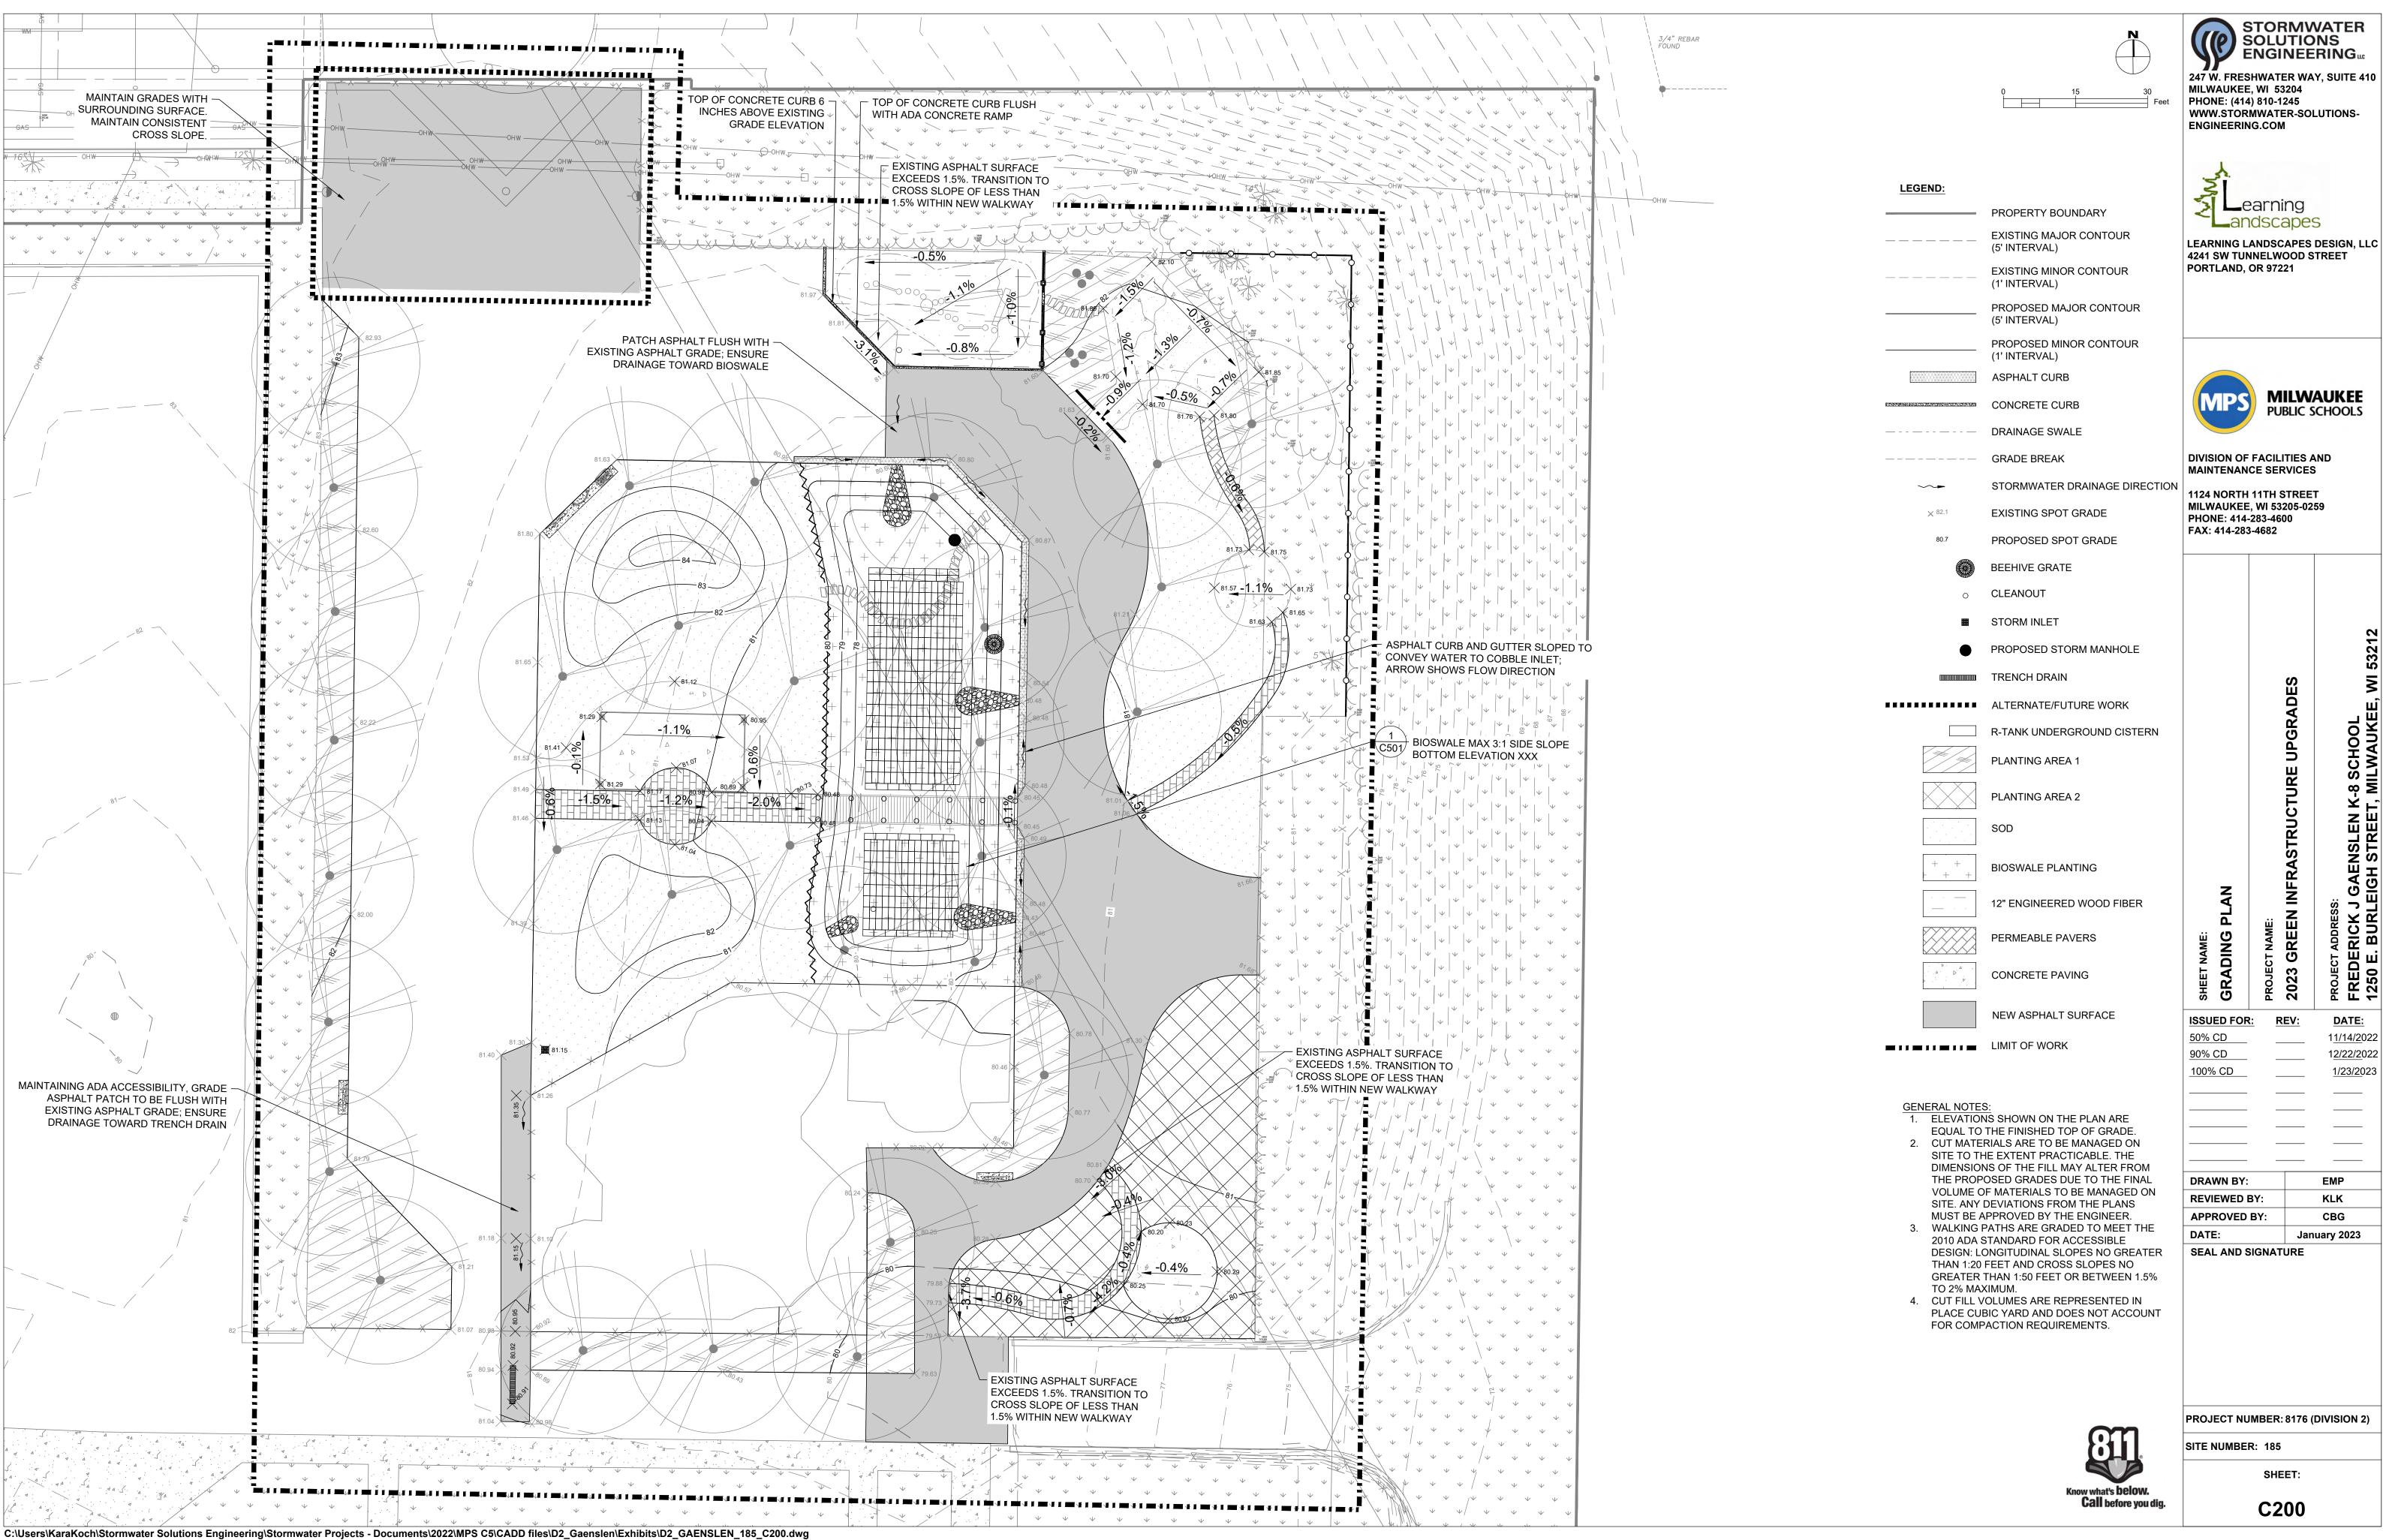
CBG **APPROVED BY:** January 2023 SEAL AND SIGNATURE

PROJECT NUMBER:


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1<u>1/14/2</u>022 1<u>2/22/2</u>022




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1<u>1/14/2</u>022

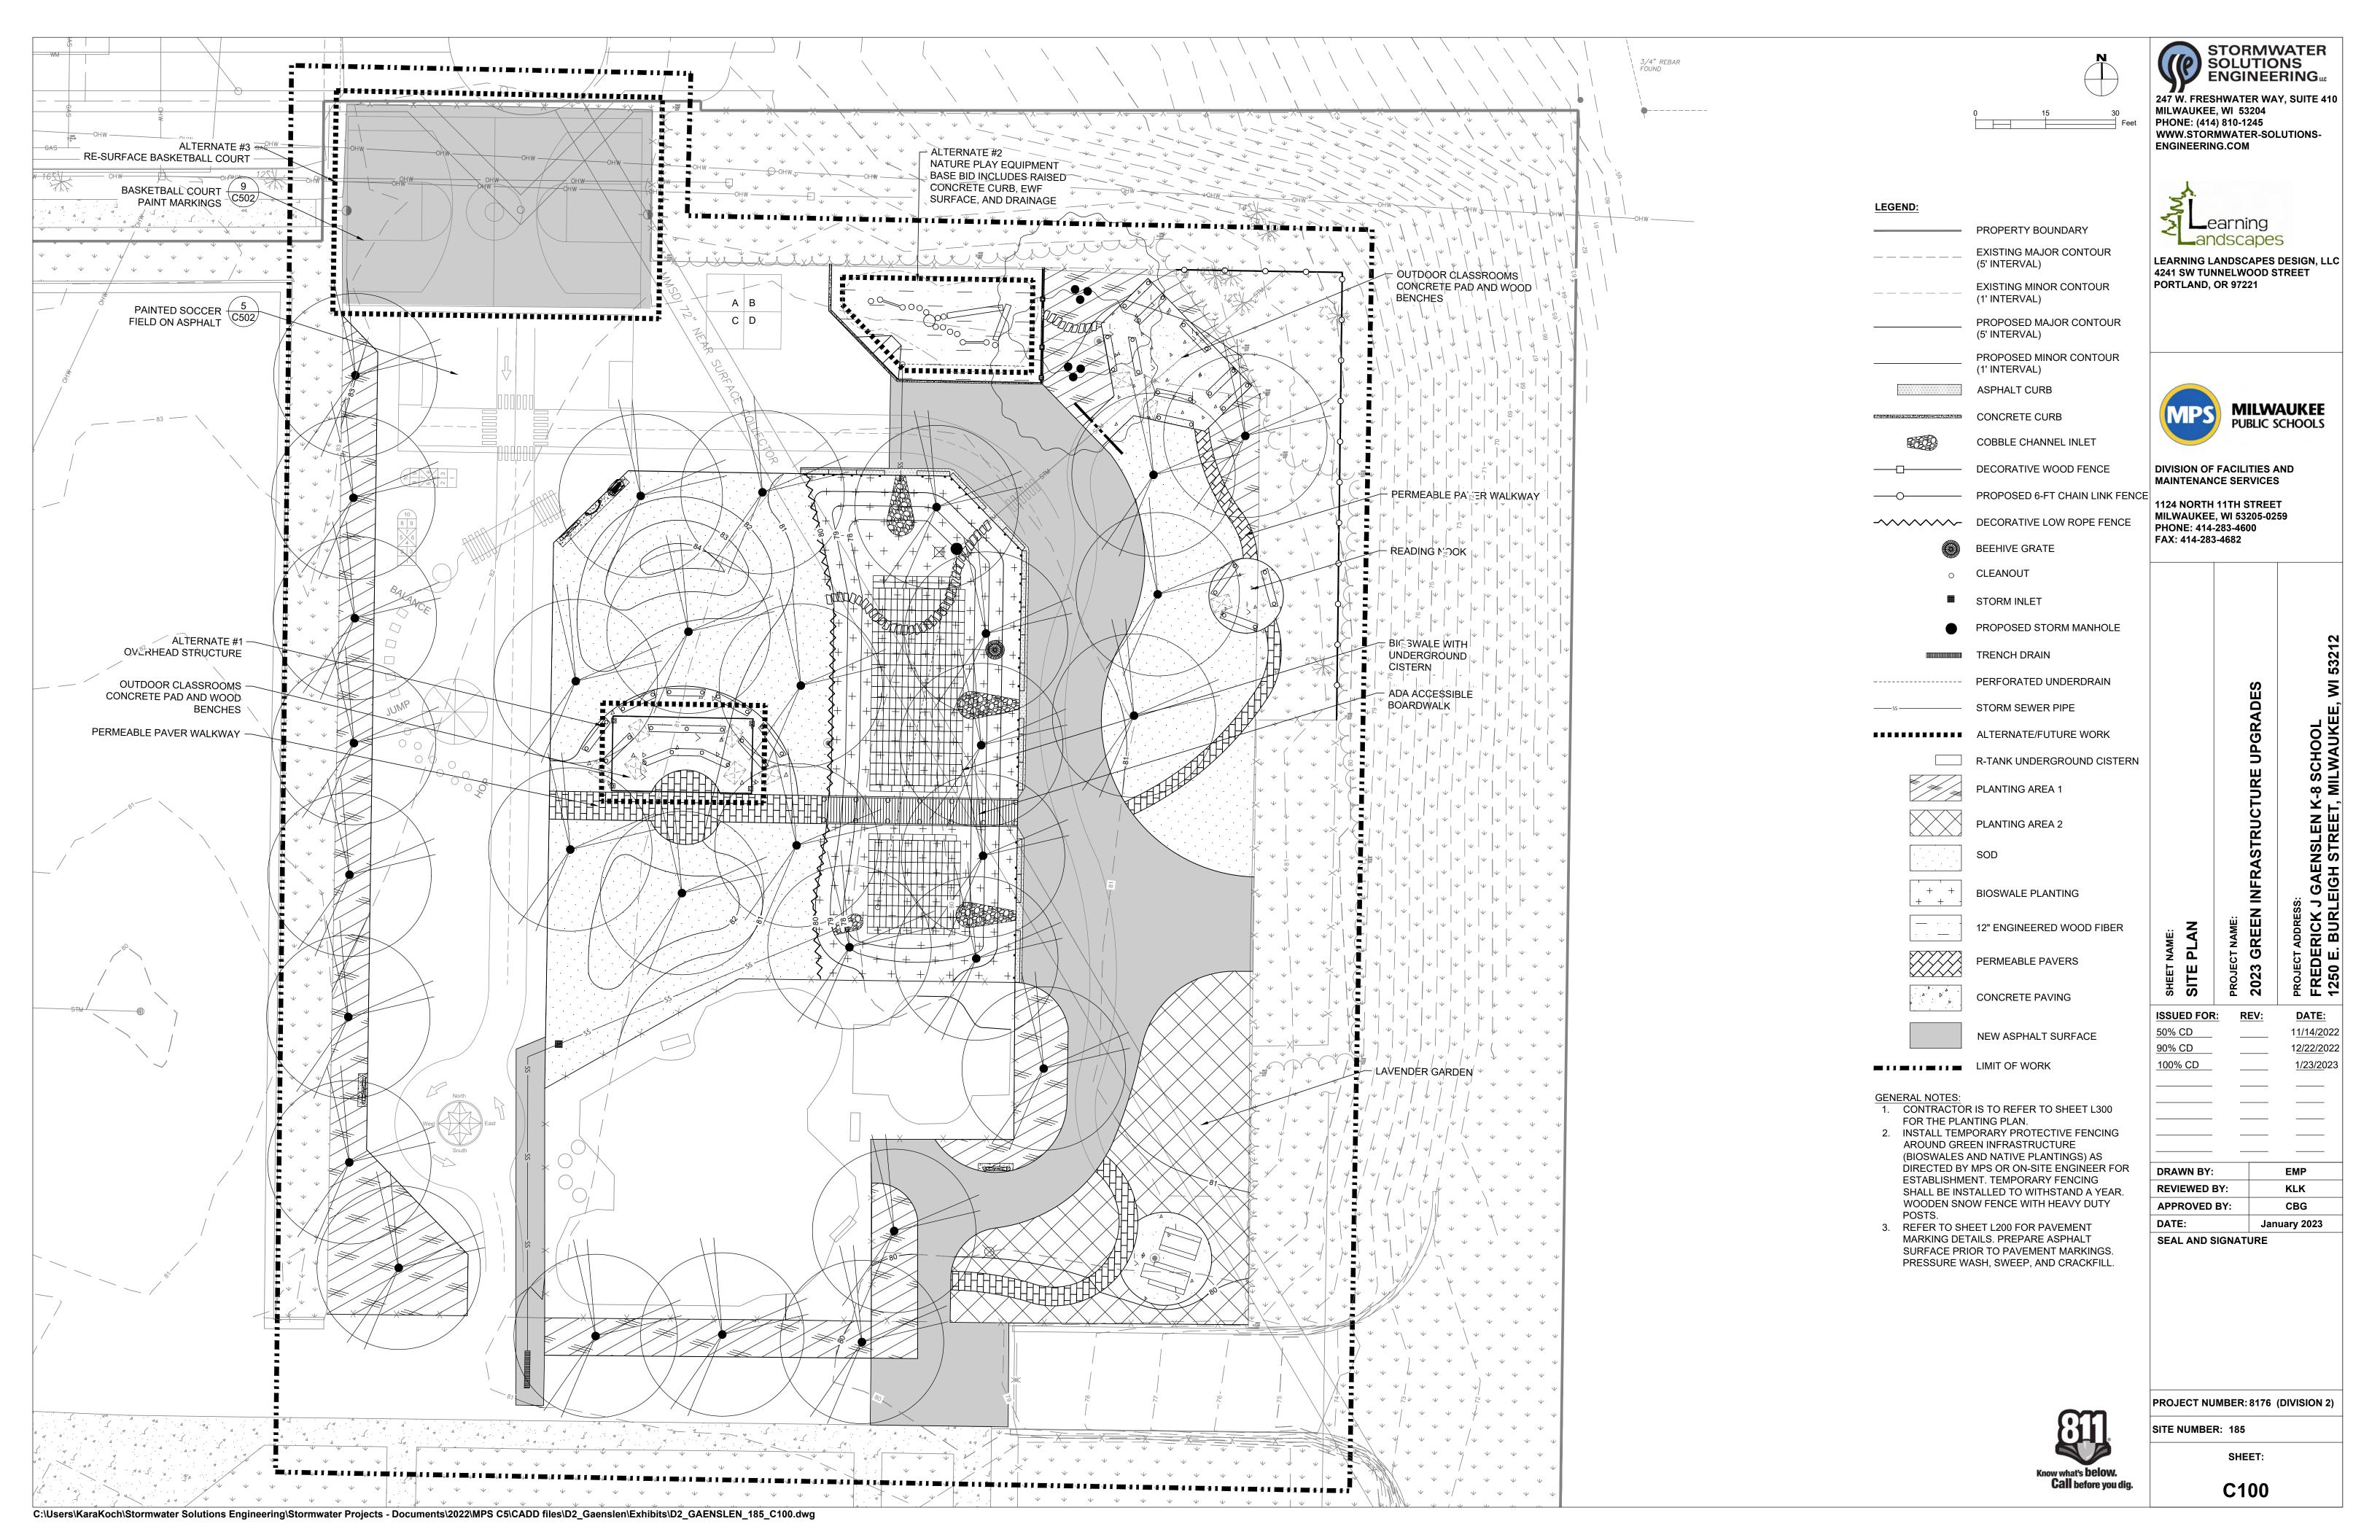DRAWN BY:	KLK	
REVIEWED BY:	CNH	
APPROVED BY:	CBG	
DATE:	January 2023	
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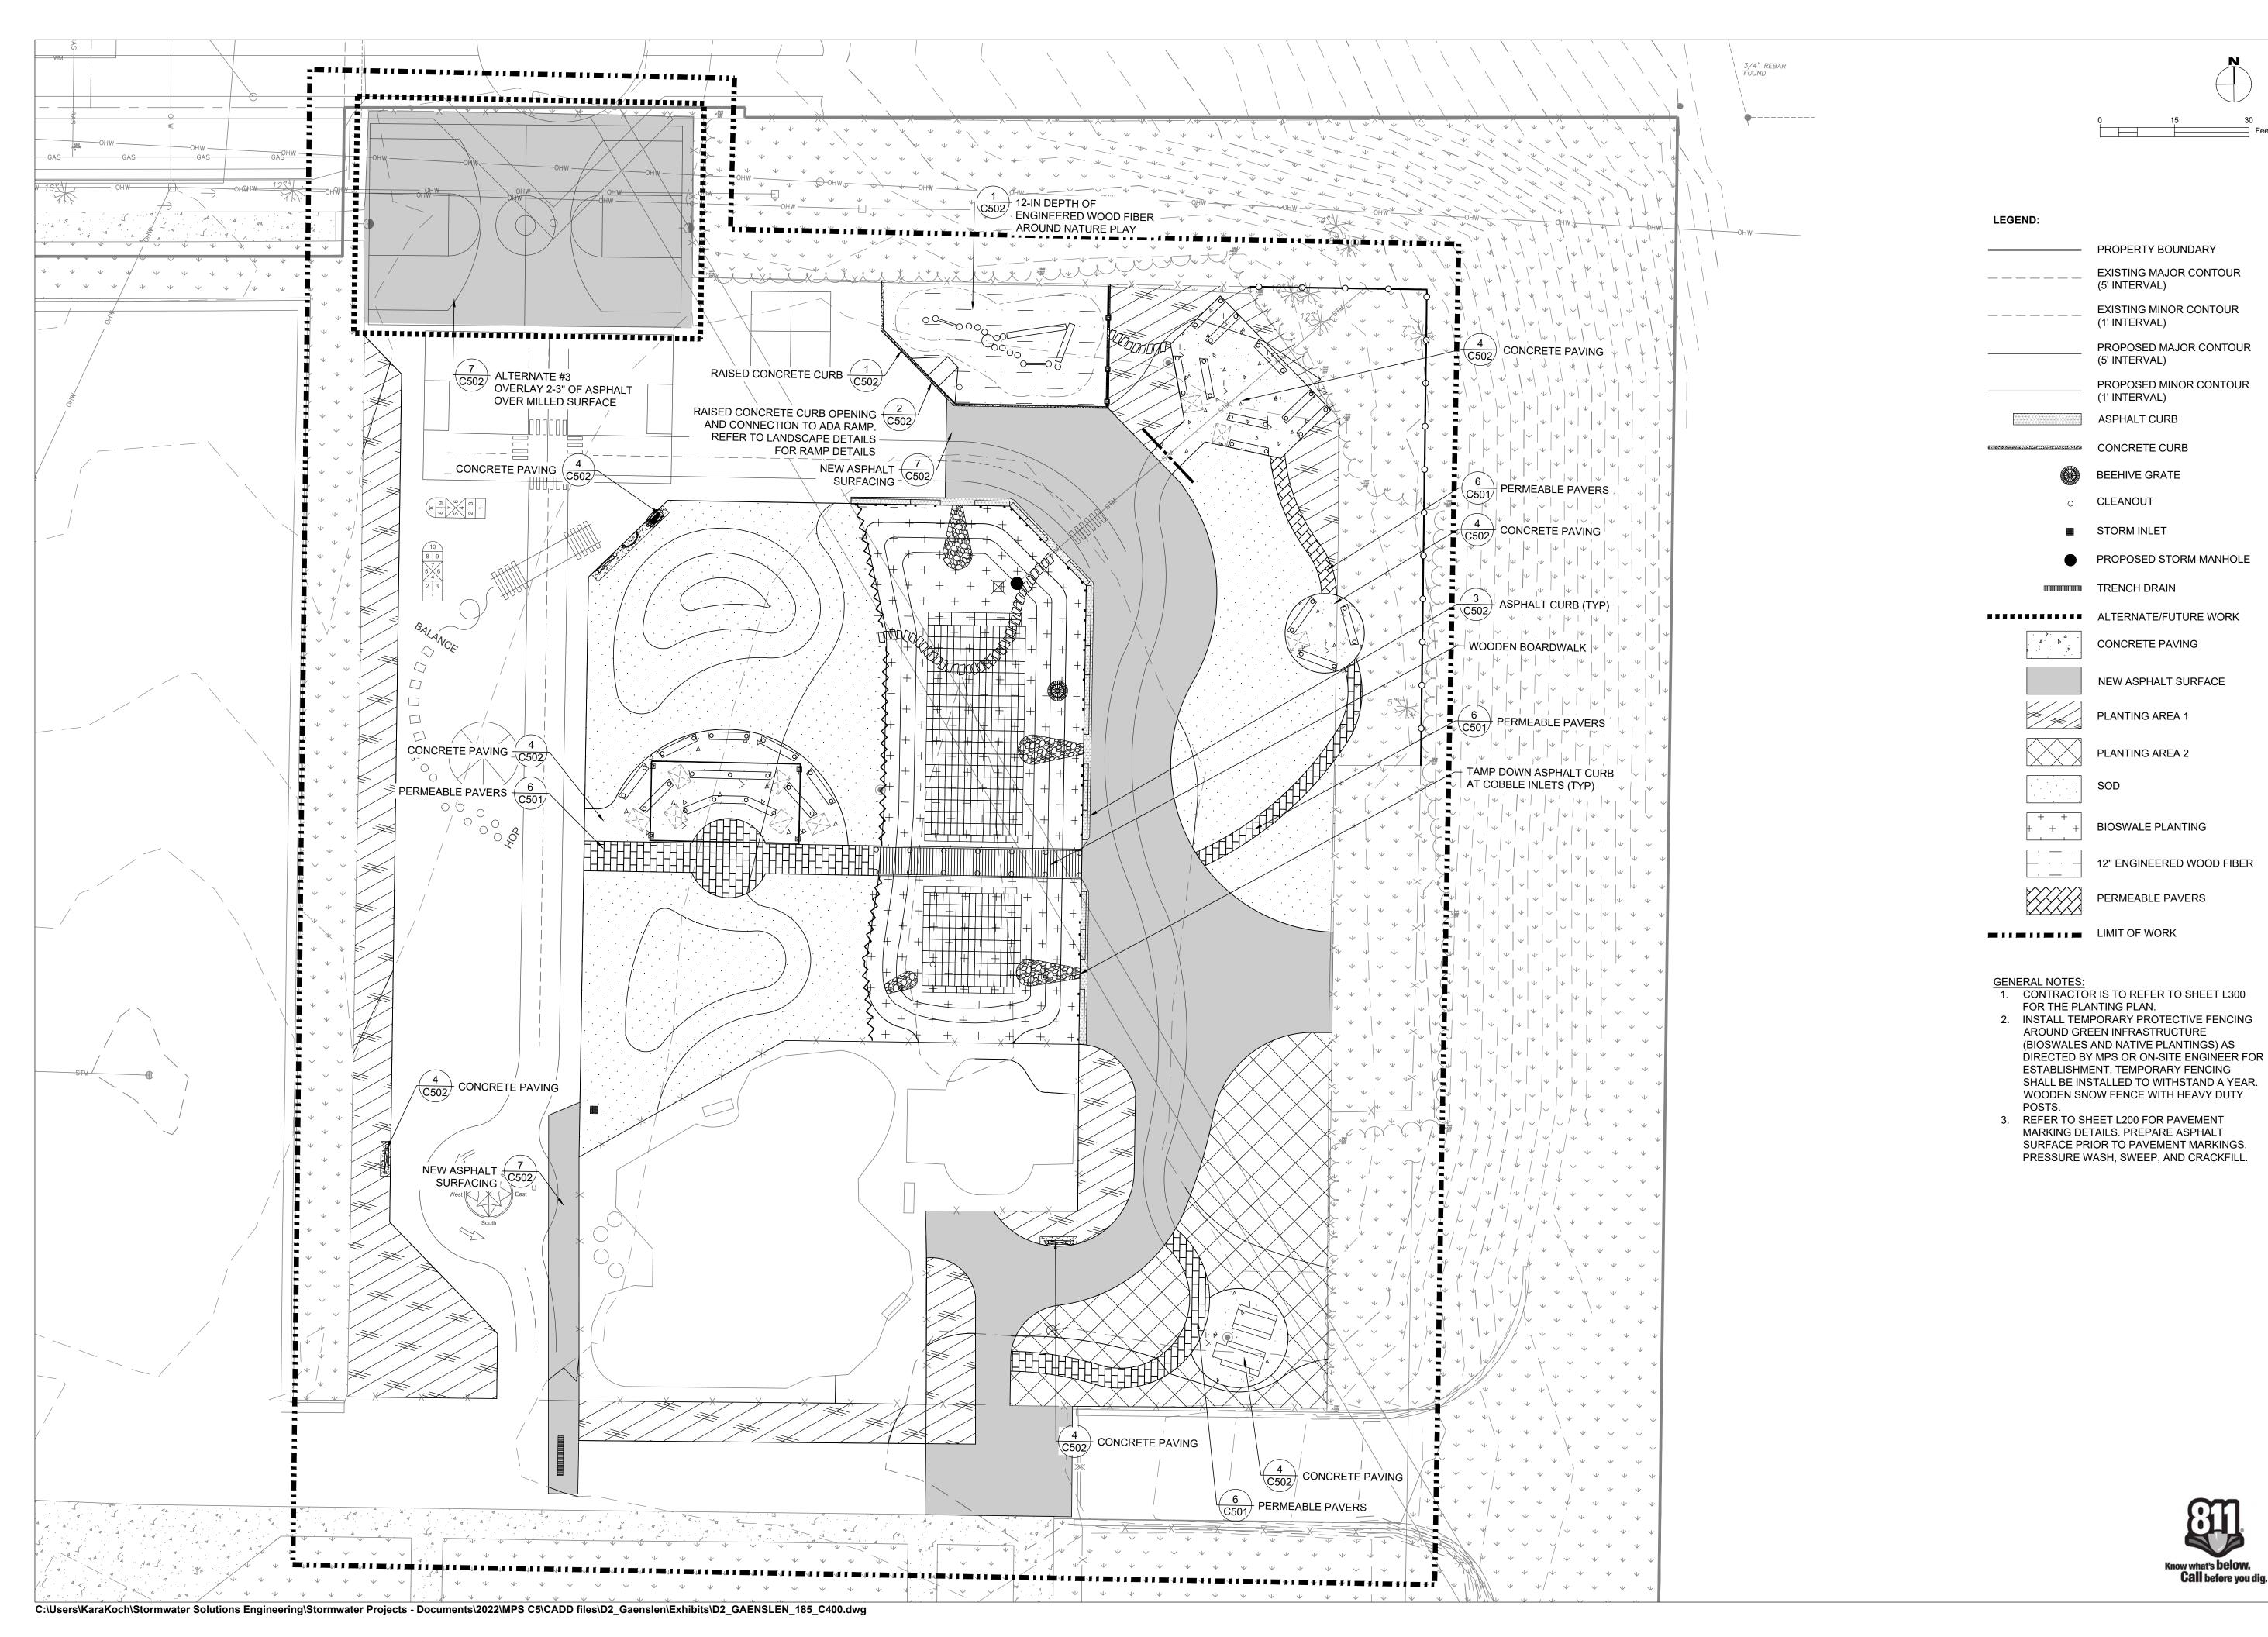



PROJECT NAME:		PROJECT ADDRESS: FREDERICK J GAENSLEN K-8 SCHOOL 1250 E. BURLEIGH STREET, MILWAUKEE, WI 53212
<u>R:</u>	REV:	DATE:

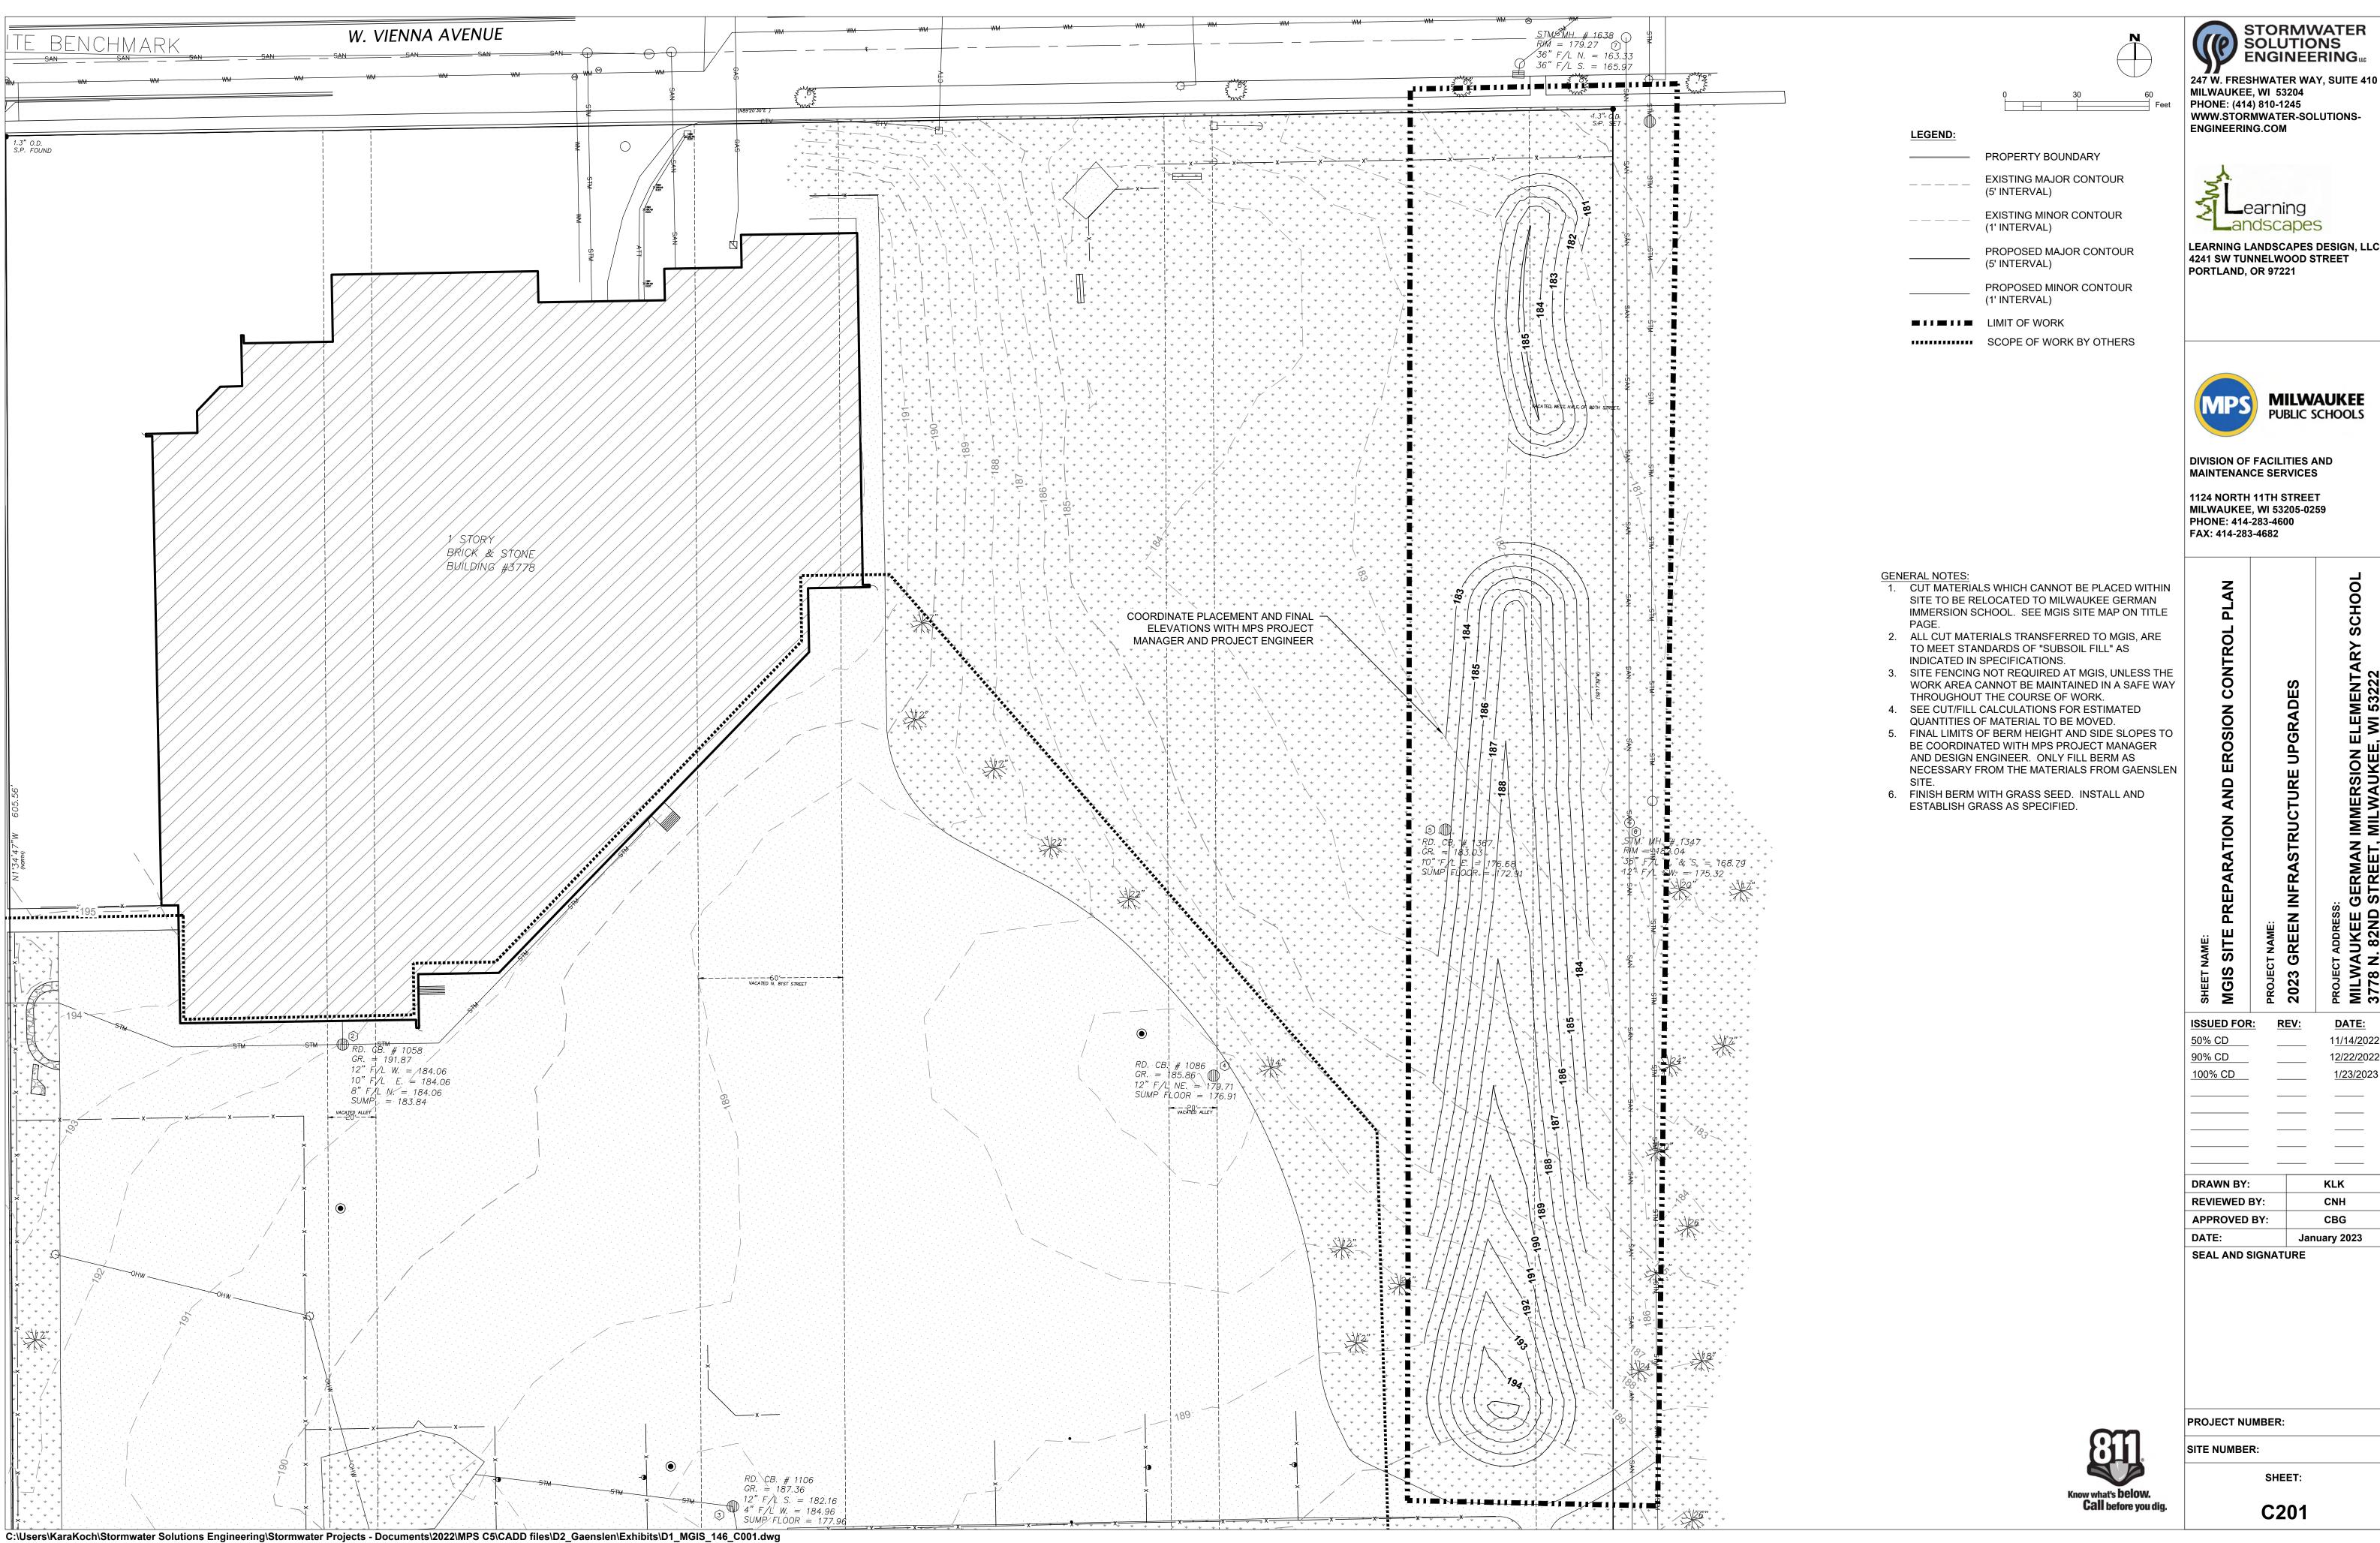DRAWN BY:	EMP
REVIEWED BY:	KLK
APPROVED BY:	CBG
DATE:	January 2023
SEAL AND SIGNATI	URE

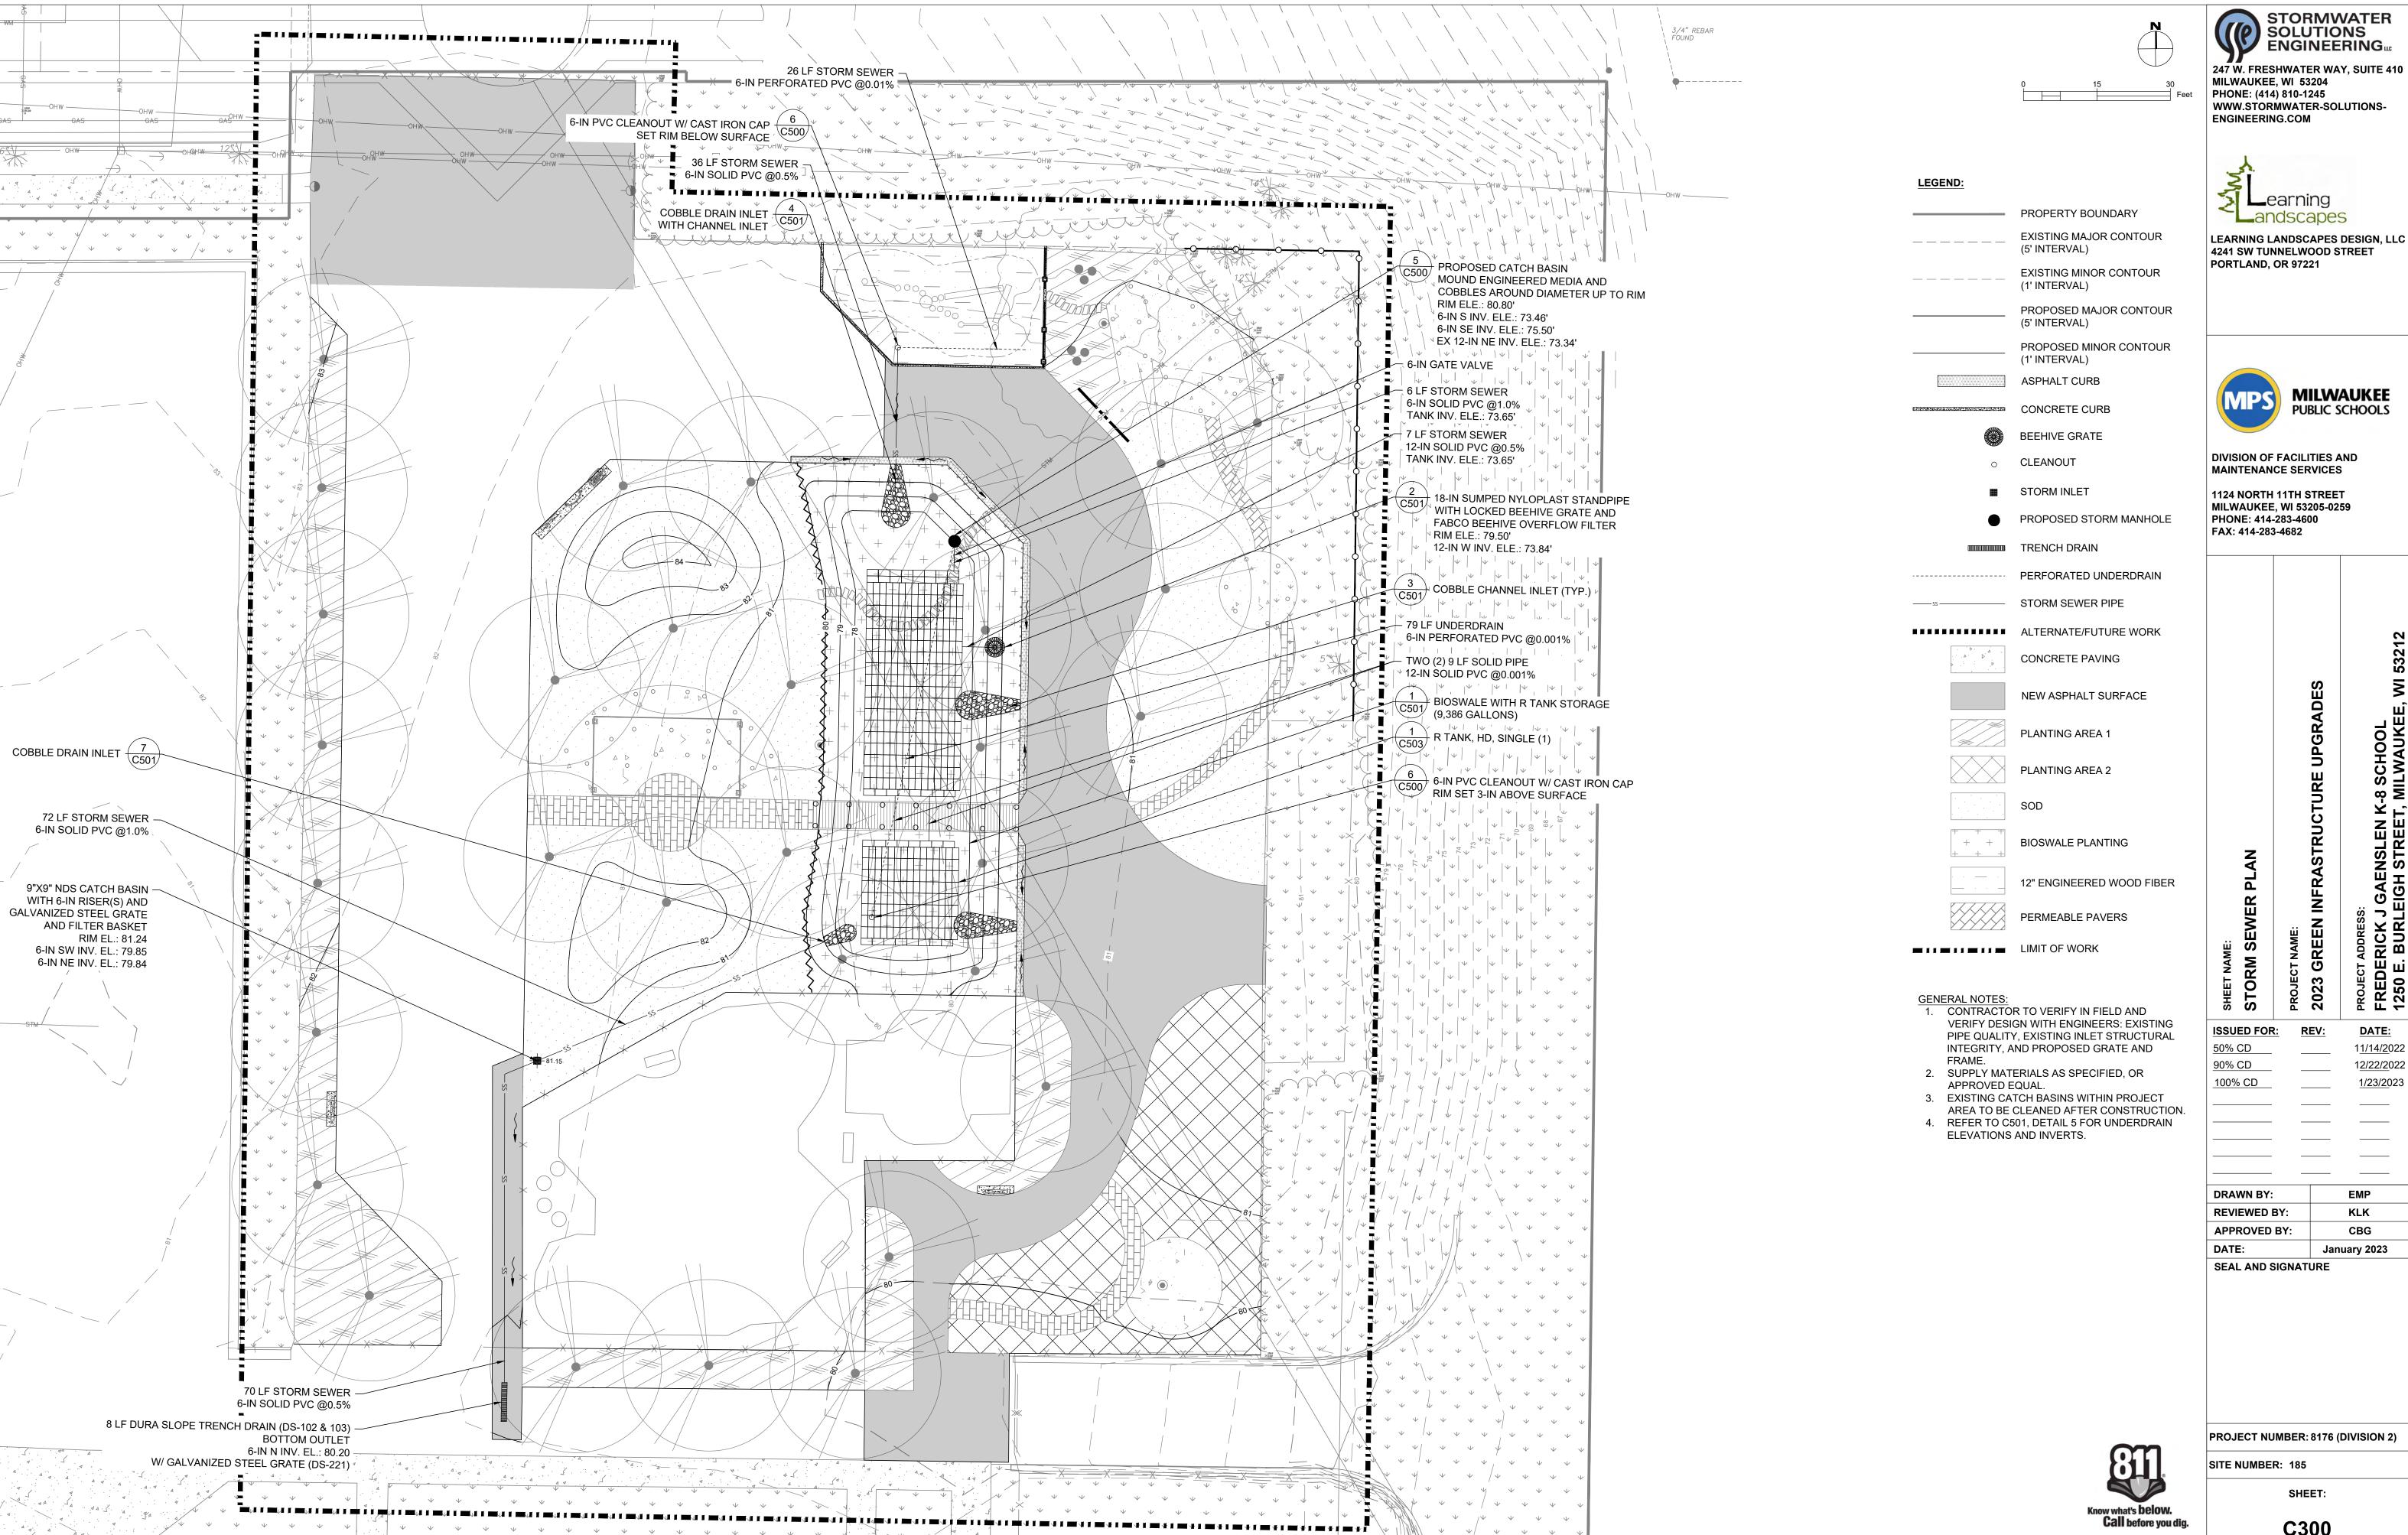C300

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PROPERTY BOUNDARY

(5' INTERVAL)

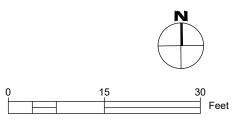(1' INTERVAL)

(5' INTERVAL)

(1' INTERVAL)

ASPHALT CURB

BEEHIVE GRATE

CONCRETE PAVING

PLANTING AREA 1

PLANTING AREA 2

BIOSWALE PLANTING

PERMEABLE PAVERS

12" ENGINEERED WOOD FIBER

NEW ASPHALT SURFACE

EXISTING MAJOR CONTOUR

EXISTING MINOR CONTOUR

PROPOSED MAJOR CONTOUR

PROPOSED MINOR CONTOUR



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50% CD 1<u>1/14/2</u>022

**DRAWN BY: EMP REVIEWED BY:** KLK **APPROVED BY:** CBG DATE: January 2023

SEAL AND SIGNATURE


PROJECT NUMBER: 8176 (DIVISION 2)

SITE NUMBER: 185

SHEET:

C400

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**DIVISION OF FACILITIES AND** MAINTENANCE SERVICES

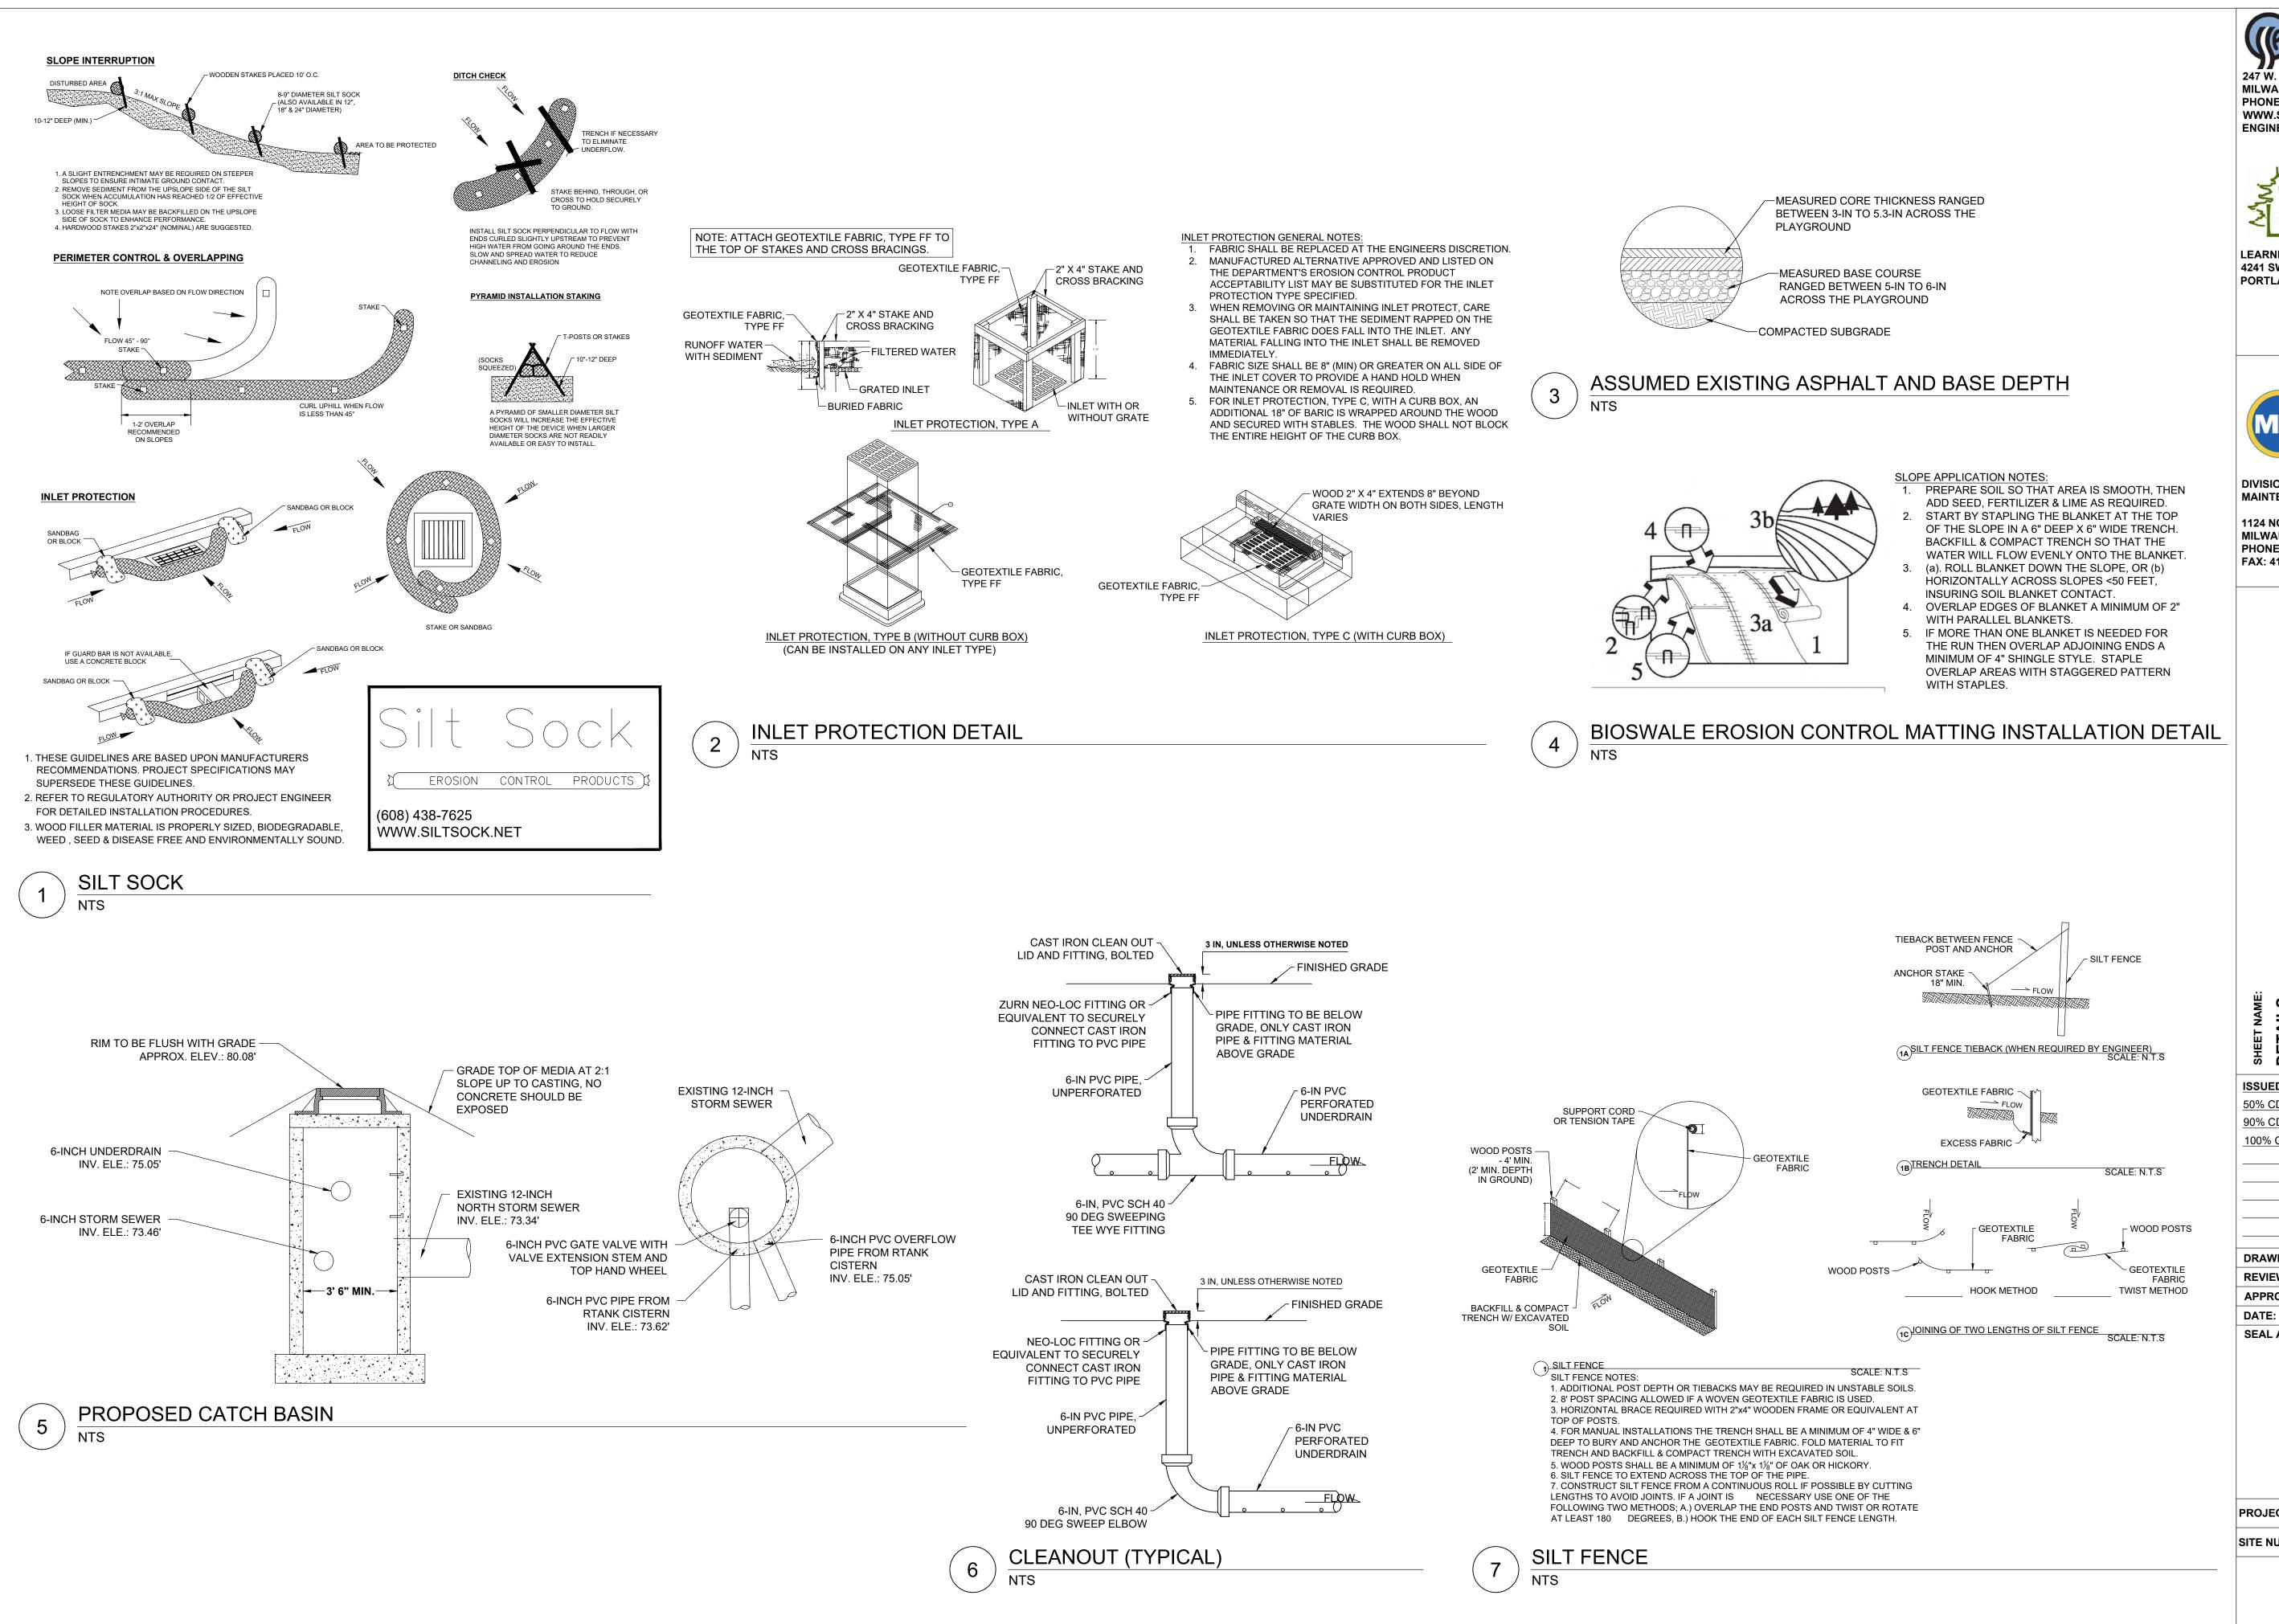GREEN

2023 **ISSUED FOR:** DATE: 50% CD 1<u>1/14/2</u>022 90% CD 1<u>2/22/2</u>022 <u>1/23/2</u>023

**DRAWN BY: EMP REVIEWED BY:** KLK **APPROVED BY:** CBG

January 2023 **SEAL AND SIGNATURE** 


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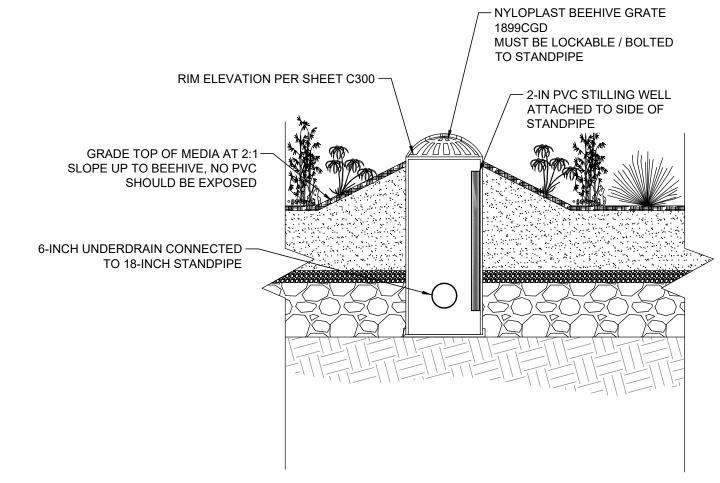
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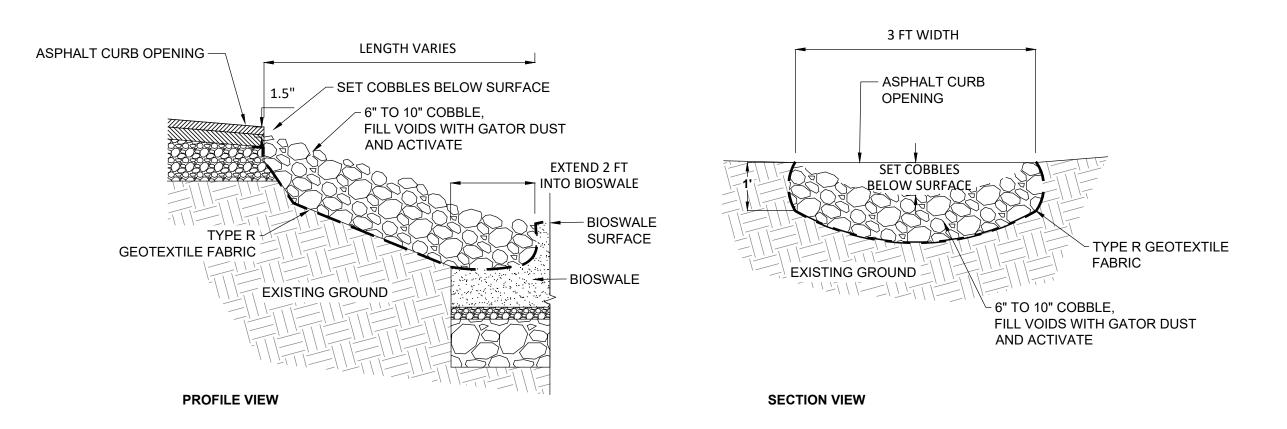
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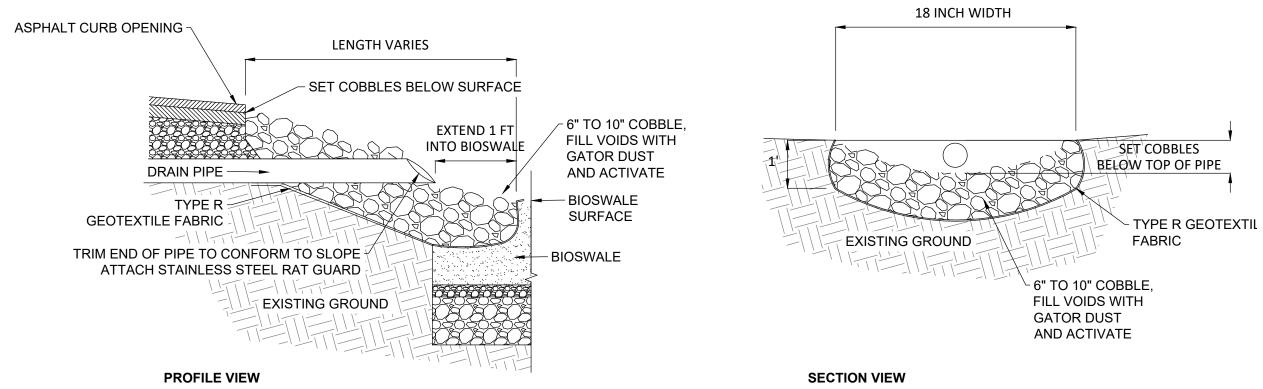




**BIOSWALE** 


18-IN BIOSWALE STANDPIPE OVERFLOW




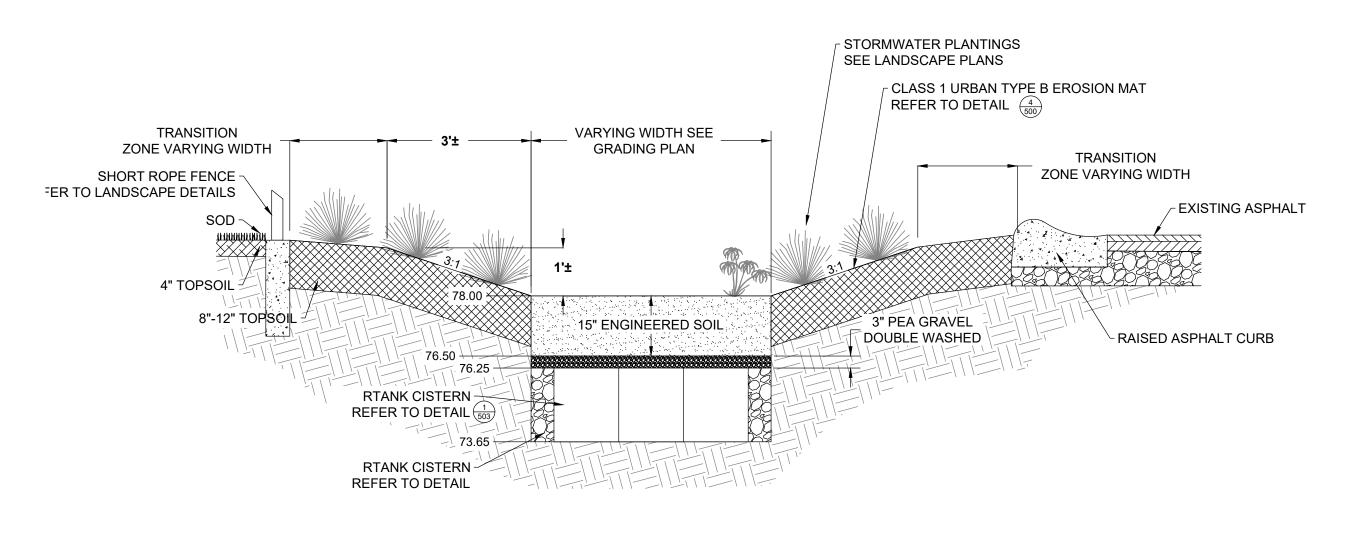


COBBLE CHANNEL INLET

COBBLE DRAIN INLET WITH CHANNEL INLET

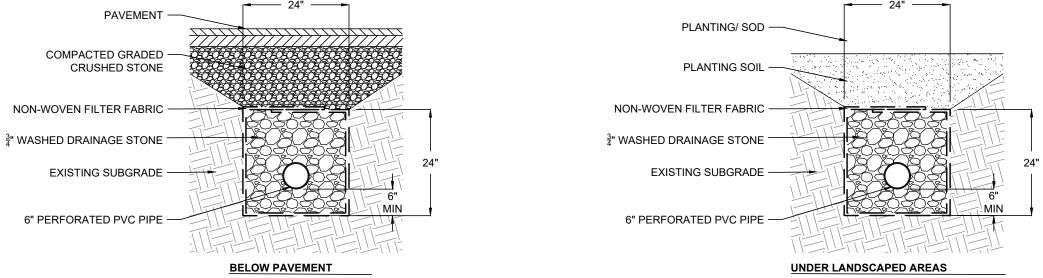


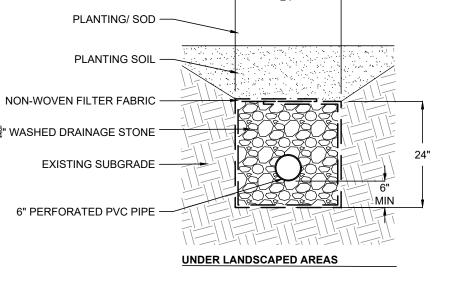



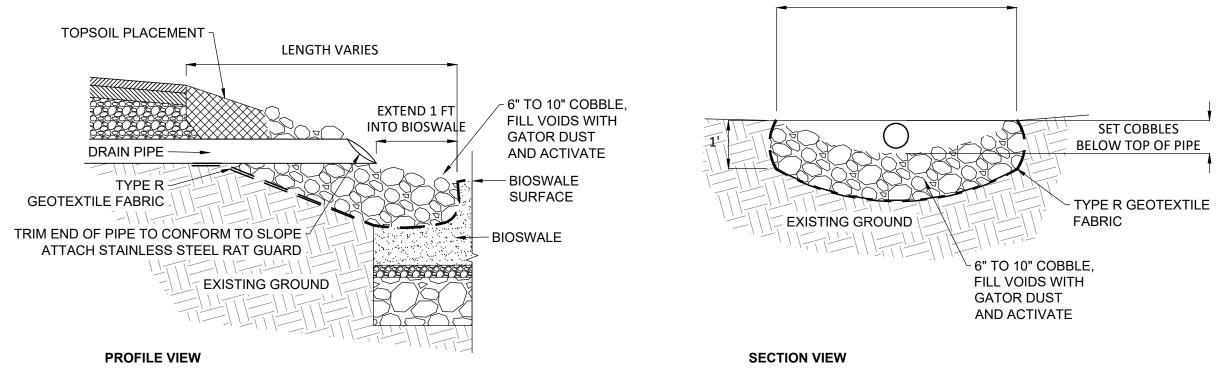

18 INCH WIDTH

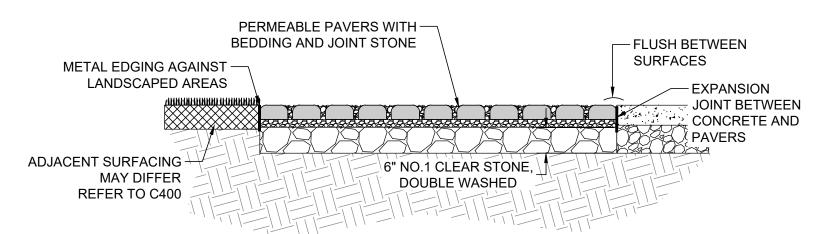

COBBLE DRAIN INLET

PERMEABLE PAVER SURFACE WITH NO STORAGE NTS

PROJECT NUMBER: 8176 (DIVISION 2) SITE NUMBER: 185 SHEET:

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**STORMWATER** 

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**2023 GREEN ISSUED FOR:** DATE: 1<u>1/14/2</u>022 1<u>2/22/2</u>022

100% CD <u>1/23/2</u>023 **DRAWN BY: EMP** 


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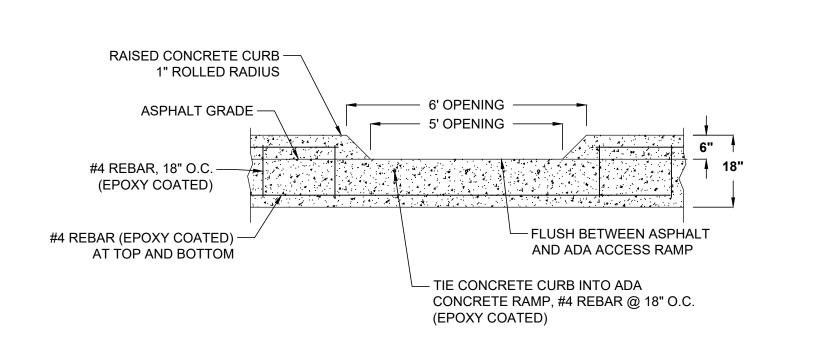
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DETAILS


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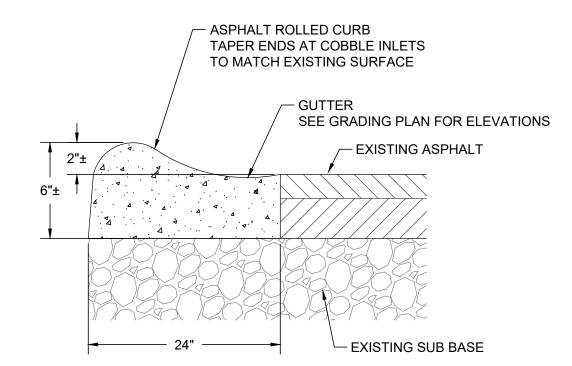







RAISED CONCRETE CURB AND ENGINEERED WOOD FIBER

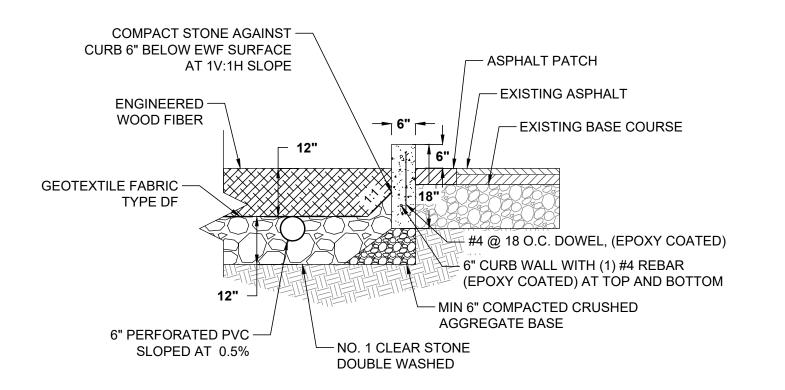RAISED CONCRETE CURB OPENING AND CONNECTION TO ADA ACCESS RAMP

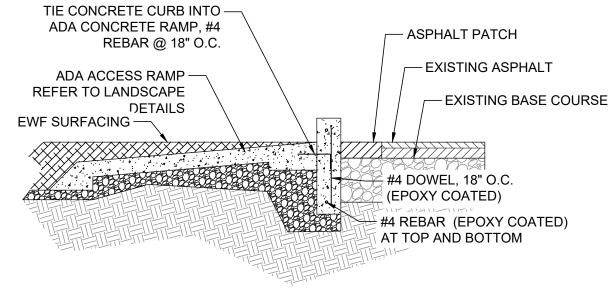

- 1. THE FUNCTION OF THE ASPHALT CURB IS TO CONVEY WATER TO COBBLE INLETS.
- 2. ASPHALT CURBS CAN BE FULL DEPTH NEW PATCHES OF ASPHALT, OR CONSTRUCTED BY MILLING AND OVERLAYING A NEW TOP SURFACE. CONSULT WITH ENGINEER PRIOR TO CONSTRUCTION.
- 3. WHEN INSTALLING A FULL DEPTH NEW PATCH, COMPACT SUBBASE MATERIAL PRIOR TO PLACEMENT OF ASPHALT PATCH.
- 4. GUTTER SLOPE TO COBBLE INLETS SHALL BE UNIFORM. 5. WHEN CONSTRUCTING THE ASPHALT CURB WITH A LOG BORDER, COORDINATE THE ASPHALT PATCH WORK WITH THE INSTALLATION OF THE HORIZONTAL LOGS TO ENSURE 50% LOG TO ASPHALT CONTACT.
- 6. REFER TO LANDSCAPE DETAILS FOR THE INSTALLATION OF THE HORIZONTAL LOG BORDER.

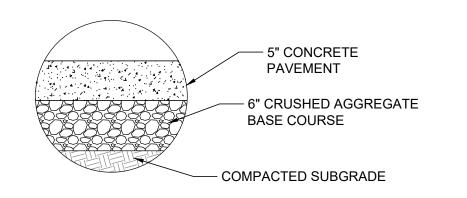






**CONCRETE PAVING** 



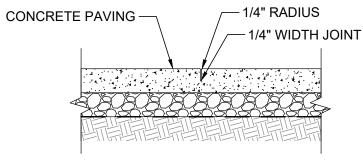


-1 ½" SURFACE OVER TACK COAT  $-2\frac{1}{2}$ " BINDER (LOWER LAYER) -12" DENSE GRADED AGGREGATE BASE COURSE  $(1\frac{1}{4}")$ -COMPACTED SUBGRADE

CONCRETE TOOLED CONTROL JOINT




**ASPHALT PAVING** 

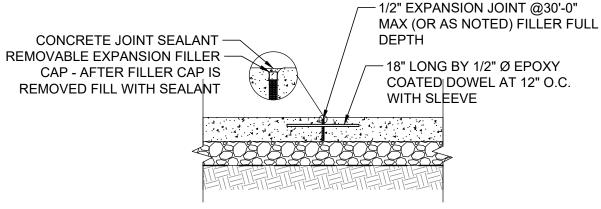

**CONCRETE EXPANSION JOINT** 



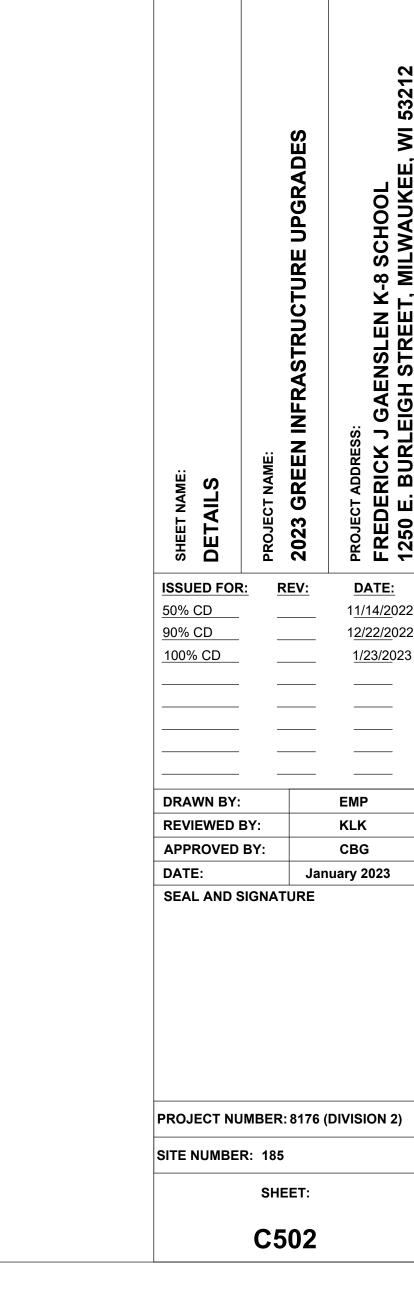

**STORMWATER** 

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**MILWAUKEE** 

**PUBLIC SCHOOLS** 

4241 SW TUNNELWOOD STREET

**DIVISION OF FACILITIES AND** MAINTENANCE SERVICES


1124 NORTH 11TH STREET **MILWAUKEE, WI 53205-0259** PHONE: 414-283-4600 FAX: 414-283-4682


PORTLAND, OR 97221


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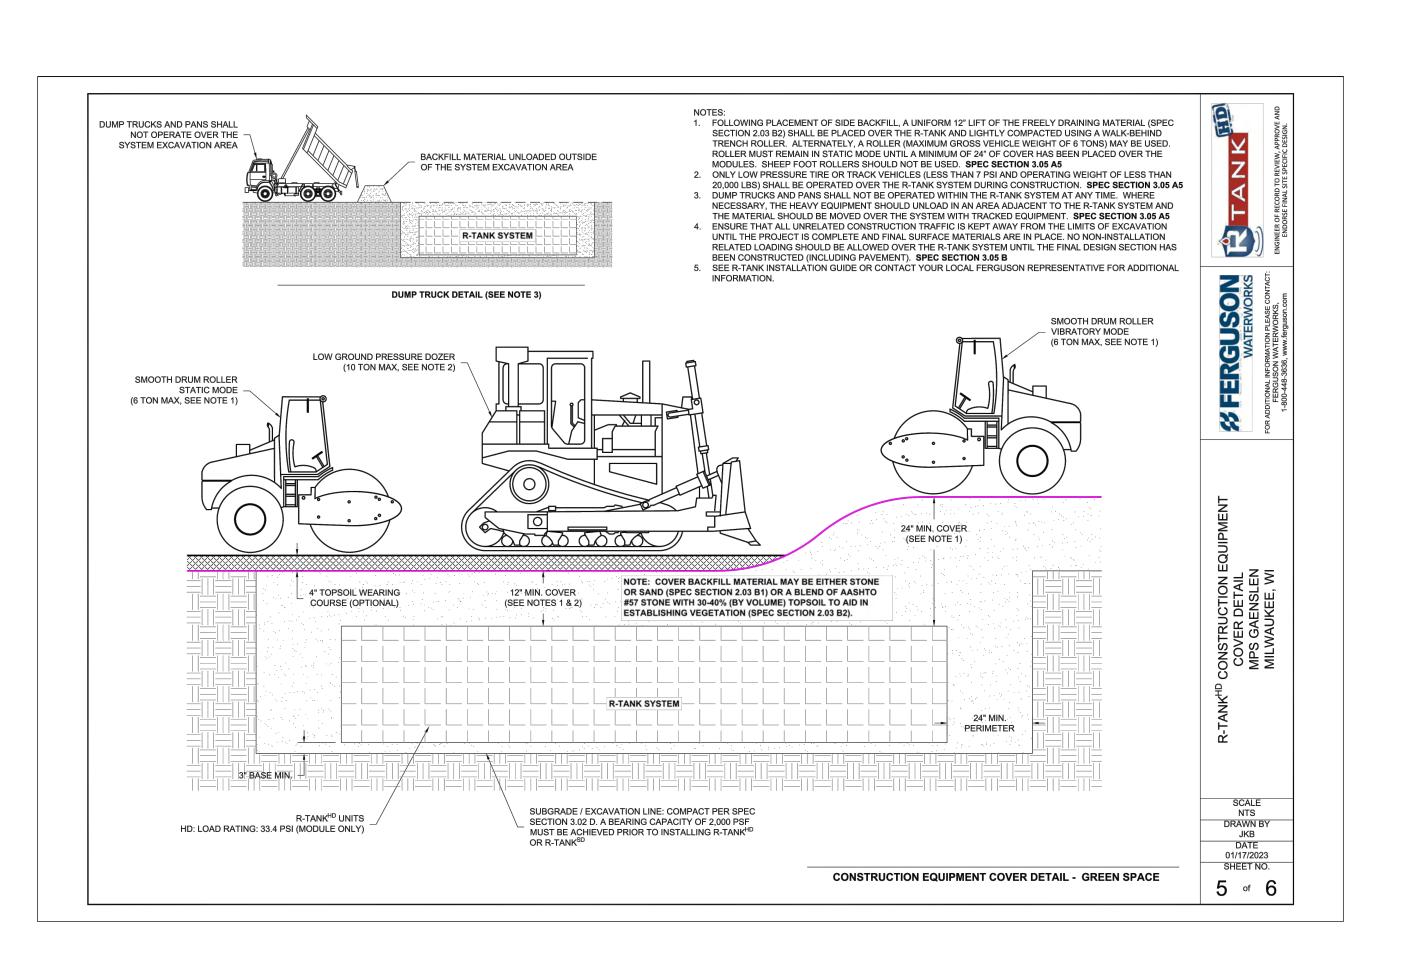
MILWAUKEE, WI 53204 PHONE: (414) 810-1245


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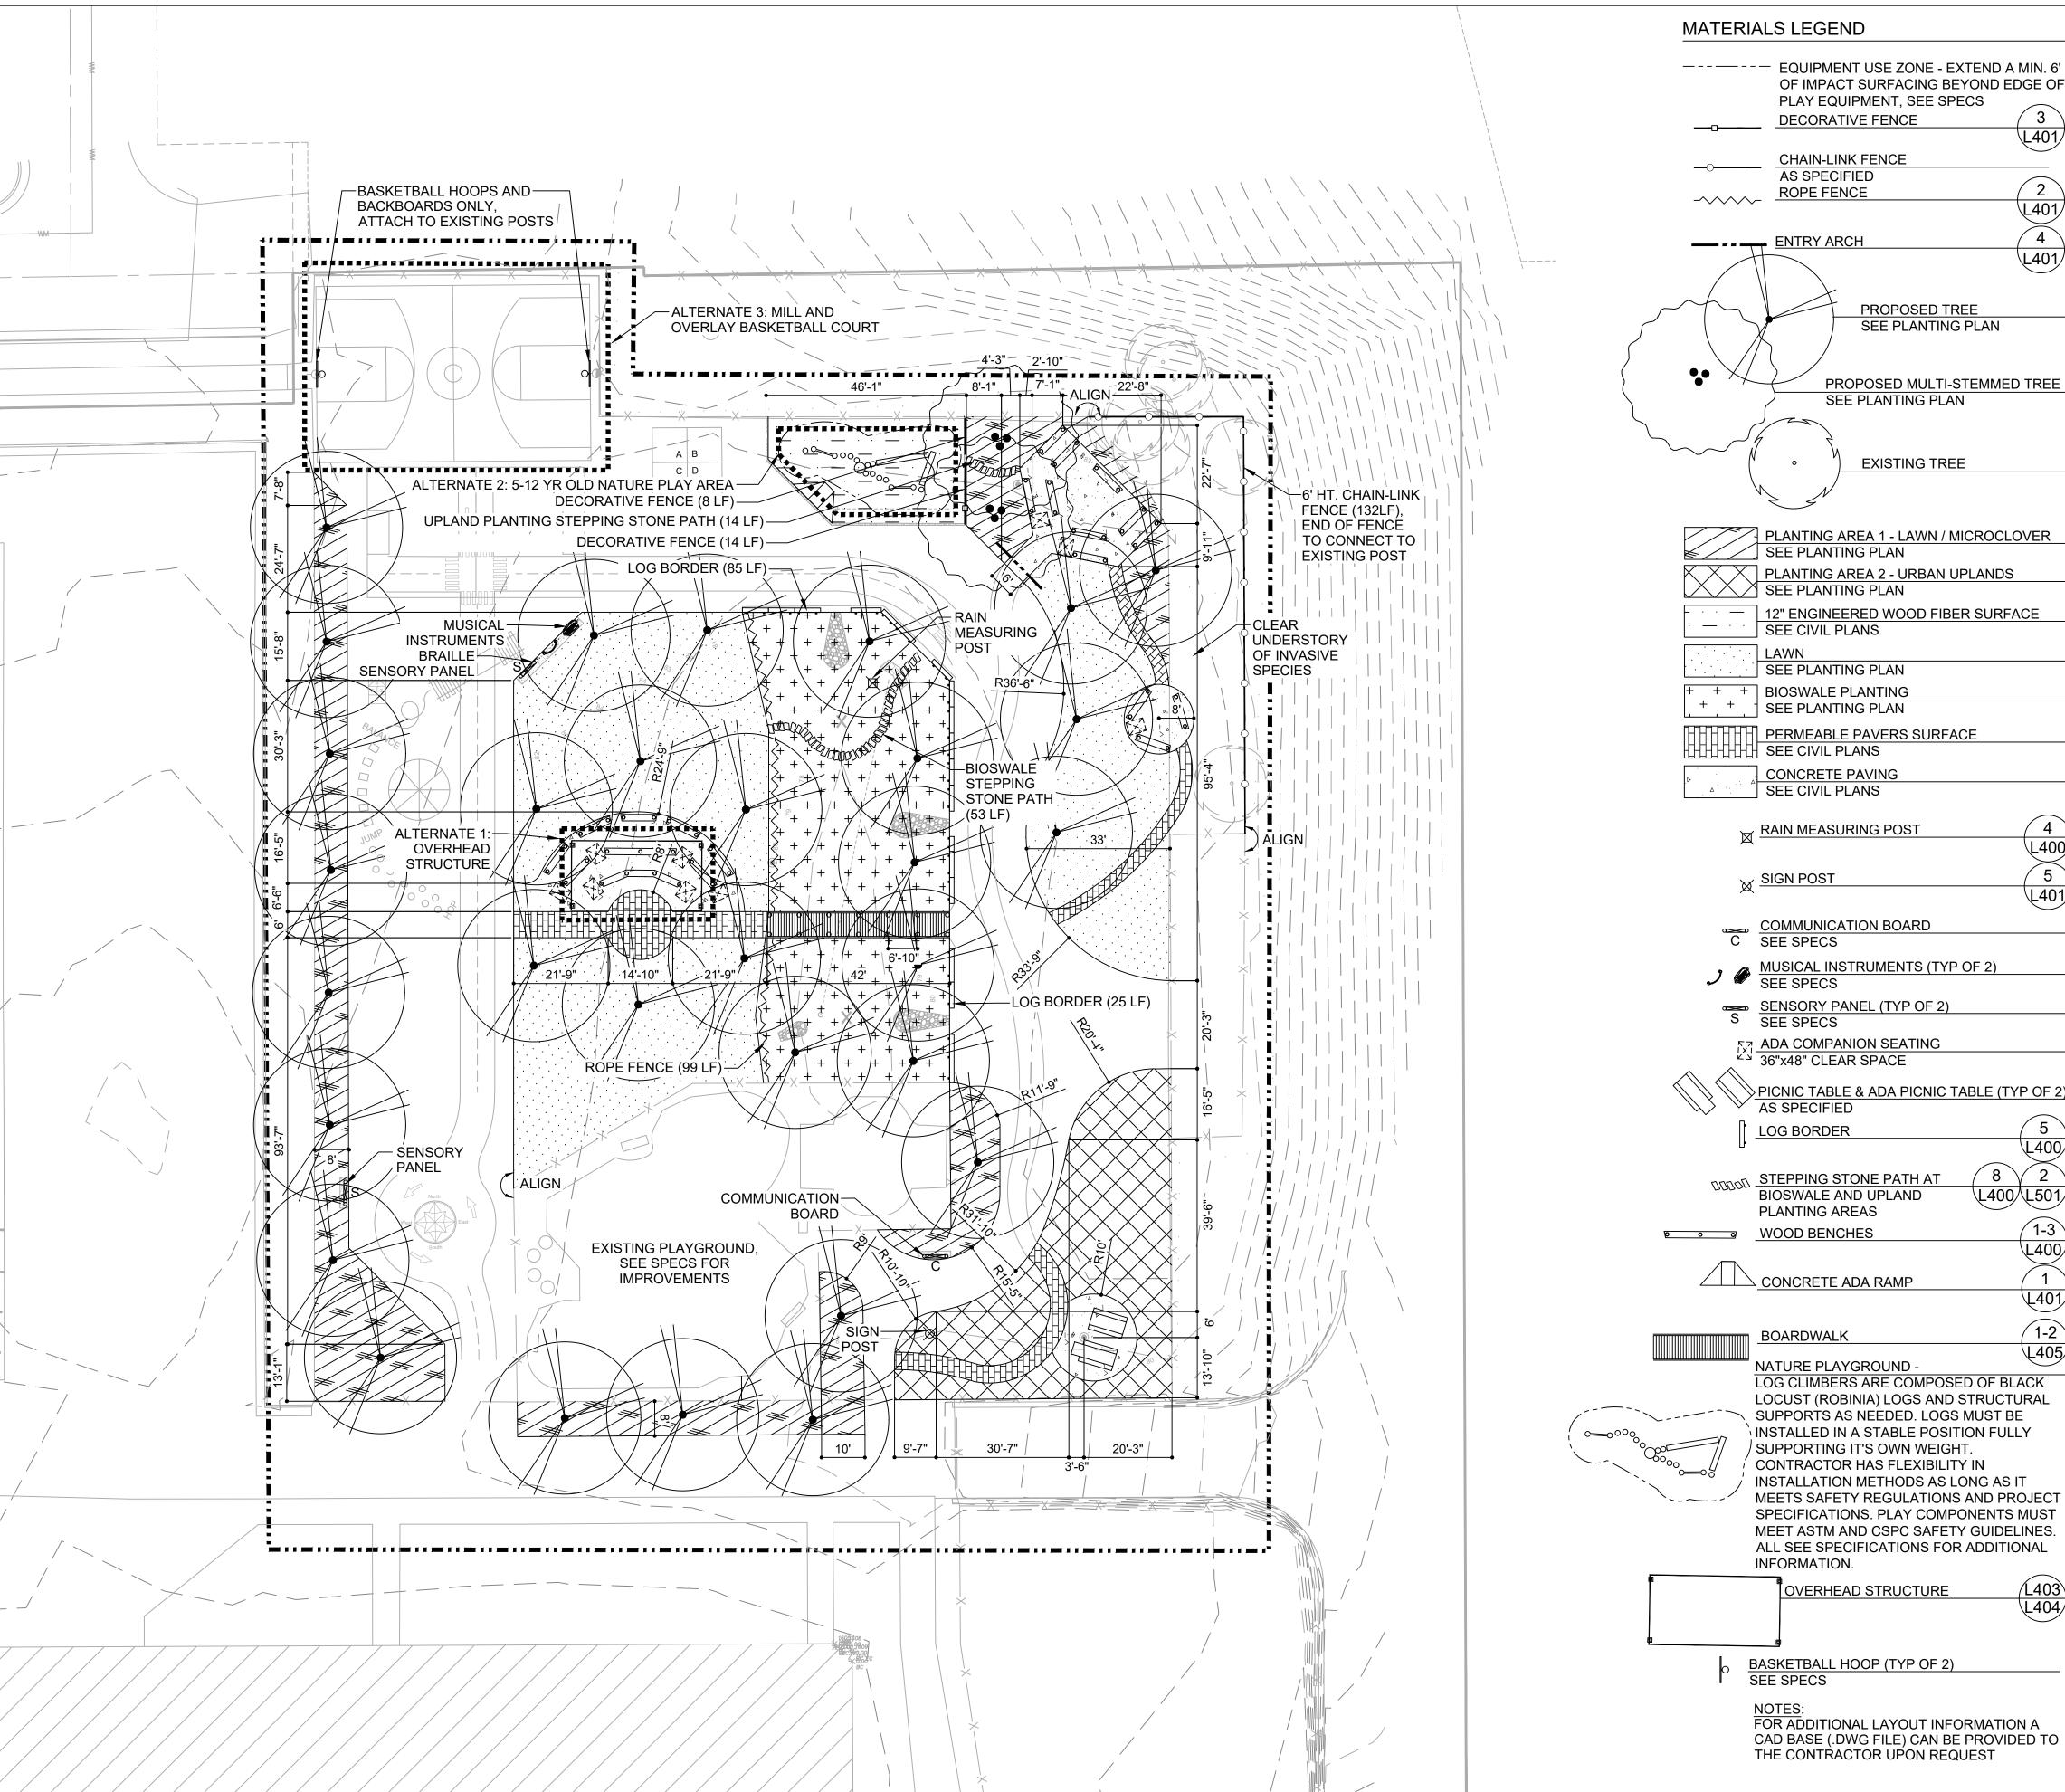





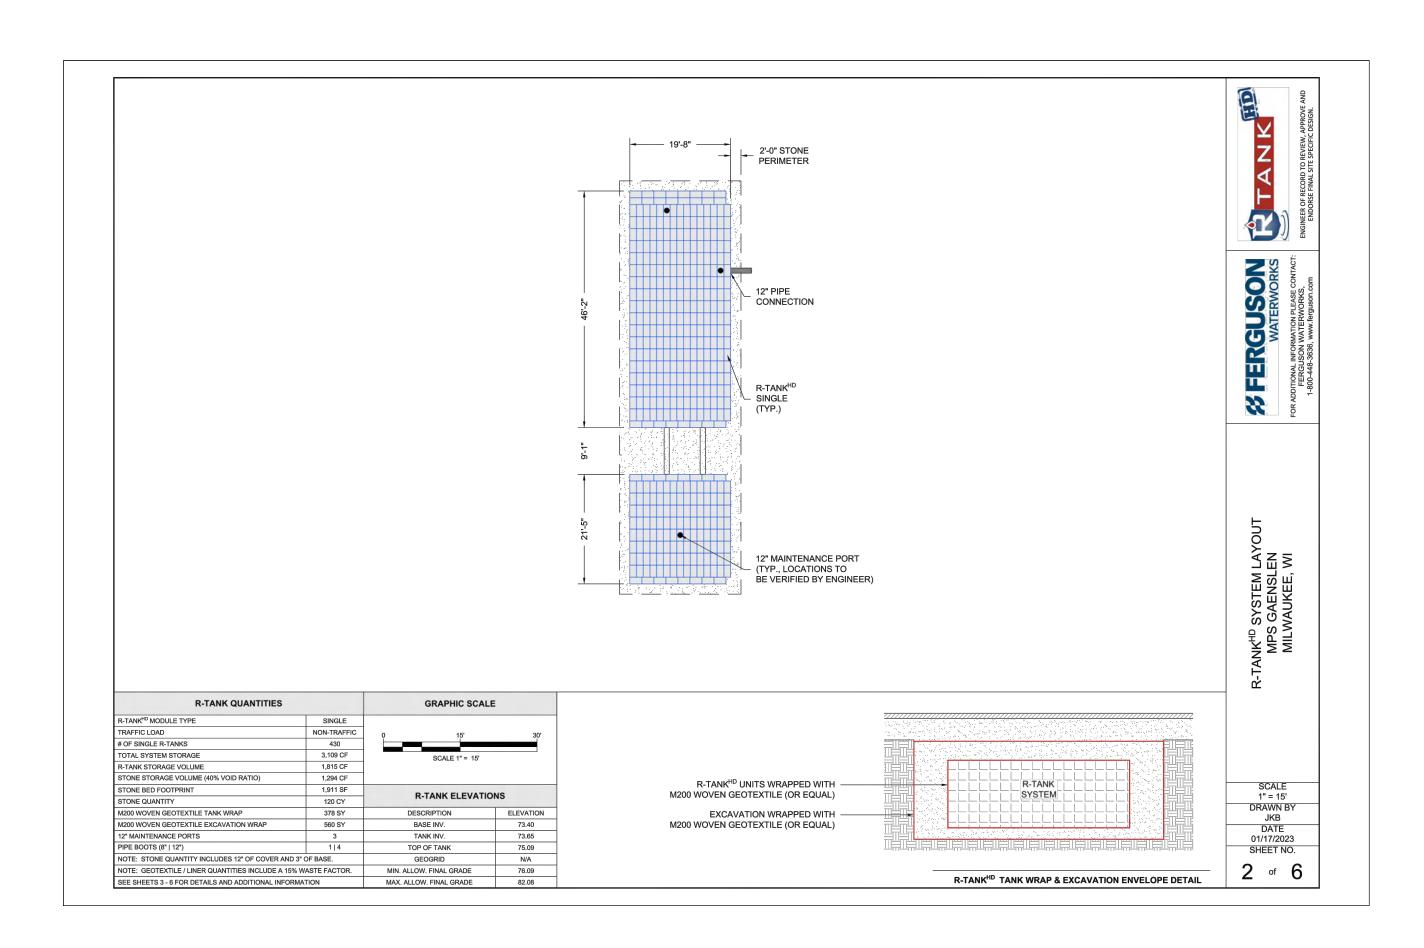

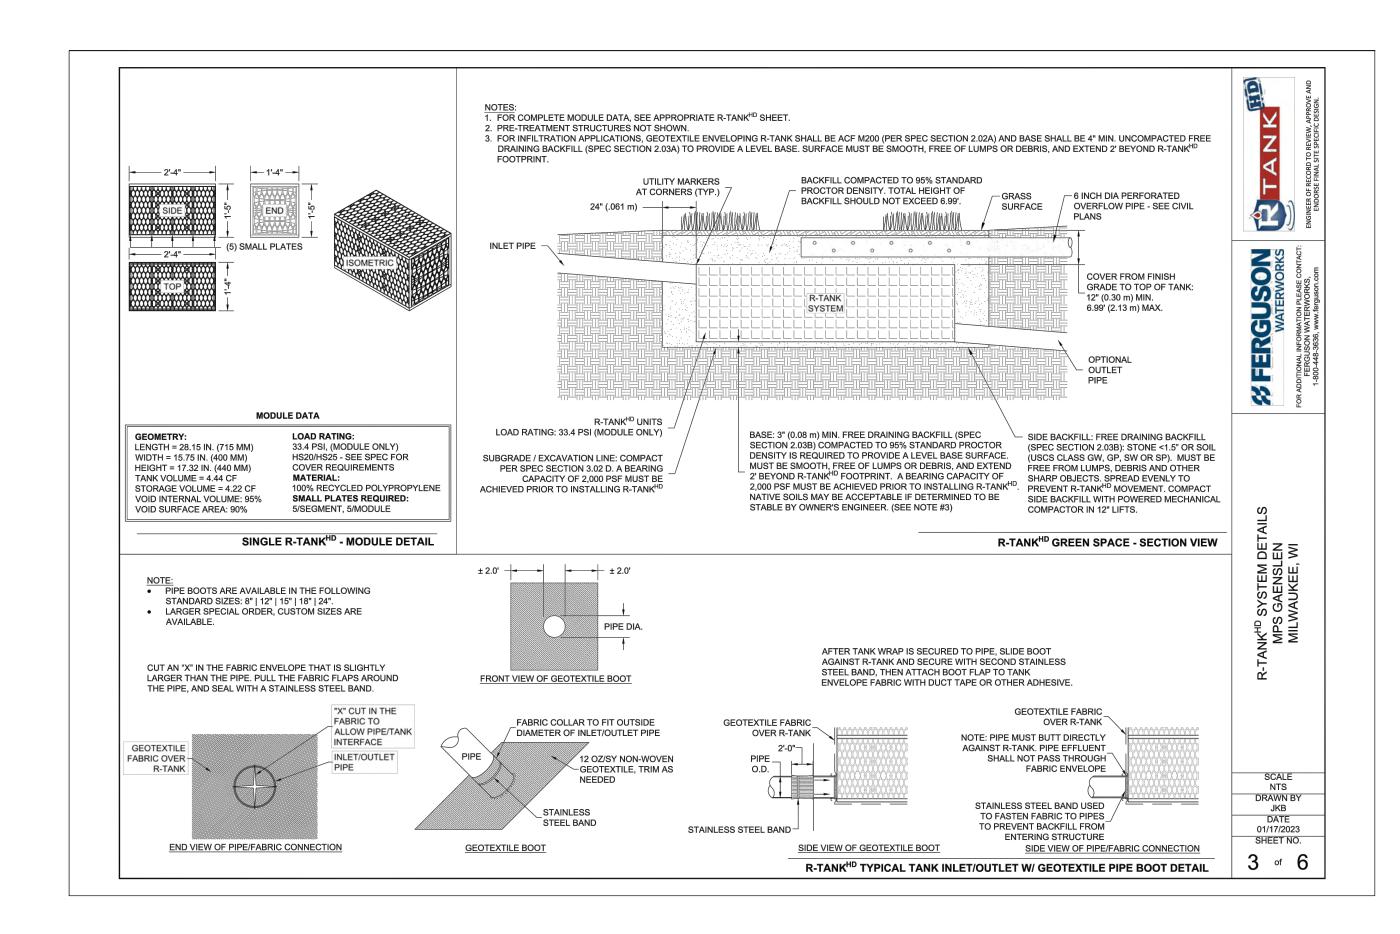SHEET:

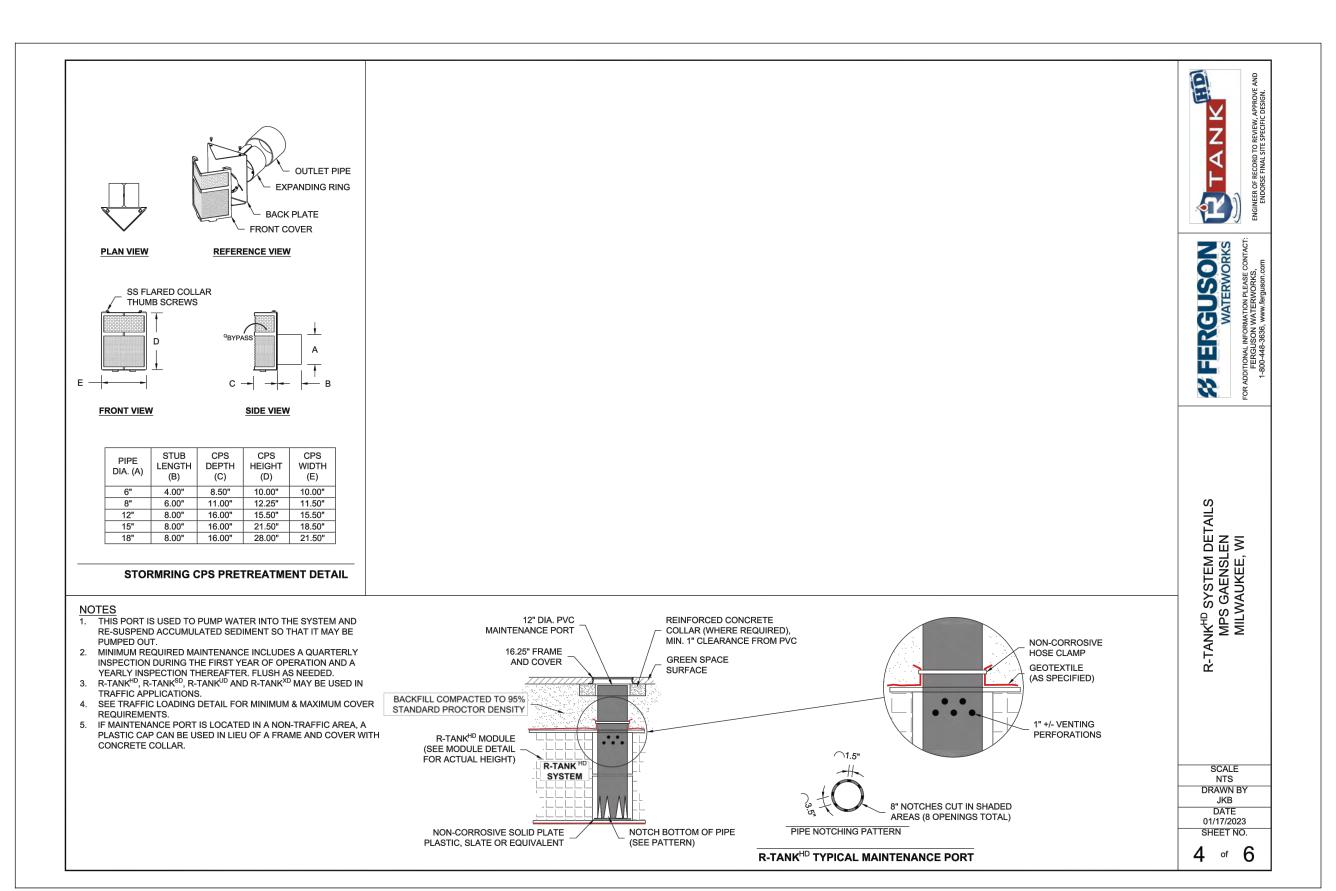C503

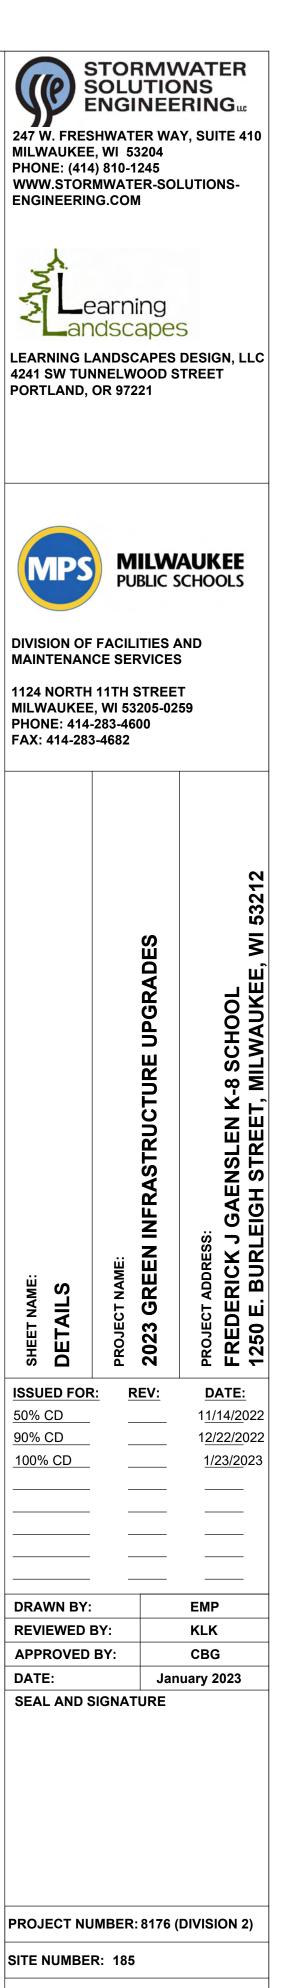

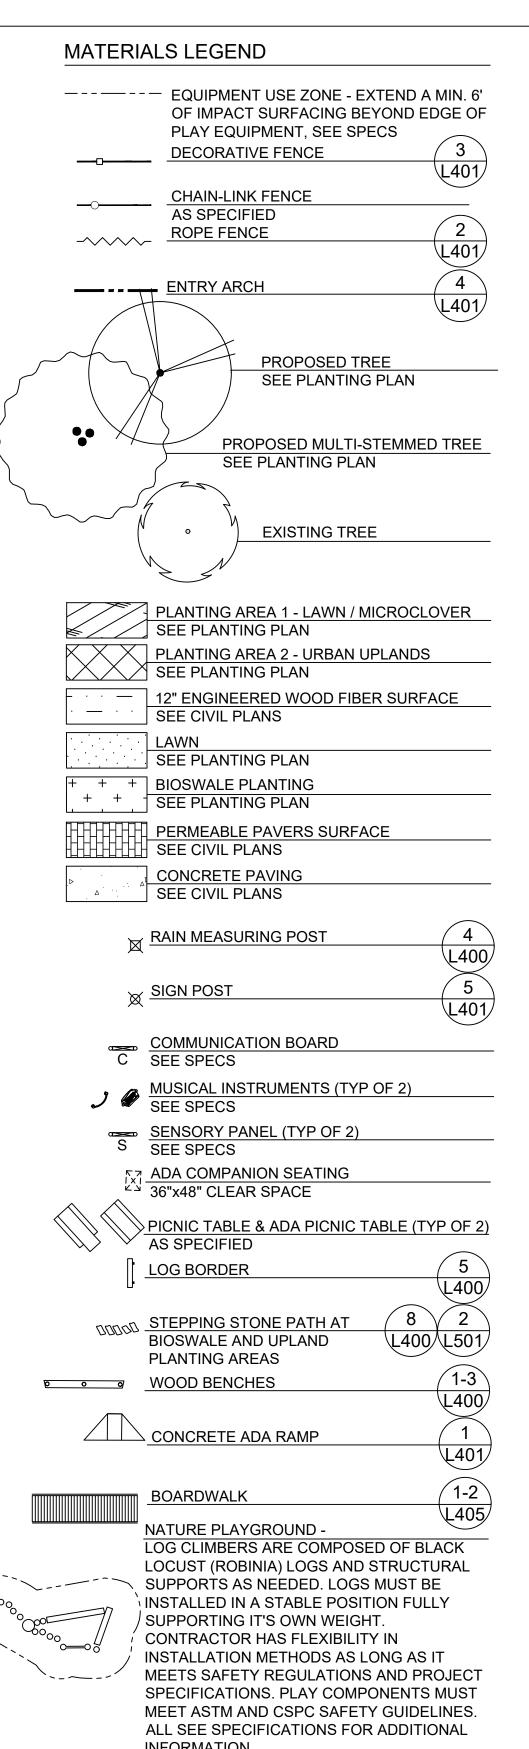



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PLAN	STRUCTURE UPGRADES	ISLEN K-8 SCHOOL STREET, MILWAUKEE, WI 53212
UT PLAN	STRUCI	SLEN P

ST NAME: GREEN PROJEC 2023 (

**ISSUED FOR:** DATE: 50% CD 1<u>1/14/2</u>022 12/22/2022 95% CD 100% CD 1/2<u>3/202</u>3

**DRAWN BY:** ZWA **REVIEWED BY:** KW MM APPROVED BY: January 2023 DATE:

SEAL AND SIGNATURE




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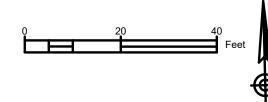
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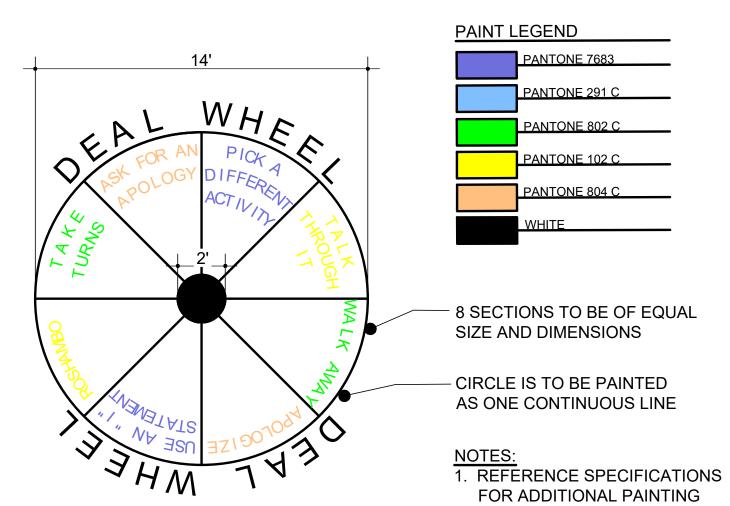
\*\*SHEET MUST BE PRINTED IN COLOR\*\*



PAINT LEGEND PANTONE 7683 PANTONE 291 C PANTONE 802 C PANTONE 102 C PANTONE 804 C DEAL WHEEL

# PAINT NOTES

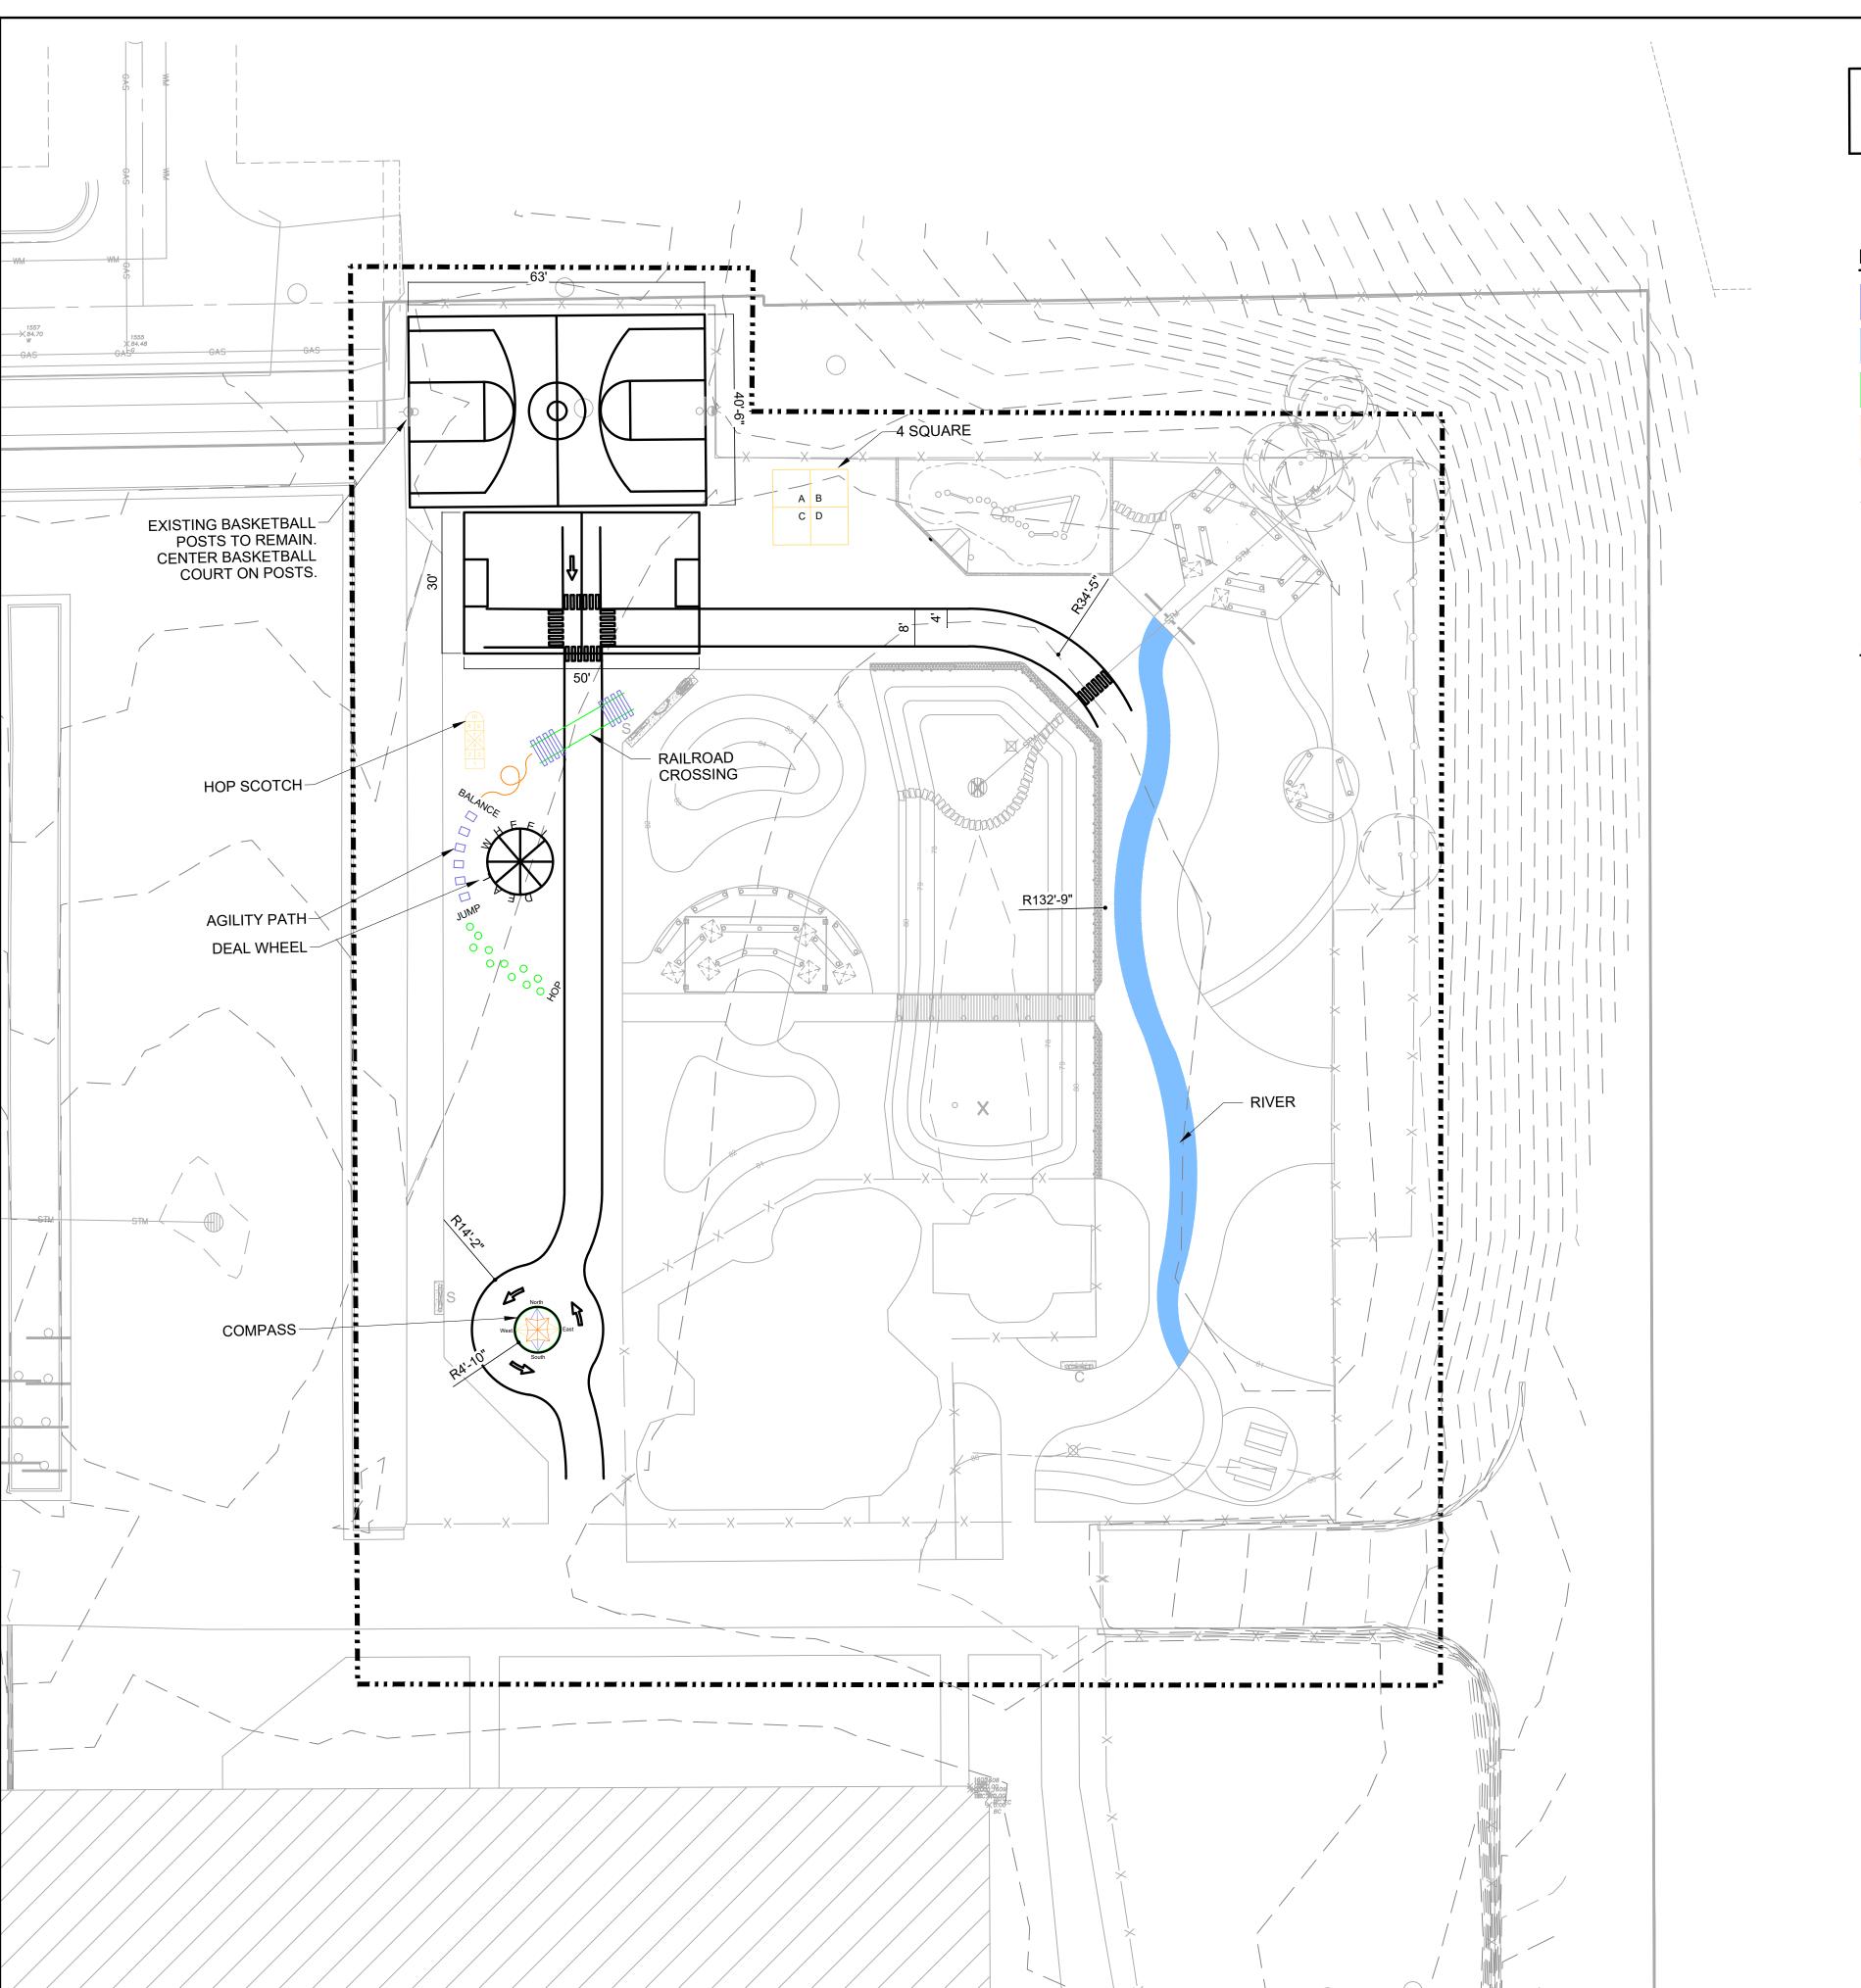- 1. REFERENCE SPECIFICATIONS FOR COLOR AND APPLICATION INFORMATION
- 2. ALL PAVEMENT MARKINGS ARE PER MPS STANDARD TEMPLATES UNLESS OTHERWISE STATED
- 3. REFERENCE DETAIL 1/L200 FOR DEAL WHEEL LAYOUT
- 4. PREP SURFACE AS SPECIFIED, SEE CIVIL PLANS
- 5. A COPY OF MPS' STANDARD LINE AND GAME STRIPING DETAILS IS AVAILABLE UPON REQUEST FROM THE DIVISION OF FACILITIES AND MAINTENANCE SERVICES, (414) 283-4600



PAVEMENT MARKINGS - DEAL WHEEL

0" 12" 24" 48"

INFORMATION



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> UPGRADES -8 SCHOOL MILWAUKEE

DRAWN BY: ZWA **REVIEWED BY:** KW APPROVED BY: MM DATE: January 2023

SEAL AND SIGNATURE VLA-822-14 WAUWATOSA


PROJECT NUMBER: 8176 (DIVISION 2)

SITE NUMBER: 185

**ISSUED FOR:** 

50% CD

SHEET:

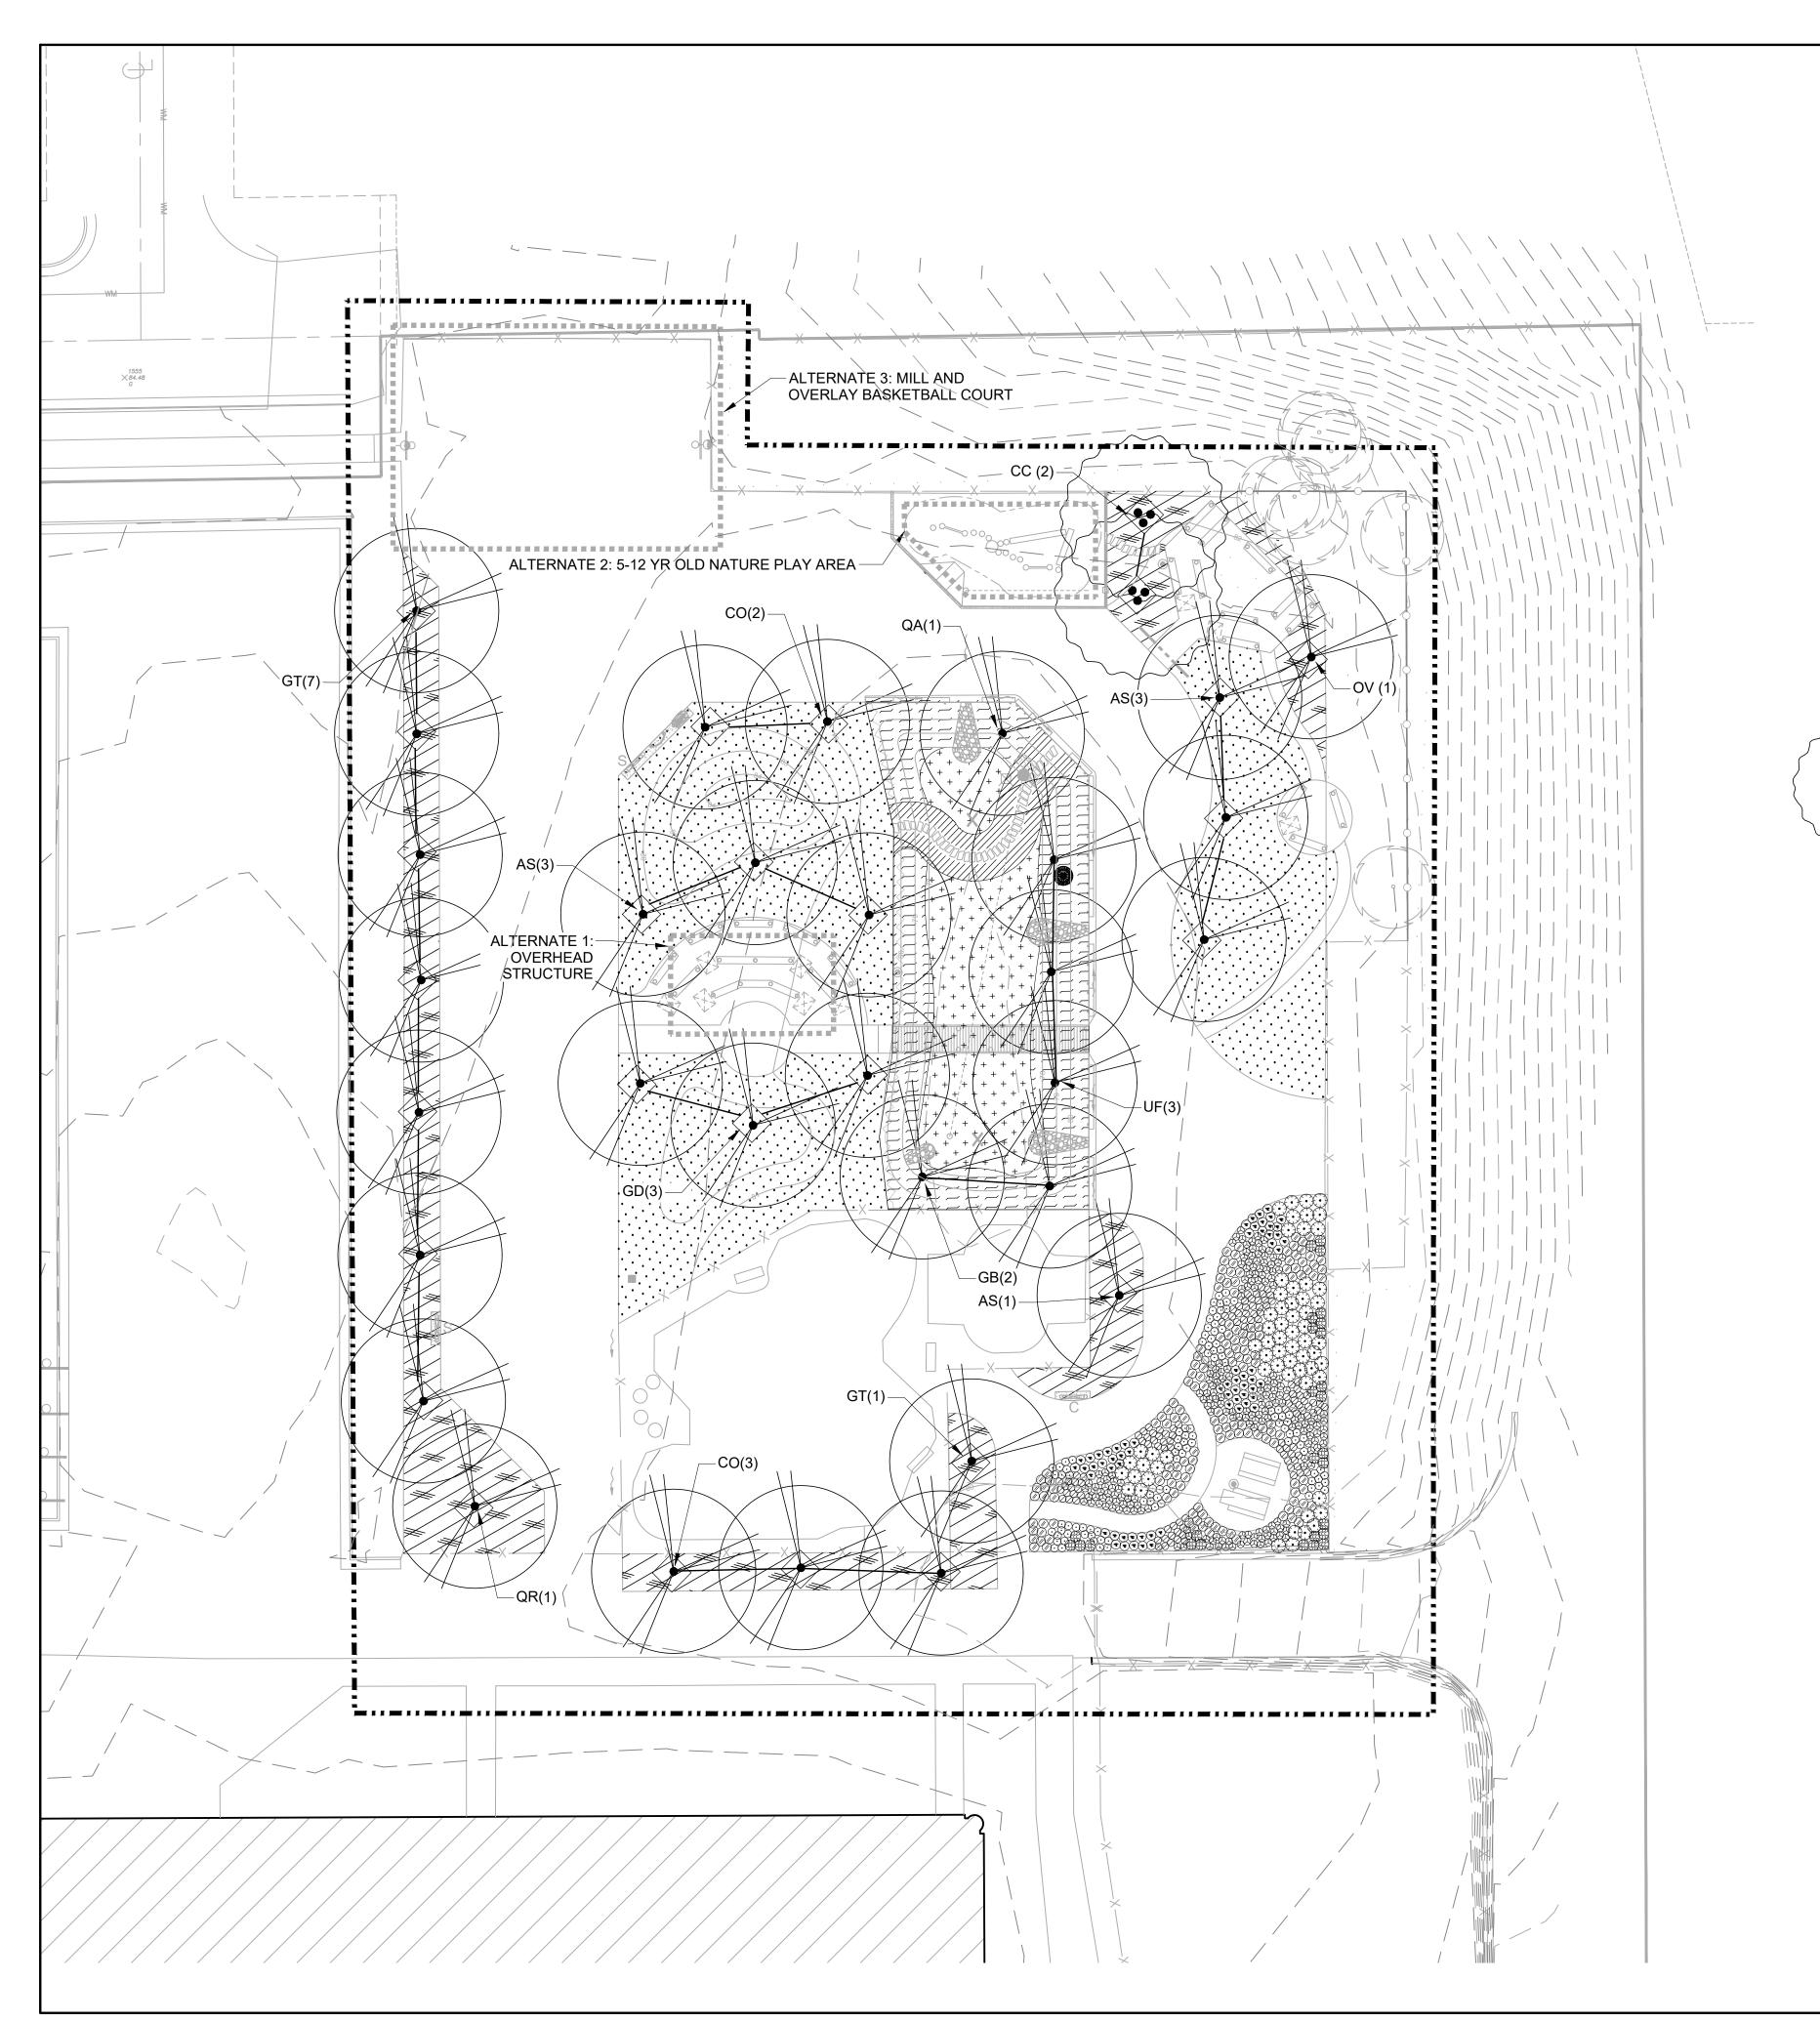

PLANTING LEGEND

QUANTITIES BASE BID **EXISTING TREE** PROPOSED TREES Diamond symbol indicates tree installation and protection staking per detail 3/L501. Trees without protection staking shall be staked per detail 3/L500. Acer saccharum 'Green Mountain' -Green Mountain Sugar Maple 3" Cal. B&B, Mature Size: 60' ht. x 45' spread Celtis occidentalis - Common Hackberry 3" Cal. B&B, Mature Size: 50' ht. x 50' spread Ginkgo biloba 'Autumn Gold' - Auntumn Gold Ginkgo 3" Cal. B&B, Mature Size: 45' ht. x 35' spread Gymnocladus dioica - Kentucky Coffeetree 3" Cal. B&B, Mature Size: 55' ht. x 55' spread Gleditsia triacanthos 'Skycole' - Skyline Honeylocust 3" Cal. B&B, Mature Size: 55' ht. x 35' spread, Thornless variety Ostrya virginiana - Ironwood 3" Cal. B&B, Mature Size: 50' ht. x 30' spread, Quercus macrocarpa - Bur Oak 3" Cal. B&B, Mature Size: 80' ht. x 80' spread *Quercus rubra -* Red Oak 3" Cal. B&B, Mature Size: 60' ht. x 60' spread Ulmus 'Frontier' - Frontier Elm 3" Cal. B&B, Mature Size: 50' ht. x 30' spread PROPOSED MULTI-STEMMED TREE Carpinus caroliniana - Musclewood Multi-stem B&B, Mature Size: 30' ht. x 30' spread Planting Area 1 - Lawn/Microclover See Specs Geum triflonum - Prairie Smoke Plant plugs 12" o.c. with triangular spacing **PLUGS** ZONE B Bio-swale Bottom Seed Mix ZONE C Bioswale Side Slope Mix Plant plugs 12"-18" O.C. with triangular spacing, group plugs by species in groups of 40-50. Allium cernuum - Nodding Onion Plug, Mature Size: 1.5' ht x 1' spread Dodecatheon meadia - Shooting Star Plug, Mature Size: 1.5' ht x 1' spread Eragrostis Spectabilis - Purple Love Grass Plug, Mature Size: 1' ht x 1.5' spread Rudbeckia hirta - Black Eyed Susan Plug, Mature Size: 1-3' ht x 1.5' spread Zizia aurea - Golden Alexander Plug, Mature Size: 1-2' ht x 1.5' spread URBAN SCHOOLYARD PLANTING AREA Actinidia kolomikta - Arctic Kiwi, MALE VARIETY ONLY Plug, Mature Size: climbing x 1-3' spread Aquilegia canadensis - Wild Columbine Plug, Mature Size: 2.5' ht x 1.5' spread Coreopsis lanceolata - Lance Leaf Coreopsis 116 Plug, Mature Size: 1.5' ht x 1.5' spread Lavandula spp. - Lavender Plug, Mature Size: 2' ht x 2' spread Liatris aspera - Rough Blazing Star Plug, Mature Size: 2.5' ht x 1.5' spread Schizachynium Scoparium - Little Bluestem Plug, Mature Size: 2' ht x 1.5' spread Sporobulus heterolepsis - Prairie Dropseed Plug, Mature Size: 3' ht x 3' spread

## NOTES

- SEE SHEET L500 AND L501 FOR PLANTING DETAILS AND
- 2. SEE SPECS FOR SEED MIX SPECIES PERCENT COVERAGE



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DRAWN BY:	ZWA
REVIEWED BY:	KW
APPROVED BY:	ММ
DATE:	January 2023

SEAL AND SIGNATURE

00% CD





PROJECT NUMBER: 8176 (DIVISION 2)


SITE NUMBER: 185

SHEET:



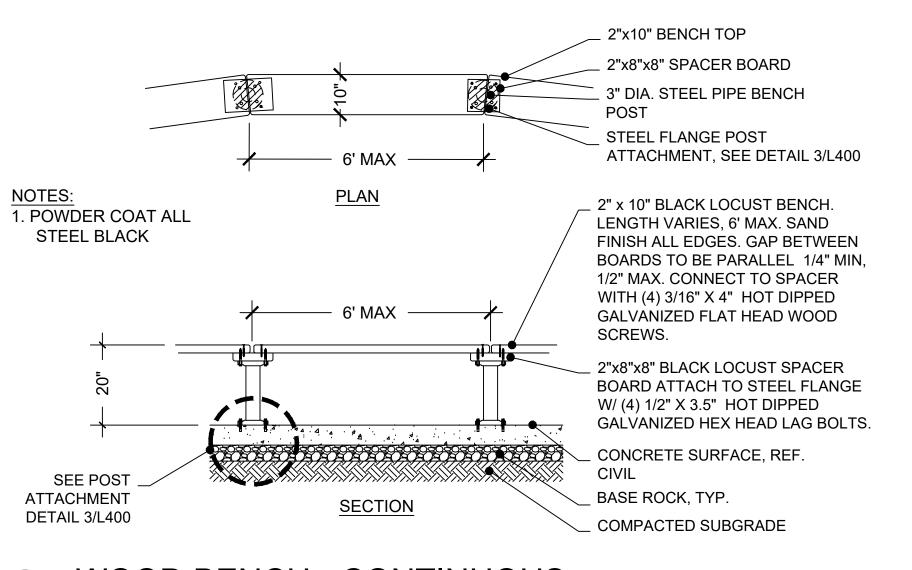

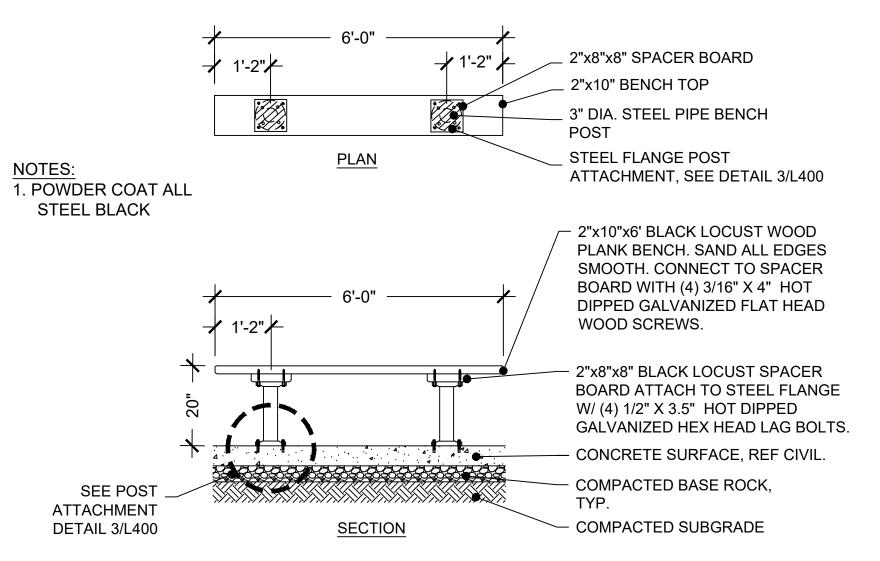

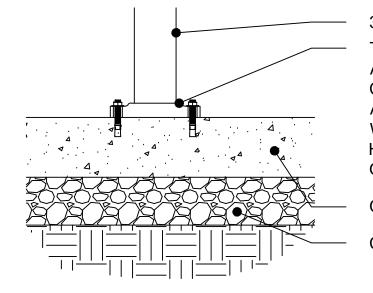

3" DIA. THREADED STEEL PIPE THREADED STEEL FLANGE, SIZE TO ACCEPT 3" DIA. PIPE, ATTACH TO CONCRETE WITH (4) 3-3/4" WEDGE ANCHORS, 1/2" ANCHOR DIA. GALVANIZE WITH NUTS AND LOCK WASHERS. ALL HARDWARE TO BE HOT DIPPED GALVANIZED.


CONCRETE, SEE CIVIL DETAILS

**COMPACTED BASE ROCK** 

1. POWDER COAT ALL STEEL BLACK




RAIN MEASURING POST - IN BIOSWALE

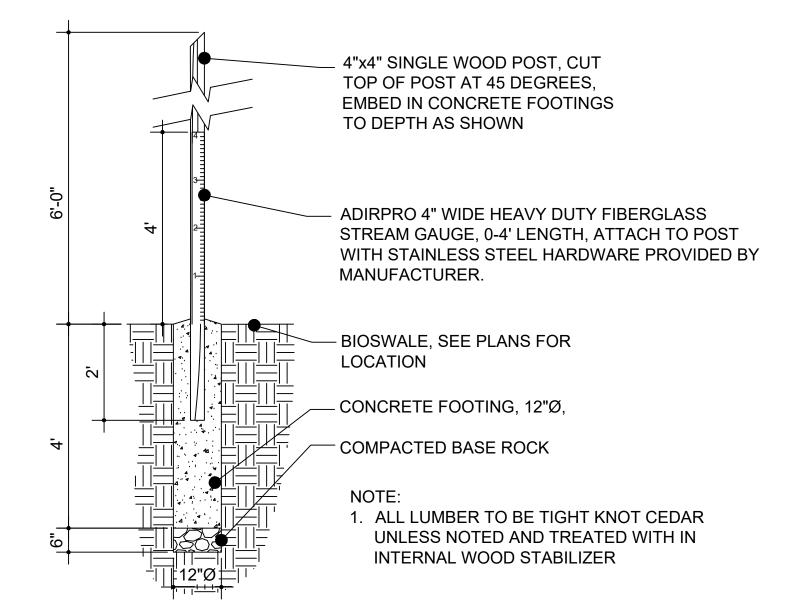








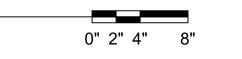


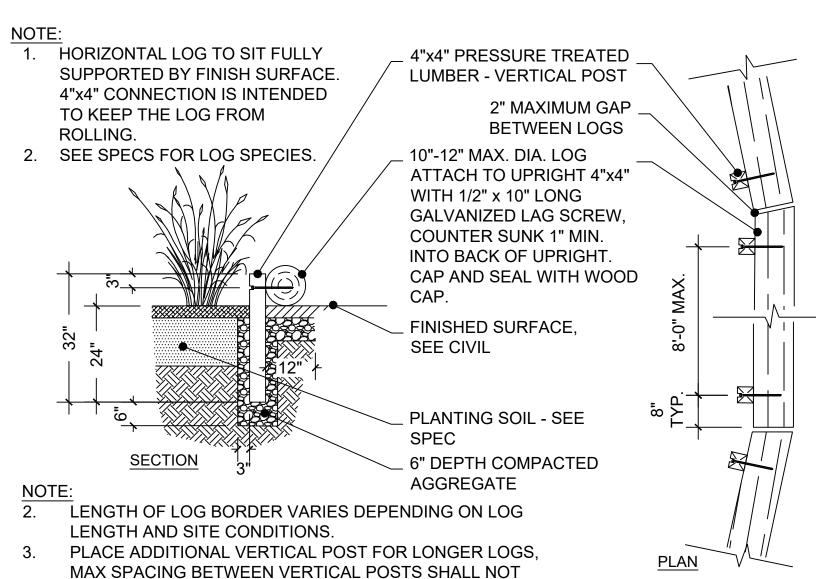


EXCEED 8'-0".

0" 6" 12" 24"


PLAN & SECTION

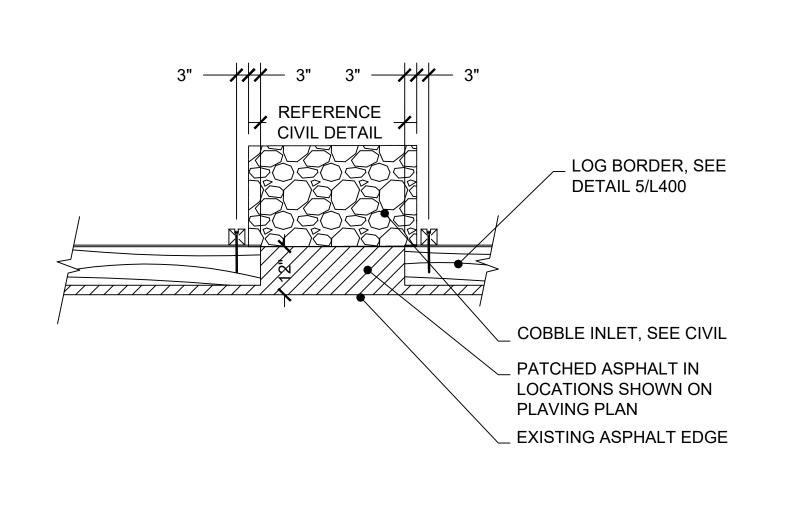

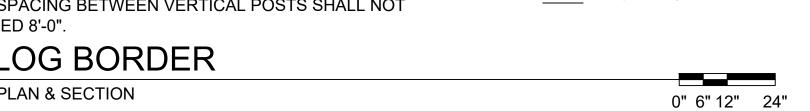


# LOG BORDER @ COBBLE INLET CHANNEL 0" 6" 12" 24"

- 1. THIS DETAIL IS FOR STEPPING STONES IN NON-BIOSWALE AREAS.
- 2. SEE MATERIAL PLANS FOR STEPPING STONE PLACEMENT.
- 3. FINAL PLACEMENT OF ALL STONES MUST BE APPROVED IN THE FIELD BY THE OWNER'S REP. 4. BOULDERS MUST REST IN A STABLE POSITION FULLY SUPPORTING ITS OWN WEIGHT.
- SUBGRADE AND SURROUNDING SOIL MUST BE STABLE AND CAPABLE OF SUPPORTING BOULDERS WITHOUT SETTLING.
- 5. BOULDER EDGES SHALL BE SMOOTH AND ROUNDED. ALL SHARP POINTS AND EDGES SHALL BE REMOVED.
- 6. SPACE BETWEEN STONES TO BE 6"-10".
- 7. HEIGHT DIFFERENCE TO BE 4" MAX.

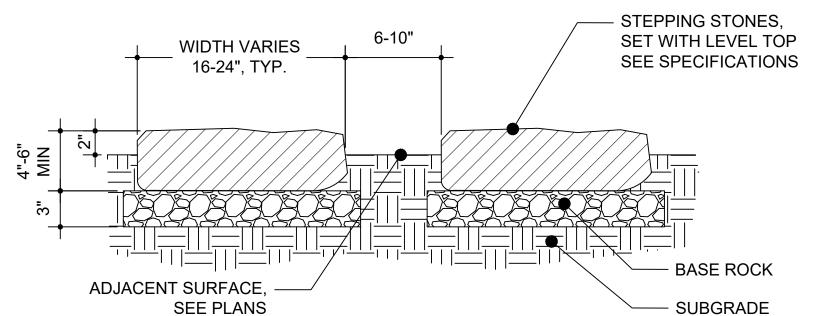



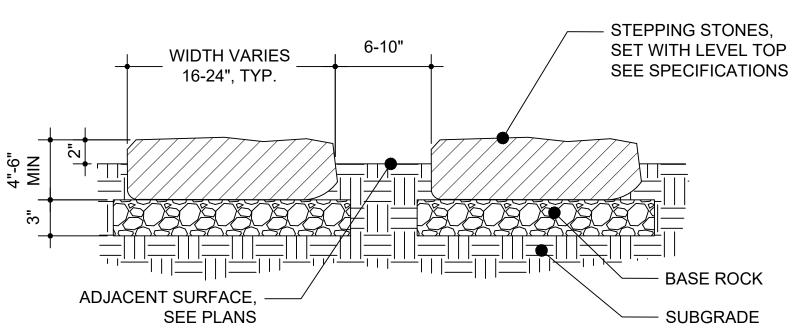

NOT USED

UPLAND PLANTING STEPPING STONE PATH 8

Call before you dig.

0" 2" 4" 8"

L400

SITE NUMBER: 185

ULA-822-14 WAUWATOSA

PROJECT NUMBER: 8176 (DIVISION 2)

SHEET:

STORMWATER SOLUTIONS ENGINEERING ...

247 W. FRESHWATER WAY, SUITE 410

WWW.STORMWATER-SOLUTIONS-

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MAINTENANCE SERVICES

1124 NORTH 11TH STREET

**MILWAUKEE, WI 53205-0259** PHONE: 414-283-4600 FAX: 414-283-4682

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**MILWAUKEE** 

**PUBLIC SCHOOLS** 

DATE:

1<u>1/14/2</u>022

1/23/2023

ZWA

KW

MM

January 2023

**ISSUED FOR:** 

50% CD

95% CD

100% CD

**DRAWN BY:** 

DATE:

**REVIEWED BY:** 


**APPROVED BY:** 

**SEAL AND SIGNATURE** 

MILWAUKEE, WI 53204

PHONE: (414) 810-1245

ENGINEERING.COM

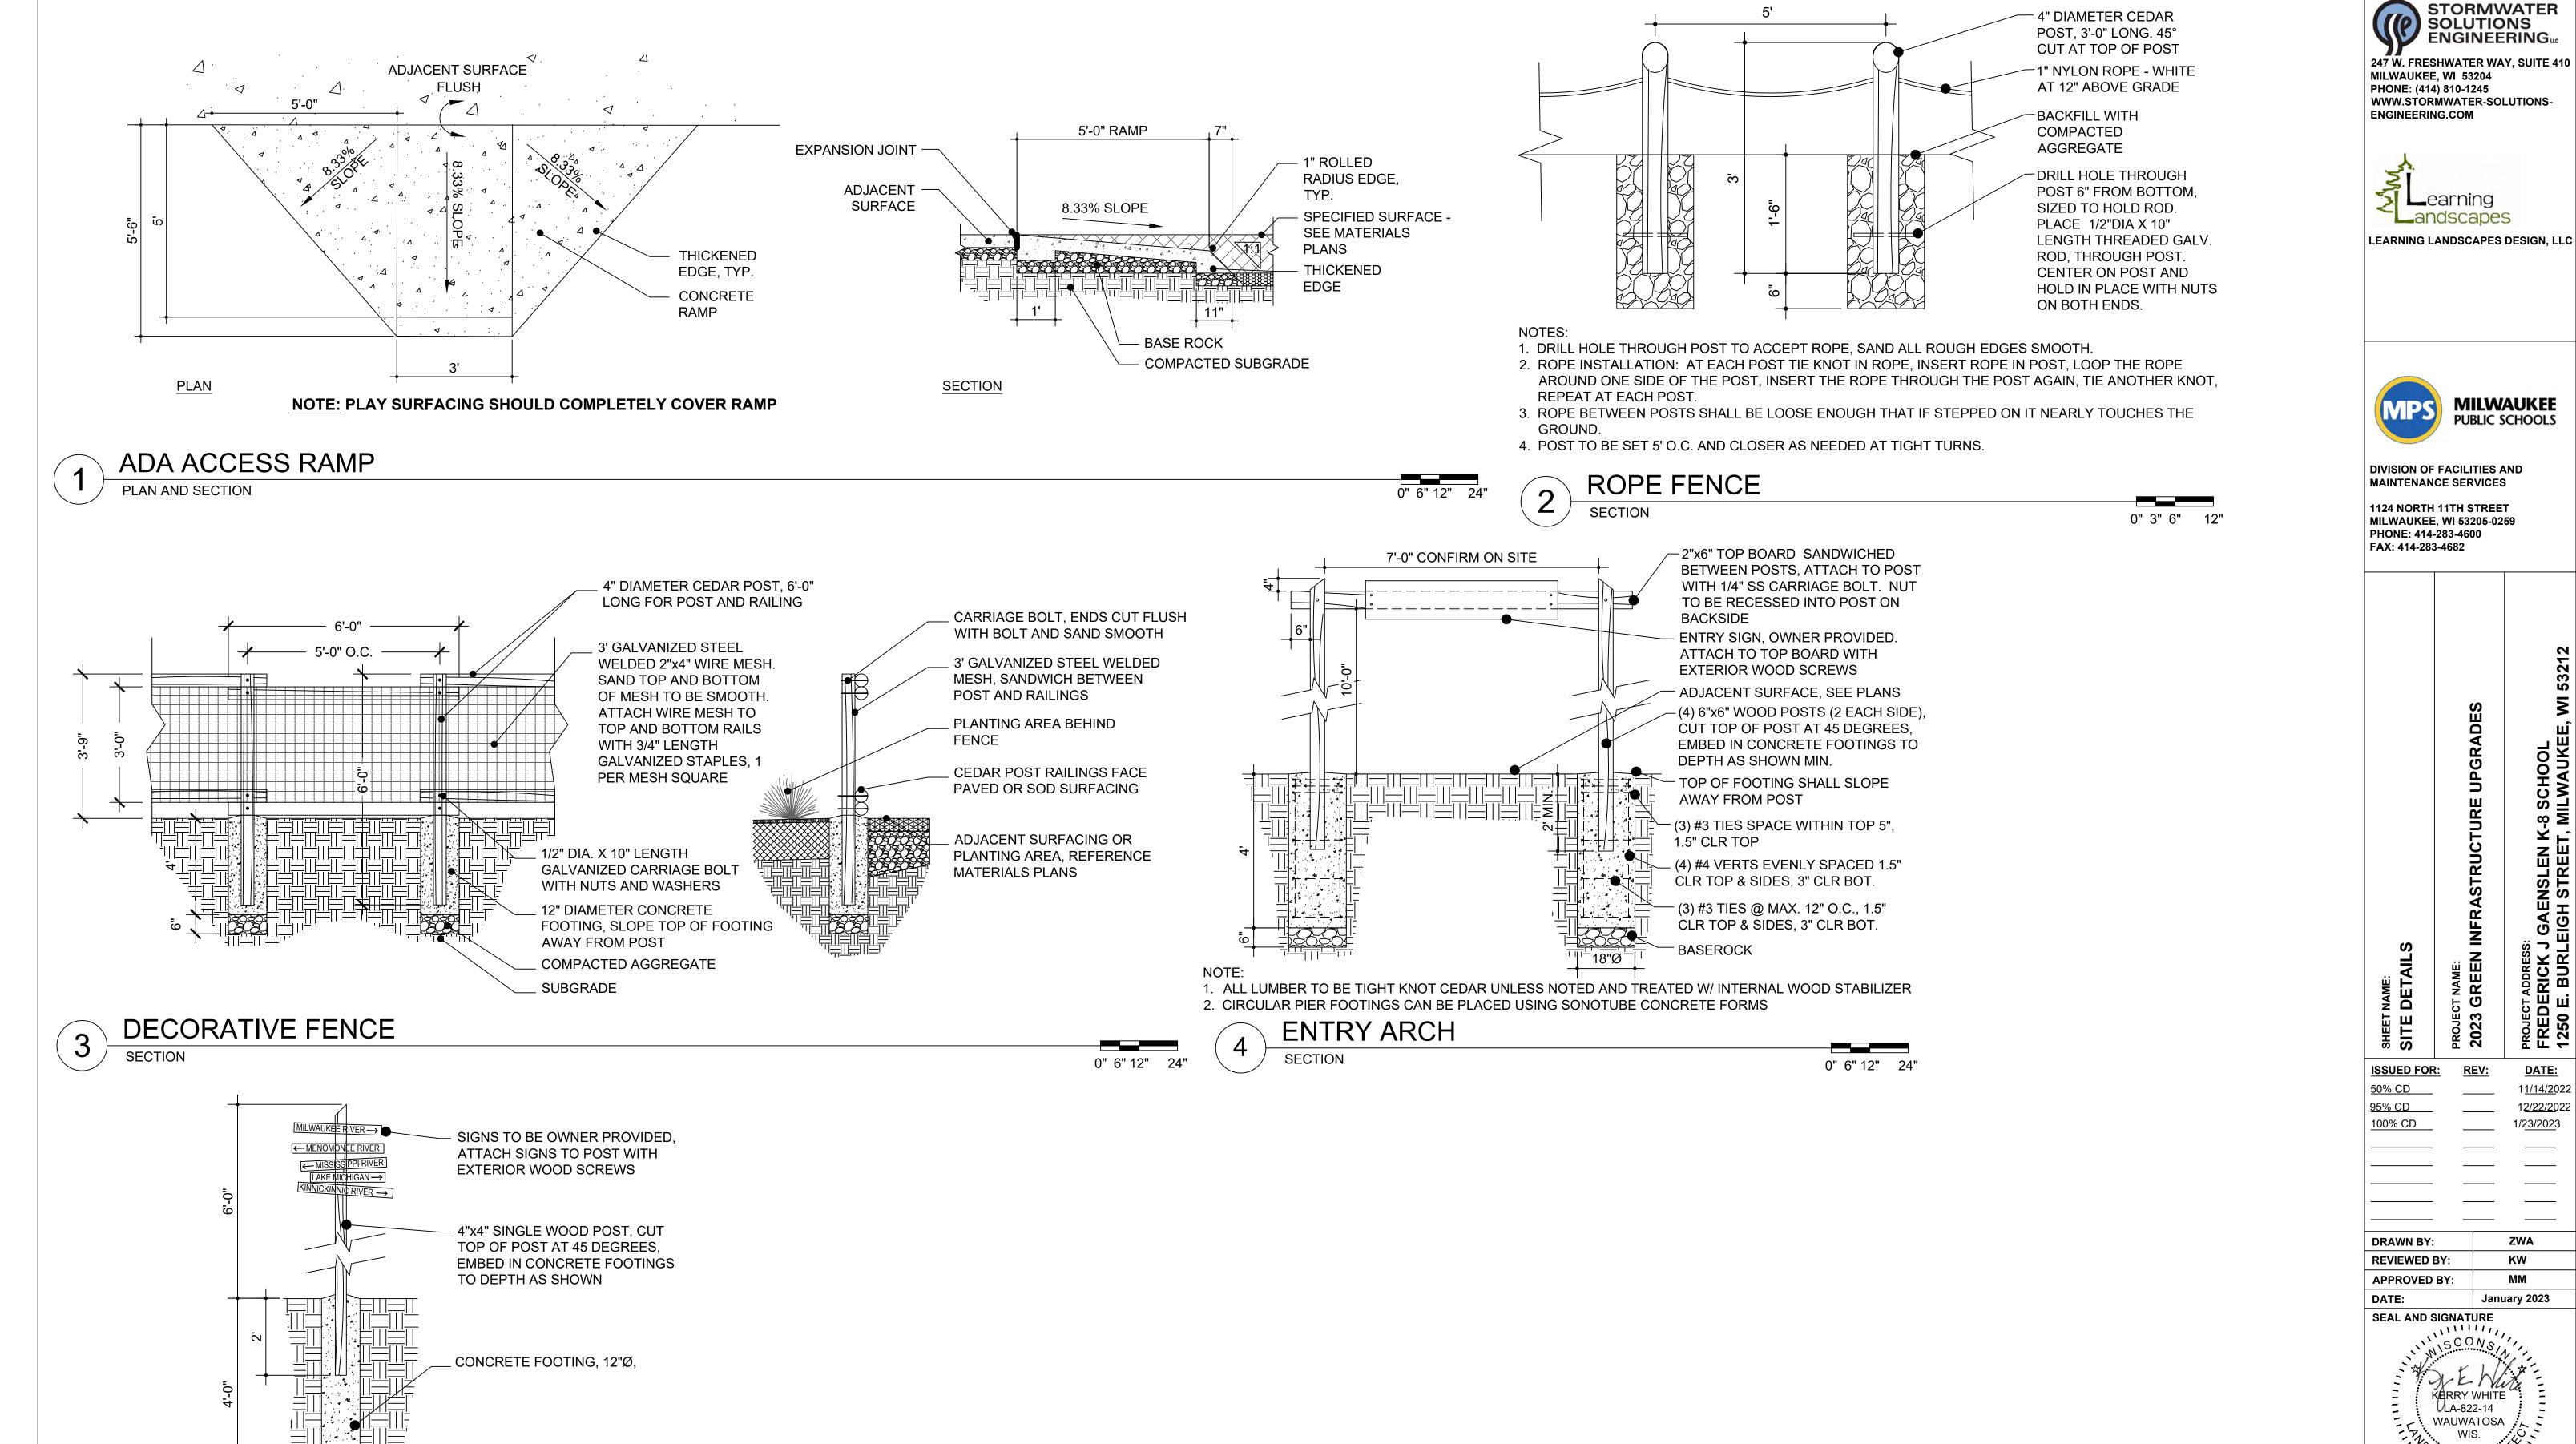

Know what's **below.** Call before you dig.

PROJECT NUMBER: 8176 (DIVISION 2) SITE NUMBER: 185

SHEET:

L401

DATE:

1<u>1/14/2</u>022

ZWA

KW

MM

January 2023

**NOT USED** 

SIGN POST

0" 6" 12" 24"

1. ALL LUMBER TO BE TIGHT KNOT CEDAR UNLESS NOTED AND TREATED WITH IN

INTERNAL WOOD STABILIZER



1 NOT USED	NOT USED	NOT USED	
NOT USED			





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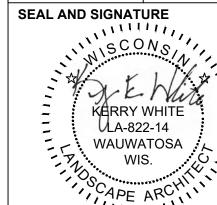
DIVISION OF FACILITIES AND MAINTENANCE SERVICES

1124 NORTH 11TH STREET MILWAUKEE, WI 53205-0259 PHONE: 414-283-4600 FAX: 414-283-4682

SHEET NAME: SITE DETAILS	PROJECT NAME: 2023 GREEN INFRASTRUCTURE UPGRADES	PROJECT ADDRESS: FREDERICK J GAENSLEN K-8 SCHOOL 1250 E. BURLEIGH STREET. MILWAUKEE. WI 53212
SSUED FOR	: REV:	DATE:

50% CD	 1 <u>1/14/2</u> 022
95% CD	 1 <u>2/22/20</u> 22
100% CD	 1/2 <u>3/202</u> 3

DRAWN BY:	ZWA
REVIEWED BY:	KW
APPROVED BY:	ММ
DATE:	January 2023



PROJECT NUMBER: 8176 (DIVISION 2)

SITE NUMBER: 185

SHEET:






PROJECT NAME: OUTDOOR CLASSROM MPS

PROJECT LOCATION: MILWAUKEE, WI

ORDER NUMBER: 72044

**BUILDING TYPE: MSE 16X30** ROOF TYPE: MULTI-RIB BUILDING NUMBER: P14115

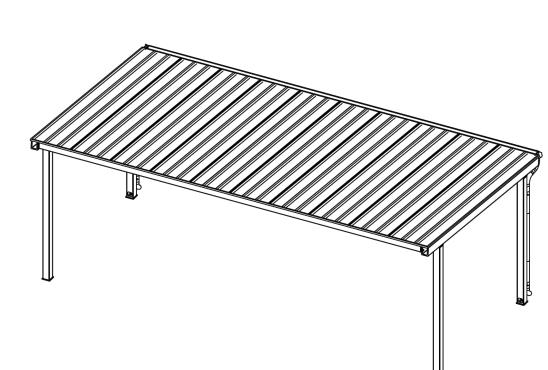

MANUFACTURER NOTES:

SHEET NUMBER DRAWING DESCRIPTION

COVER SHEET

ARCHITECTURAL ELEVATIONS

STRUCTURAL FRAMING PLAN FRAME CONNECTION DETAILS

ELECTRICAL DETAILS 6-6.1 ROOF LAYOUT
7-7.1 ROOF CONNECTION DETAILS

ANCHOR AND FOOTING LAYOUT / DETAILS

**DRAWING LIST:** 

TUBE STEEL
SCHEDULE PIPE
RMT PIPE
LIGHT GAGE COLD FORMED
STRUCTURAL STEEL PLATE
ROOF PANELS (STEEL)
ANCHOR BOLTS A53 (GRADE B) A519 A1003 (GRADE 50) SEE SHEET 2.1

GENERAL NOTES:
UNLESS NOTED OTHERWISE, THIS STRUCTURE WAS DESIGNED TO ONLY SUPPORT WHAT IS SHOWN ON THESE DRAWINGS. POLIGON MUST BE CONTACTED IF ANYTHING ELSE IS TO BE ATTACHED TO THIS STRUCTURE (WALLS, COLUMN WRAPS, RAILINGS, ETC.) SO THE DESIGN OF THIS STRUCTURE CAN BE REVIEWED AND POSSIBLY REVISED.

UNLESS NOTED OTHERWISE, THIS STRUCTURE WAS DESIGNED ASSUMING A 20' SEPARATION BETWEEN ANY ADJACENT STRUCTURE WITH AN EAVE HEIGHT EQUAL TO OR GREATER THAN THE EAVE HEIGHT OF THIS STRUCTURE. IF THAT SEPARATION DOES NOT EXIST, POLIGON MUST BE CONTACTED SO THE DESIGN OF THIS STRUCTURE CAN BE REVIEWED AND POSSIBLY REVISED. STRUCTURAL STEEL SHALL BE DETAILED, FABRICATED, AND ERECTED IN ACCORDANCE WITH THE LATEST EDITION OF THE AMERICAN INSTITUTE OF STEEL CONSTRUCTION (AISC) SPECIFICATION MANUAL.

ALL WELDING IS PERFORMED BY AMERICAN WELDING SOCIETY CERTIFIED WELDERS AND CONFORMS TO THE LATEST EDITION OF AWS D1.1 OR D1.3 AS REQUIRED. PARTS SHOWN MAY BE UPGRADED DUE TO STANDARDIZED FABRICATION.
REFER TO THE SHIPPING BILL OF MATERIALS AND FINAL INSTALLATION INSTRUCTIONS
INCLUDED WITH THE STRUCTURE FOR POSSIBLE SUBSTITUTIONS AND IMPROVEMENTS. FOR PROPER FIELD INSTALLATION OF THE BUILDING IT IS RECOMMENDED THAT THE PRIMARY FRAME INSTALLER AND THE ROOF INSTALLER HAVE A MINIMUM FIVE (5) YEARS DOCUMENTED EXPERIENCE INSTALLING THIS TYPE OF PRODUCT.

FOR PROPER FIELD INSTALLATION OF THE BUILDING IT IS RECOMMENDED THAT ELECTRIC WIRING, IF REQUIRED, BE RUN THROUGH THE STRUCTURAL MEMBERS BEFORE THE BUILDING IS ERECTED. CERTIFICATES:
MIAMI-DADE COUNTY CERTIFICATE OF COMPETENCY NO. 21-0819.13
PCI (POWDER COATING INSTITUTE) 4000 CERTIFIED

FABRICATOR APPROVALS:
CITY OF PHOENIX, AZ APPROVED FABRICATOR #C08-2010
CITY OF LOS ANGELES, CA APPROVED FABRICATOR #FB01596
CITY OF RIVERSIDE, CA APPROVED FABRICATOR #SF\_000042
CITY OF HOUSTON, TX APPROVED FABRICATOR #470
CLARK COUNTY, NV APPROVED FABRICATOR #264
STATE OF UTAH APPROVED FABRICATOR 02008-14
AISC APPROVED FABRICATOR C-00018751

# **DESIGN CRITERIA:**

2015 INTERNATIONAL BUILDING CODE RISK CATEGORY: II

DEAD LOAD: ROOF DEAD LOAD: 2 PSF FRAME DEAD LOAD: SELF WEIGHT


LIVE LOAD: ROOF LIVE LOAD: 20 PSF


SNOW DESIGN DATA: GROUND SNOW LOAD (Pg): 30 PSF
FLAT ROOF SNOW LOAD (Pf): 25 PSF
SNOW EXPOSURE FACTOR (Ce): 1.0
SNOW LOAD IMPORTANCE FACTOR (Is): 1.0
THERMAL FACTOR (Ct): 1.2


WIND DESIGN DATA: BASIC WIND SPEED (V): 115 MPH GUST EFFECT FACTOR (G): 0.85 INTERNAL PRESSURE COEFFICIENT (GCpi): 0


EISMIC DESIGN DATA:

STEEL SYSTEMS NOT SPECIFICALLY DETAILED
FOR SEISMIC RESISTANCE
SEISMIC IMPORTANCE FACTOR (Ie): 1.0
SEISMIC DESIGN CATEGORY: C SEISMIC SITE CLASS: D SEE CALCULATIONS FOR ADDITIONAL DATA ADDITIONAL CRITERIA:

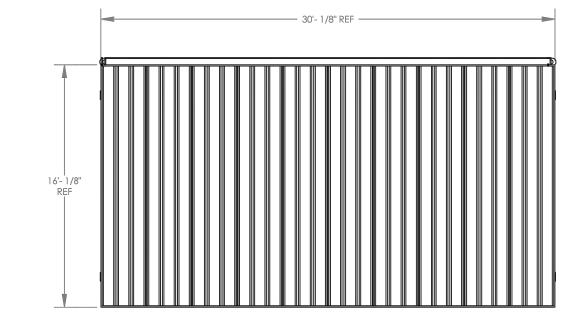

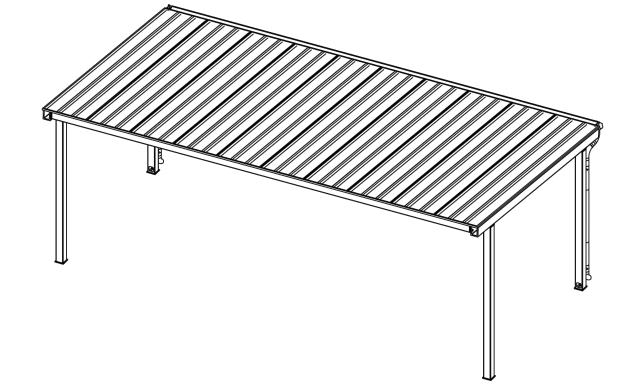

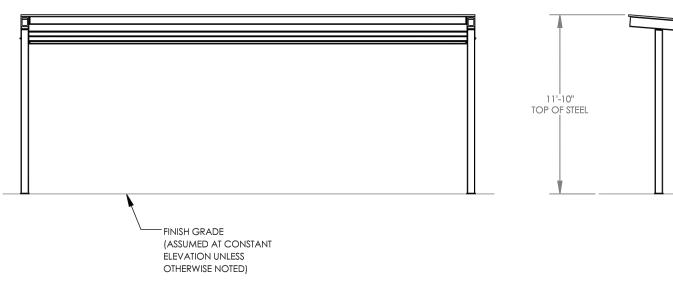

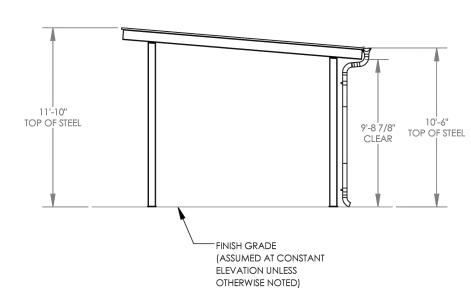



# SHADE SHELTER - COVER SHEET

NOT TO SCALE

SHADE SHELTER - ARCHITECTURAL ELEVATIONS

NOT TO SCALE

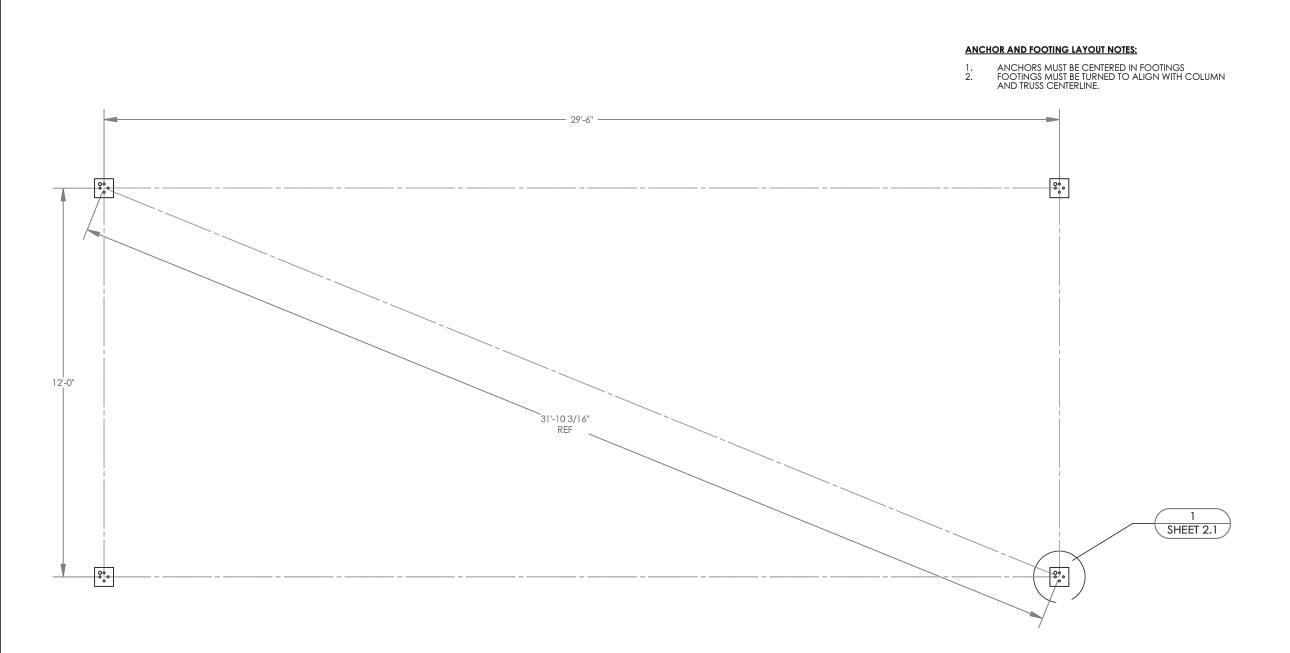

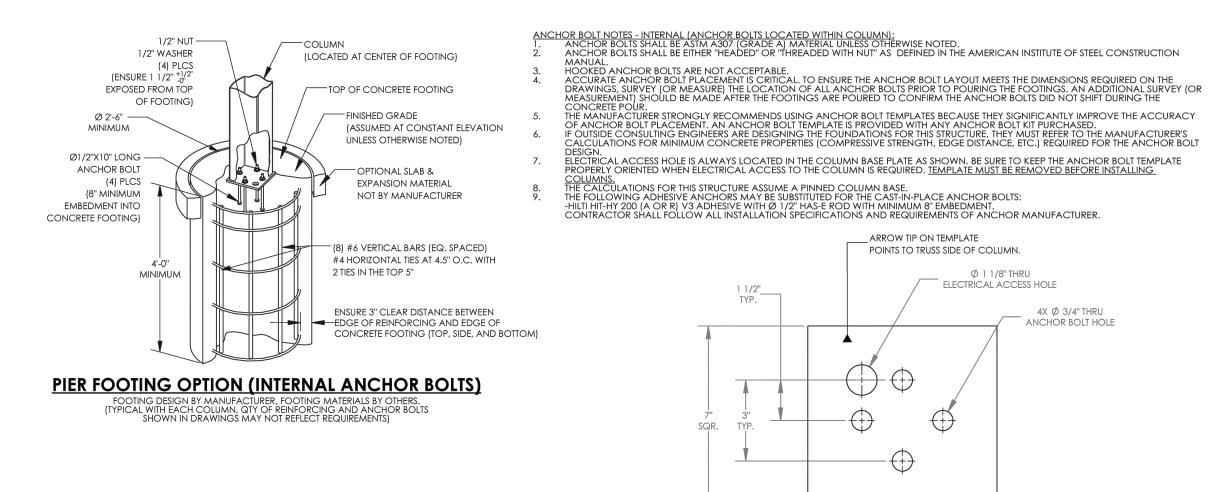

THE FOUNDATION DESIGN SHOWN ON THESE DRAWINGS IS NOT SITE SPECIFIC, BUT BASED ON THE PRESUMPTIVE ALLOWABLE FOUNDATION PRESSURES IN CHAPTER 18 OF THE BUILDING CODE (CLASS 5 SOIL). THE BUILDING OFFICIAL IN THE JURISDICTION IN WHICH THIS STRUCTURE IS LOCATED MAY REQUIRE A SITE SPECIFIC GEOTECHNICAL REPORT OR LETTER FROM A QUALIFIED LOCAL PROFESSIONAL ENGINEER ATTESTING TO WHETHER THE ACTUAL SITE CONDITIONS MEET THE ASSUMPTIONS IDENTIFIED ABOVE

Call before you dig.

1 ANCHOR BOLT PATTERN 2 BASE PLATE THICKNESS: 1/2"

SHADE SHELTER - ANCHOR AND FOOTING LAYOUT

NOT TO SCALE

SHADE SHELTER - ANCHOR AND FOOTING DETAILS

SITE NUMBER: 185 SHEET:

L403

STORMWATER

**ENGINEERING**<sub>uc</sub>

STORMWATI SOLUTIONS ENGINEERING

MILWAUKEE, WI 53204

PHONE: (414) 810-1245

**ENGINEERING.COM** 

247 W. FRESHWATER WAY, SUITE 410

WWW.STORMWATER-SOLUTIONS-

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**DIVISION OF FACILITIES AND** 

MAINTENANCE SERVICES

1124 NORTH 11TH STREET

**MILWAUKEE, WI 53205-0259** 

PHONE: 414-283-4600 FAX: 414-283-4682

**ISSUED FOR:** 

50% CD

95% CD

100% CD

DRAWN BY:

DATE:

**REVIEWED BY:** 

**APPROVED BY:** 

**SEAL AND SIGNATURE** 

WILLIAM TO THE STATE OF THE STA ,,scons,

KARRY WHITE ULA-822-14

WAUWATOSA WIS.

CAPE ARCY

PROJECT NUMBER: 8176 (DIVISION 2)

DATE:

1<u>1/14/2</u>022

12/22/2022

ZWA

KW


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January 2023

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SHADE SHELTER - STRUCTURAL FRAMING PLAN

NOT TO SCALE



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DIVISION OF FACILITIES AND MAINTENANCE SERVICES

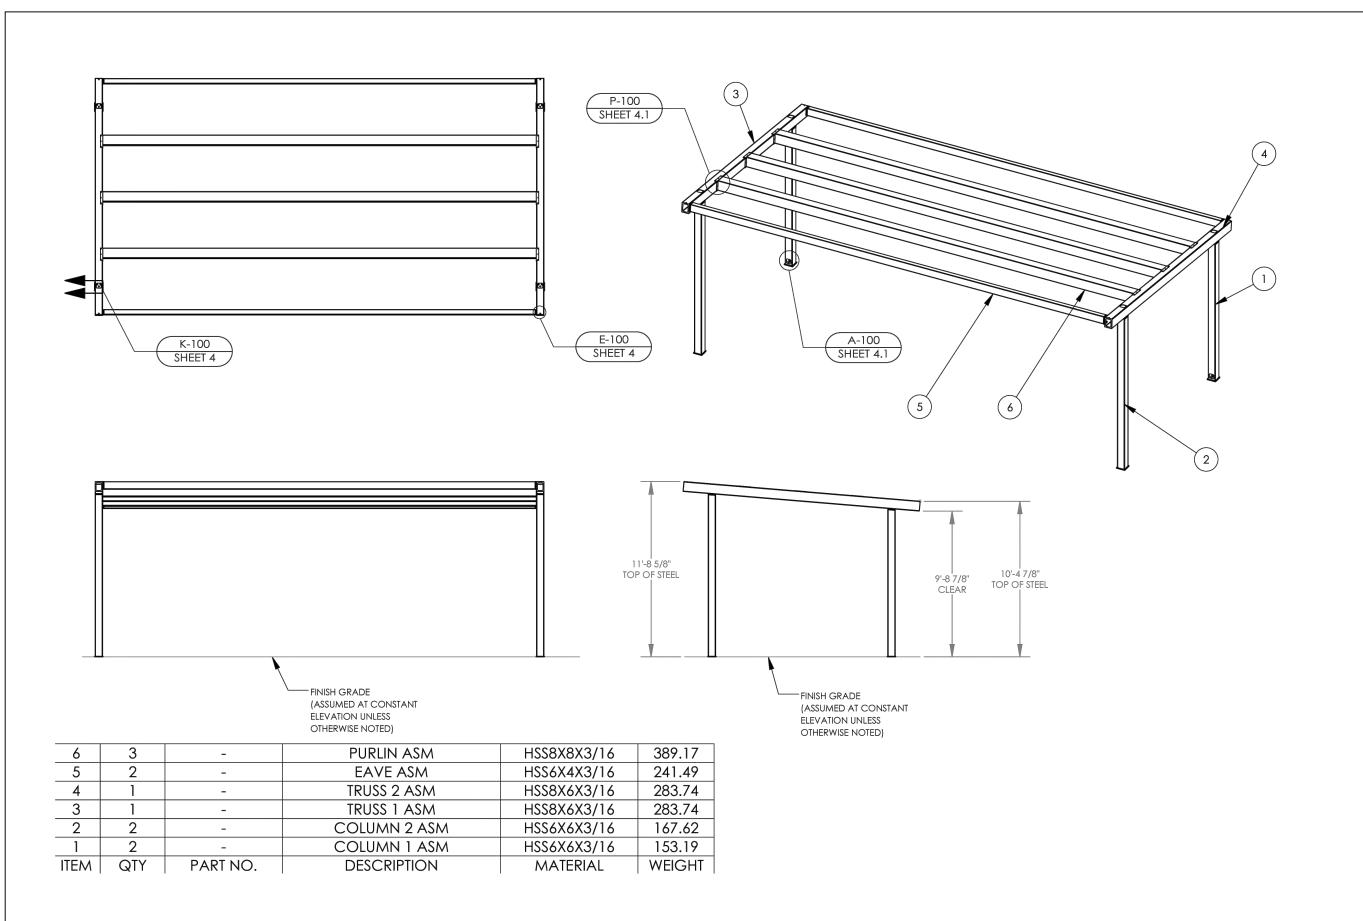1124 NORTH 11TH STREET MILWAUKEE, WI 53205-0259 PHONE: 414-283-4600 FAX: 414-283-4682

PROJECT NAME: 2023 GREEN INFRASTRUCTURE UPGRADES	PROJECT ADDRESS: FREDERICK J GAENSLEN K-8 SCHOOL 1250 E. BURLEIGH STREET, MILWAUKEE. WI 53
TRUCTURE UPGRADES	SLEN K-8 SCHOOL TREET. MILWAUKEE. WI 53

ISSUED FOR:	REV:	DATE:
50% CD		1 <u>1/14/2</u> 022
95% CD		1 <u>2/22/20</u> 22
100% CD		1/2 <u>3/202</u> 3

SHEET NAME:
SITE DETAILS

DRAWN BY:	ZWA
REVIEWED BY:	KW
APPROVED BY:	ММ
DATE:	January 2023
SEAL AND SIGNAT	UDE




PROJECT NUMBER: 8176 (DIVISION 2)

SITE NUMBER: 185

SHEET:



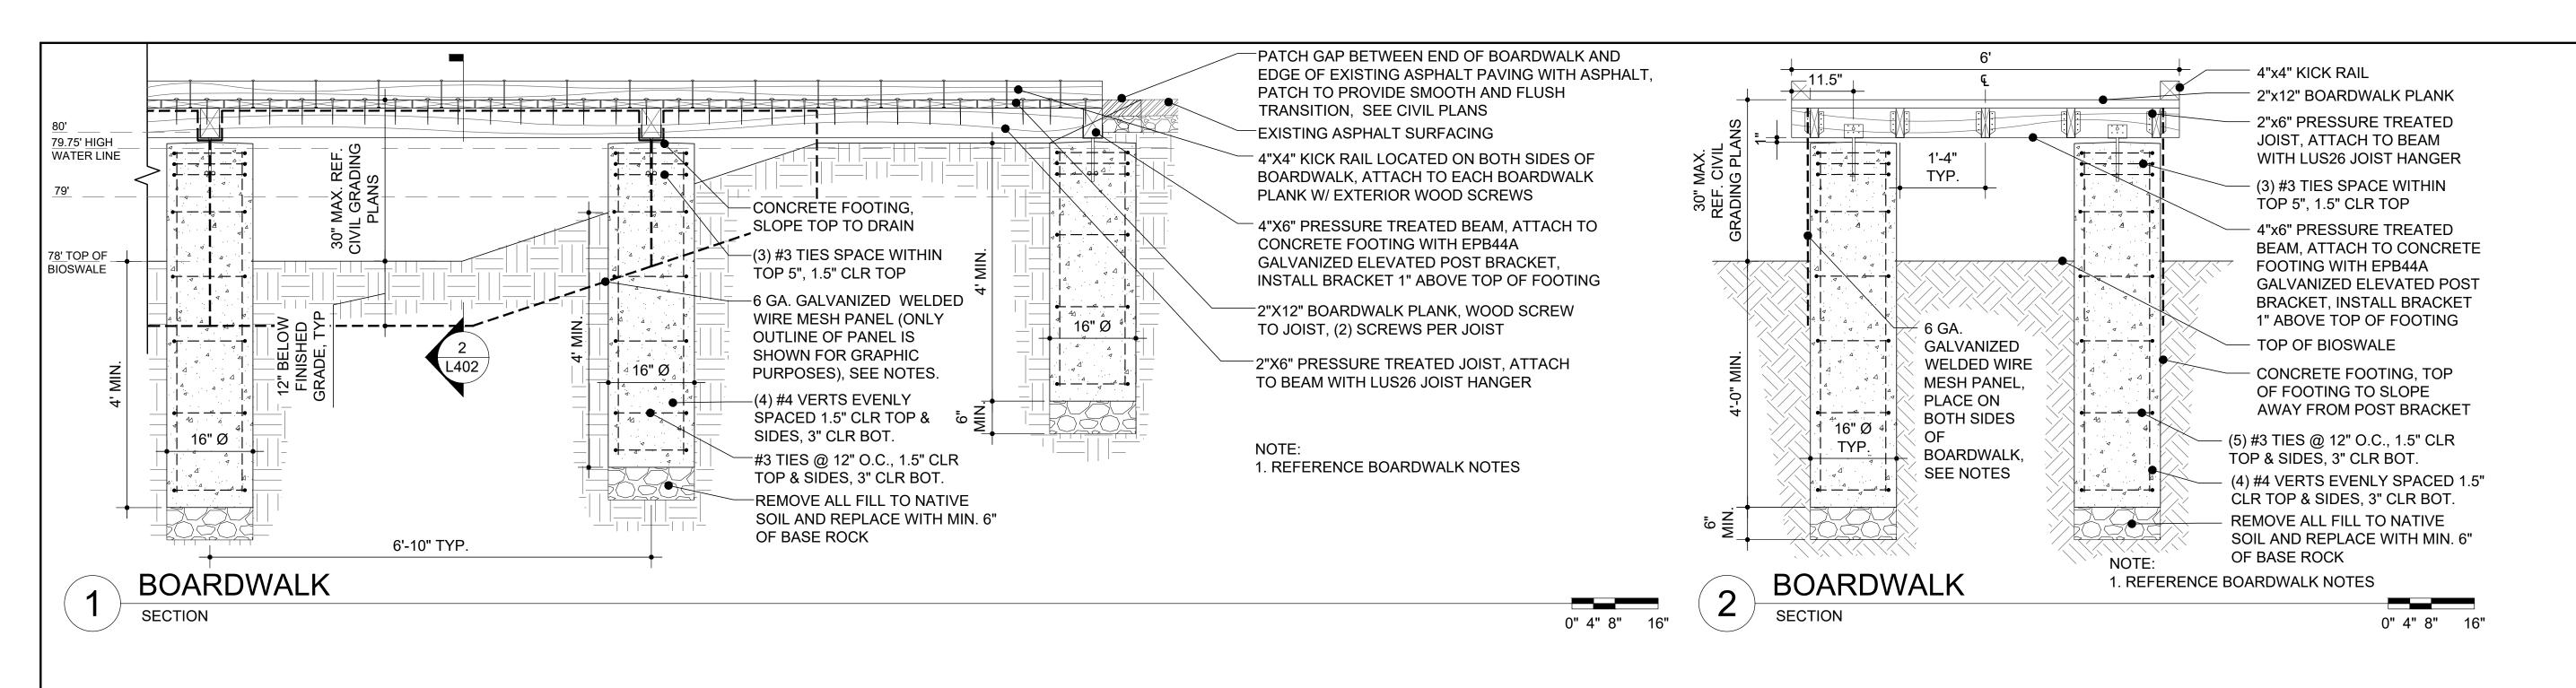

# **BOARDWALK NOTES:**

- 1. ALL WOOD TO BE TREATED W/ INTERNAL WOOD STABILIZER IF AN ALTERNATIVE IS NOT NOTED.
- 2. ALL WOOD TO BE FREE FROM SPLINTERS, WARPING AND CHECKING OVER 1/2".
- 3. PLACE PAVERS DIRECTLY UP TO EDGE OF BOARDWALK ON OTHER END. TOP OF PAVERS TO BE FLUSH WITH TOP OF BOARDWALK PLANKS.
- 4. NON-STRUCTURAL 6 GA. GALVANIZED WELDED WIRE MESH PANEL NO OPENINGS GREATER THAN 3.5" ALLOWED. ATTACH PANEL TO OUTSIDE FACE OF CONCRETE FOOTING WITH 3/16" x 1-3/4" TAPCON WHITE STAR FLAT HEAD CONCRETE ANCHORS AND GALVANIZED 3/16" HALF CLIP CABLE CLAMP (GRAINGER ITEM: 6RNA8 OR APPROVED EQUAL). ATTACH TO BOARDWALK JOIST WITH GALVANIZED EXTERIOR SCREWS AND SAME CABLE CLAMP. 8" MAX SPACING ON CLAMPS. BOTTOM OF PANEL TO BE BURIED 12" BELOW FINISHED GRADE. PANEL TO BE CONTINUOUS BETWEEN CONCRETE FOOTINGS.
- 5. DESIGN LIVE LOAD = 100 PSF
- 6. WOOD SPECIES AND GRADE = TREATED SOUTHERN PINE #1
- 7. ALL CONNECTORS AND FASTENERS TO BE CORROSION RESISTANCE FOR EXPOSURE
- 8. CONCRETE COMPRESSIVE STRENGTH = 3,500 PSI
- 9. REINFORCED STEEL = GRADE 60 10. ASSUMED ALLOWABLE SOIL BEARING CAPACITY = 2,000PSF

**MILWAUKEE PUBLIC SCHOOLS** 

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1124 NORTH 11TH STREET **MILWAUKEE, WI 53205-0259** PHONE: 414-283-4600 FAX: 414-283-4682


SITE DETAILS	PROJECT NAME: 2023 GREEN INFRASTRUCTURE UPGRADES	PROJECT ADDRESS: FREDERICK J GAENSLEN K-8 SCHOOL 1250 E. BURLEIGH STREET, MILWAUKEE, WI 532
UED FOR	R: REV:	<u>DATE:</u>
CD CD	R: REV:	<u>DATE:</u> 1 <u>1/14/2</u> 022 1 <u>2/22/2</u> 022
	R: REV:	1 <u>1/14/20</u> 22


ZWA **DRAWN BY: REVIEWED BY: APPROVED BY:** January 2023

**SEAL AND SIGNATURE** 

PROJECT NUMBER: 8176 (DIVISION 2) SITE NUMBER: 185



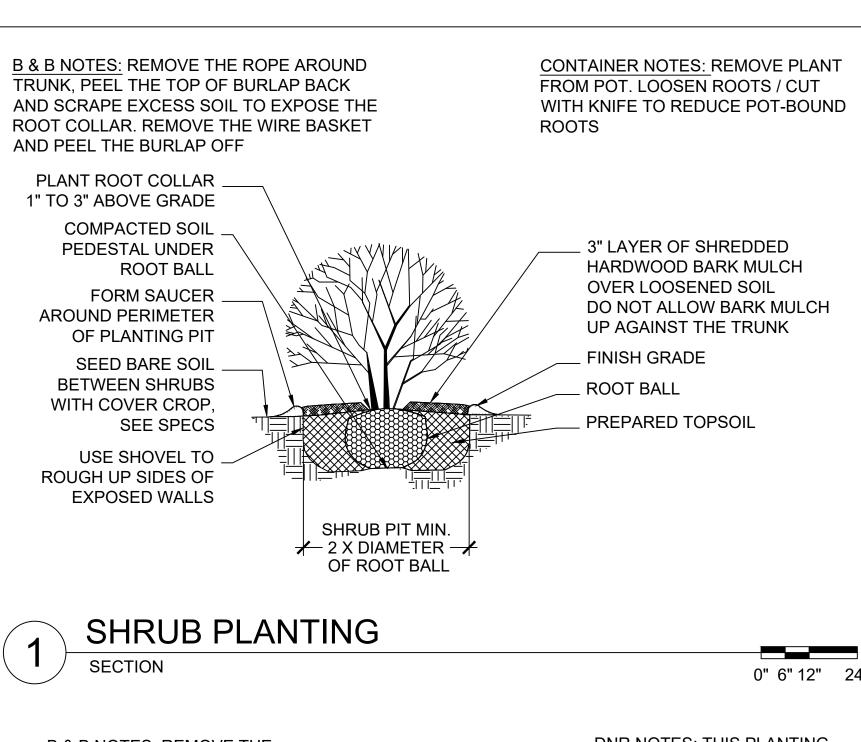


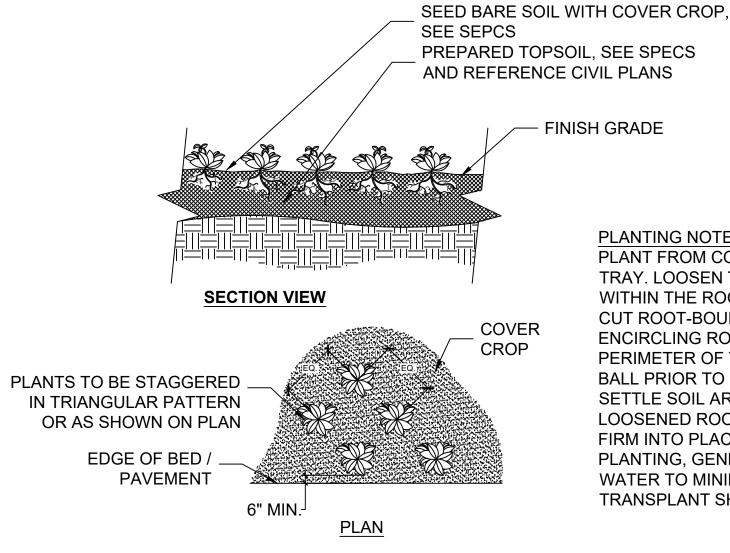

PLUG PLANTING

PLANTING NOTES: REMOVE PLANT FROM CONTAINER OR TRAY. LOOSEN THE ROOTS WITHIN THE ROOT BALL AND **CUT ROOT-BOUND** ENCIRCLING ROOTS ON THE PERIMETER OF THE ROOT BALL PRIOR TO PLANTING. SETTLE SOIL AROUND THE LOOSENED ROOT BALL AND FIRM INTO PLACE. UPON PLANTING. GENEROUSLY WATER TO MINIMIZE TRANSPLANT SHOCK.

0" 6" 12" 24"

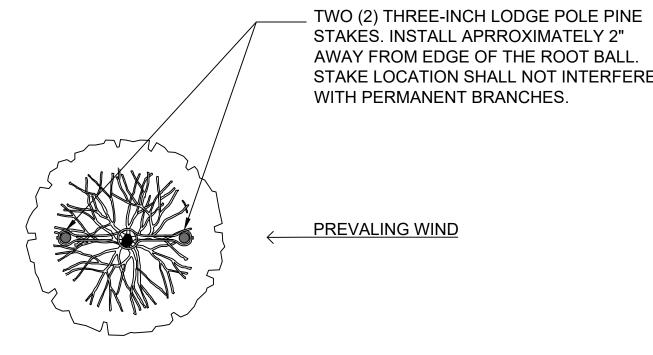

REFERENCE DETAIL 3/L501 FOR TREES LOCATED IN OPEN LAWN AREAS AND AS INDICATED ON THE PLANS FOR TREE INSTALLATION AND PROTECTION STAKING TO BE USED IN PLACE OF THIS DETAIL.



STAKE LOCATION SHALL NOT INTERFERE

**DIVISION OF FACILITIES AND** MAINTENANCE SERVICES

0" 6" 12" 24'

1124 NORTH 11TH STREET **MILWAUKEE, WI 53205-0259** PHONE: 414-283-4600 FAX: 414-283-4682

STORMWATER SOLUTIONS ENGINEERING...

247 W. FRESHWATER WAY, SUITE 410

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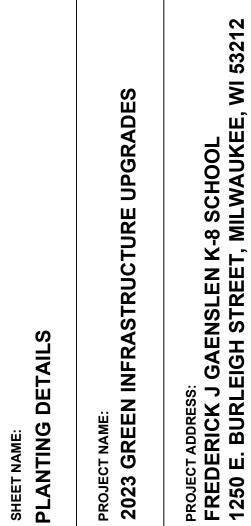
**MILWAUKEE** 

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MILWAUKEE, WI 53204

PHONE: (414) 810-1245

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<b>"</b>	,	
ISSUED FOR	REV:	DATE:
50% CD		1 <u>1/14/2</u> 0
95% CD		1 <u>2/22/2</u> 0
100% CD		1/23/2023

DRAWN BY:	ZWA
REVIEWED BY:	KW
APPROVED BY:	MM
DATE:	January 2023

**SEAL AND SIGNATURE** 


KERRY WHITE ULA-822-14 WAUWATOSA WIS. CAPE ARCY


PROJECT NUMBER: 8176 (DIVISION 2)

SITE NUMBER: 185

SHEET: L500

Know what's **below. Call** before you dig.

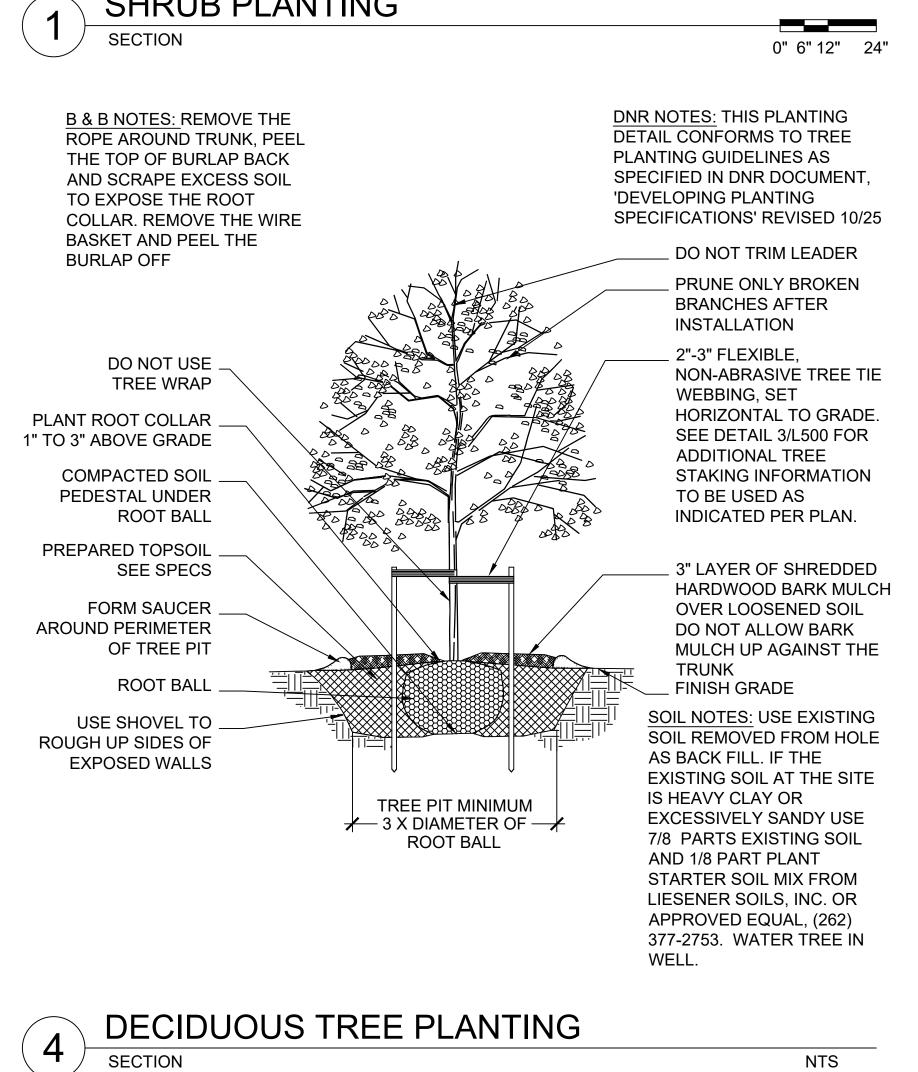

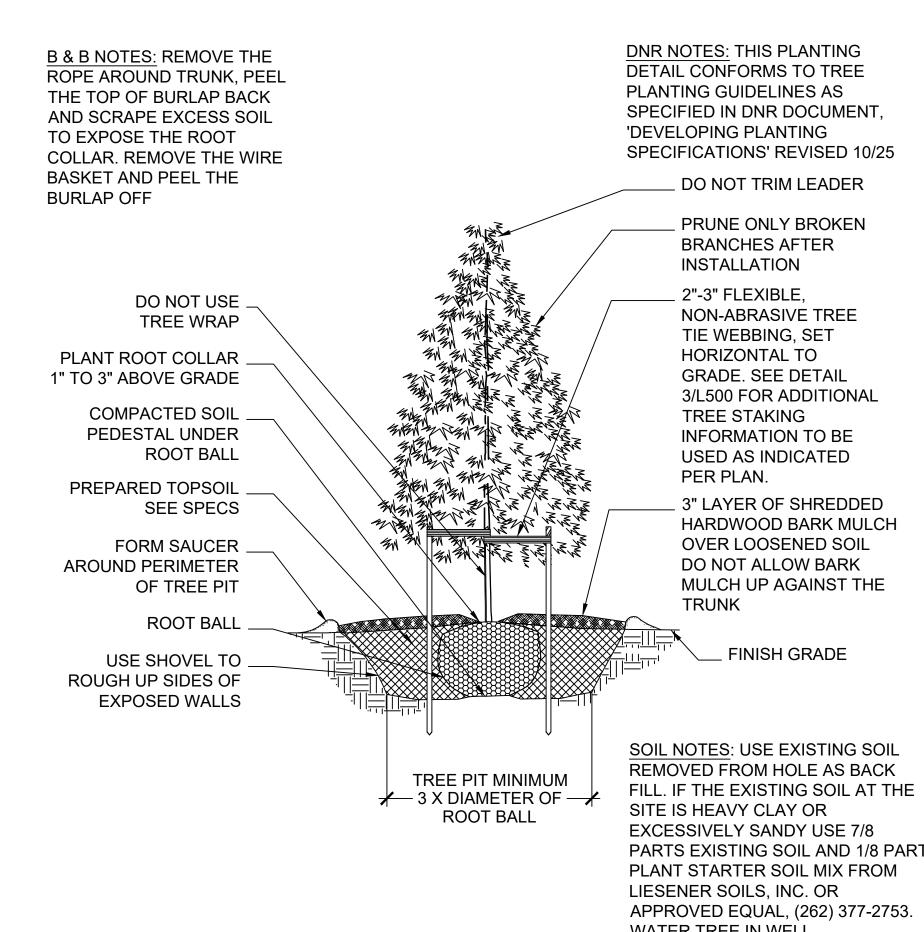


PARTS EXISTING SOIL AND 1/8 PART WATER TREE IN WELL.

**EVERGREEN TREE PLANTING SECTION** 

5

NTS

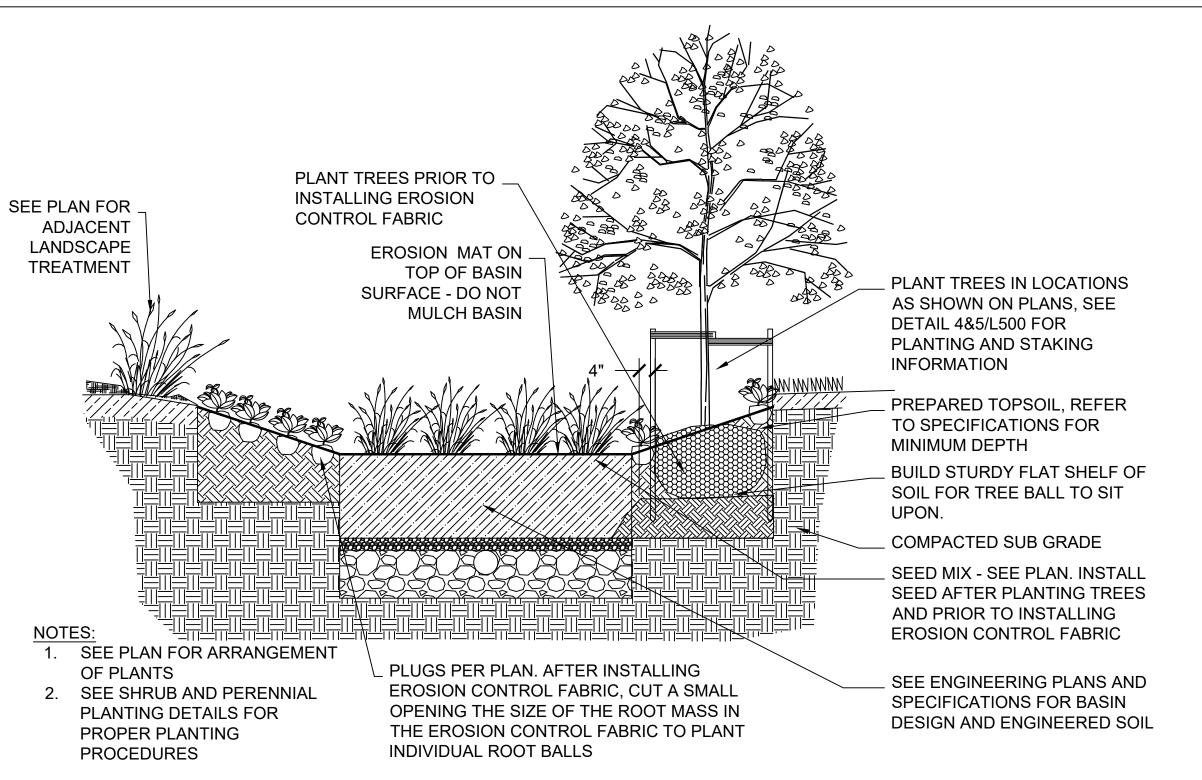


# BIOFILTRATION BASIN WITH MIXED PLANT TYPES


FOUR (4) THREE-INCH Ø LODGE POLE PINE

SECTION

PROTECTION.

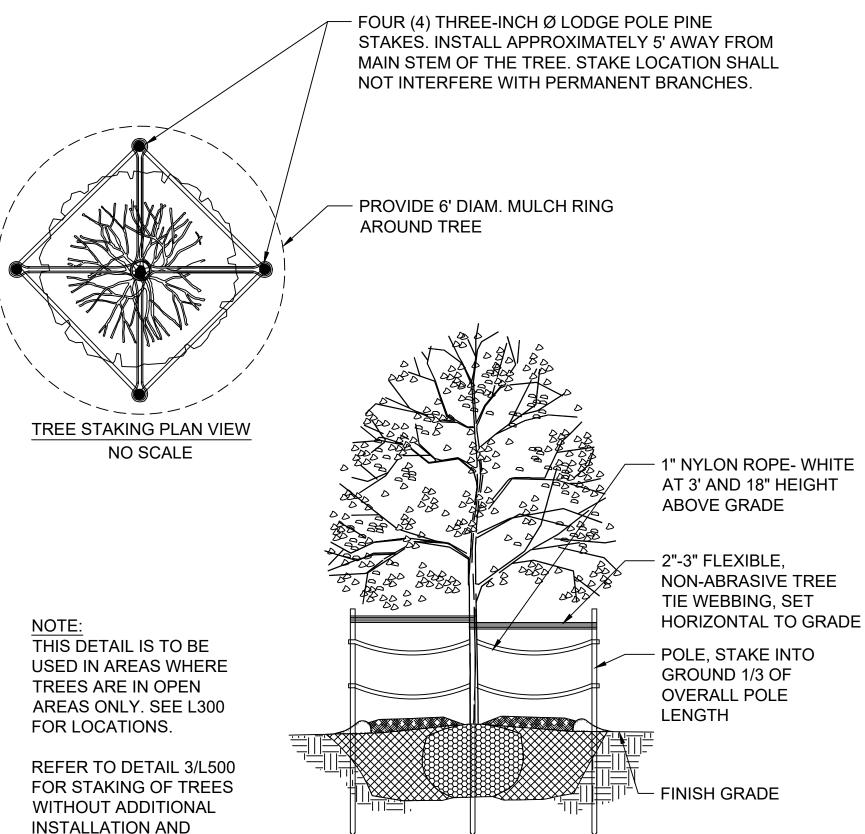

## TREE INSTALLATION AND PROTECTION STAKING SECTION NTS

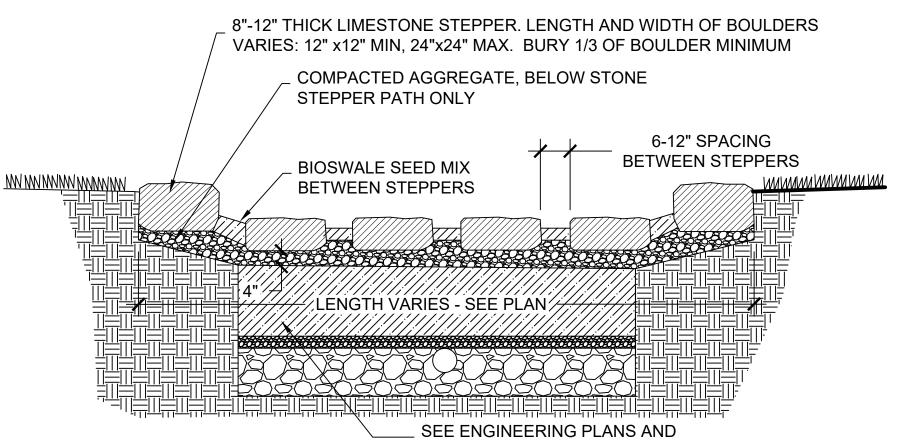

SPECIFICATIONS FOR BASIN DESIGN

- HEIGHT DIFFERENCE TO BE 6" MAXIMUM 2. BOULDERS MUST REST IN A STABLE POSITION FULLY SUPPORTING ITS OWN WEIGHT. SUBGRADE AND SURROUNDING SOIL MUST BE STABLE AND CAPABLE OF SUPPORTING BOULDERS WITHOUT
- 3. BOULDER EDGES SHALL BE SMOOTH AND ROUNDED. ALL SHARP POINTS AND EDGES SHALL BE REMOVED.

**BIOSWALE STEPPING STONE PATH** 

0" 6" 12" 24"



# PLANTING NOTES

- 1. CONTRACTOR SHALL INSPECT THE SITE AND BECOME FAMILIAR WITH EXISTING CONDITIONS RELATED TO THE NATURE AND SCOPE OF
- 2. CONTRACTOR SHALL VERIFY LOCATION OF UNDERGROUND AND ABOVE GROUND UTILITIES AND PROVIDE THE NECESSARY PROTECTION BEFORE CONSTRUCTION BEGINS.
- 3. CONTRACTOR SHALL VERIFY PLAN LAYOUT AND DIMENSIONS SHOWN AND BRING TO THE ATTENTION OF THE PRIME CONSULTANT DISCREPANCIES WHICH MAY COMPROMISE THE DESIGN AND/OR INTENT OF THE PROJECT'S LAYOUT.
- 4. CONTRACTOR SHALL ASSURE COMPLIANCE WITH APPLICABLE CODES AND REGULATIONS GOVERNING THE WORK AND/OR MATERIALS SUPPLIED.
- CONTRACTOR SHALL PROTECT EXISTING ROADS, CURBS/GUTTERS, TRAILS, SIDEWALKS, TREES, LAWNS AND OTHER SITE ELEMENTS DURING CONSTRUCTION OPERATIONS. DAMAGE TO SAME SHALL BE REPAIRED AT NO ADDITIONAL COST TO THE OWNER.
- 6. CONTRACTOR TO MAINTAIN EXISTING GRADE WITHIN THE TREE CANOPY LINE (MINIMUM) OF TREES TO BE PRESERVED AND PROTECTED UNLESS OTHERWISE INDICATED ON THE PLANS. REFERENCE SPECIFICATIONS FOR ADDITIONAL TREE PROTECTION INFORMATION.
- 7. NO PRUNING SHALL BE PERFORMED ON TREES TO BE PRESERVED EXCEPT BY APPROVED ARBORIST.
- 8. NO EQUIPMENT SHALL OPERATE INSIDE THE DRIP LINE (AT MINIMUM) OF TREES TO BE PRESERVED.
- 9. HAND WORK ONLY AND NO MACHINERY OR MATERIAL STORAGE WITHIN DRIP LINE OF TREES TO BE PRESERVED.
- 10. EXISTING TREES TO REMAIN SHALL BE FERTILIZED AND PRUNED TO REMOVE DEAD WOOD, DAMAGED, AND/OR RUBBING BRANCHES.
- 11. CONTRACTOR SHALL COORDINATE THE PHASES OF CONSTRUCTION AND PLANTING INSTALLATION WITH OTHER CONTRACTORS WORKING ON THE SITE.
- 12. CONTRACTOR TO COMPLETE SOIL PREPARATION PER SPECIFICATIONS.
- 13. CONTRACTOR TO SUPPLY AND INSTALL SOD, TREES, SHRUBS, PERENNIALS, GRASSES, PLUGS, AND GROUNDCOVERS.
- 14. PROPOSED PLANT MATERIAL SHALL COMPLY WITH THE LATEST EDITION OF THE AMERICAN STANDARD FOR NURSERY STOCK, ANSI Z60.1 UNLESS NOTED OTHERWISE. DECIDUOUS SHRUBS SHALL HAVE AT LEAST 5 CANES AT THE SPECIFIED HEIGHT. ORNAMENTAL TREES SHALL HAVE NO "V" CROTCHES AND SHALL BEGIN BRANCHING NO LOWER THAN 3 FEET ABOVE ROOT BALL. SHADE TREES SHALL BEGIN BRANCHING NO LOWER THAN 6' ABOVE FINISHED GRADE.
- 15. ALL PLANTS AND TREES SHALL BE PLANTED PER DETAILS AND
- 16. ALL TREES, AS IDENTIFIED ON THE PLANS, SHALL BE STAKED AS SHOWN ON THE PLANTING DETAILS UNLESS NOTED OTHERWISE ON THE PLANS.
- 17. NO PLANTS SHALL BE INSTALLED UNTIL FINAL GRADES AND CONSTRUCTION HAS BEEN COMPLETED IN THE IMMEDIATE AREA.
- 18. WHEN QUANTITIES ARE LISTED THEY ARE FOR THE CONTRACTOR'S CONVENIENCE ONLY. ALL COUNTS MUST BE VERIFIED BY THE CONTRACTOR. IN THE CASE OF A DISCREPANCY BETWEEN THE LEGEND AND THE PLAN, PLANTS INDICATED ON THE PLAN SHALL SUPERCEDE QUANTITIES LISTED IN THE LEGEND. SPECIFICATIONS AND DETAILS TAKE PRECEDENCE OVER NOTES.
- 19. NO PLANT MATERIAL SUBSTITUTIONS WILL BE ACCEPTED UNLESS APPROVAL IS REQUESTED OF THE LANDSCAPE ARCHITECT BY THE LANDSCAPE CONTRACTOR PRIOR TO THE SUBMISSION OF BID AND/OR QUOTATION.
- 20. ADJUSTMENTS IN LOCATION OF PROPOSED PLANT MATERIAL MAY BE NEEDED IN FIELD. PRIME CONSULTANT MUST BE NOTIFIED PRIOR TO THE ADJUSTMENT OF PLANTS.
- 21. CONTRACTOR SHALL VERIFY PLANT QUANTITIES SHOWN ON THE PLAN AND PROVIDE A LIST TO THE CLIENT IDENTIFYING THE SPECIES AND SIZES TO BE USED THROUGHOUT THE PROJECT. THE LANDSCAPE ARCHITECT AND THE OWNER'S REPRESENTATIVE RESERVES THE RIGHT TO REJECT ANY SUBSTANDARD PLANT MATERIAL. REJECTED MATERIAL SHALL BE REMOVED FROM THE PROJECT SITE IMMEDIATELY.



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DIVISION OF FACILITIES AND MAINTENANCE SERVICES

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DERICK J GAENSLEN K-8 SCHOOL

**ISSUED FOR:** 50% CD 1<u>1/14/2</u>02 12/22/2022 95% CD 100% CD 1/23/2023

PROJE **2023** 

ZWA **DRAWN BY: REVIEWED BY:** KW MM **APPROVED BY:** January 2023

**SEAL AND SIGNATURE** KERRY WHITE ULA-822-14

WAUWATOSA CAPE ARCY,

PROJECT NUMBER: 8176 (DIVISION 2)

SITE NUMBER: 185

(now what's **below**. Call before you dig. SHEET: