2023 GREEN INFRASTRUCTURE UPGRADES

MILWAUKEE GERMAN IMMERSION ELEMENTARY SCHOOL

SITE #146

3778 N. 82ND STREET, MILWAUKEE, WI 53222 FINAL PLAN SET

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L501	PLANTING DETAILS



PROJECT NUMBER: 7331 (DIVISION 1)

PROJECT APPROVAL BY:



MILWAUKEE PUBLIC SCHOOLS **DIVISION OF FACILITIES AND MAINTENANCE SERVICES** 1124 NORTH 11TH STREET **MILWAUKEE**, **WI 53205-0259** PHONE: 414-283-4600 FAX: 414-283-4682



PRIME CONSULTANT

Stormwater Solutions Engineering, LLC. 247 W Freshwater Way, Suite 410 Milwaukee WI 53204 Phone: 414-810-1245 Kara Koch, P.E., ENV. SP Senior Project Engineer kara@stormwater-solutions-engineering.com



LANDSCAPE ARCHITECT CONSULTANT

Learning Landscapes Design, LLC 4241 SW Tunnelwood Street Portland, OR 97221

ALTERNATE NOTES:

MANDATORY ALTERNATE BID #1 OVERHEAD STRUCTURE:

INSTALL OVERHEAD STRUCTURE WITH FOOTINGS PRIOR TO THE INSTALLATION OF THE CONCRETE STAGE. INSTALL IN ENTIRETY, METAL POLYGON STRUCTURE WITH THE GUTTER AND DOWNSPOUT. COORDINATE WITH ENGINEER ON LOCATION FOR DOWNSPOUT AND ROOF PITCH.

MANDATORY ALTERNATE BID #2

SWINGS AND POUR IN PLACE RUBBER SURFACE:

REMOVE ASPHALT SURFACE AND SUBBASE TO PREP SUBSURFACE FOR THE INSTALLATION OF SWINGS, SUBSURFACE STORAGE AND DRAINAGE, AND POUR-IN-PLACE RUBBER SURFACE, AS INDICATED ON THE PLANS. INCLUDE TREE PLANTING AND GROUND COVERING AS INDICATED ON THE PLANS.


MANDATORY ALTERNATE BID #3 2-5YR OLD NATURE PLAY AREA

INSTALLATION OF RAISED CONCRETE CURB, ENGINEERED WOOD FIBER SURFACING WITH SUBSURFACE STORAGE, AND NATURE PLAY EQUIPMENT FOR 2-5 YEAR OLDS. IN BASE BID, INCLUDE THE INSTALLATION OF PERFORATED UNDERDRAIN WITH A 9-IN NDS DRAIN INLET AS SPECIFIED..

CONSTRUCTION BARRICADE NOTES:

FOR CONSTRUCTION BARRICADING WHERE A SEPARATION IS NEEDED BETWEEN AN AREA TO BE RECONSTRUCTED AND AN AREA TO REMAIN, BUT THERE IS NO EXISTING FENCING, A TEMPORARY 6 FOOT HIGH CHAIN LINK FENCE, SELF SUPPORTED, FREE STANDING SHALL BE USED AND MAINTAINED UNTIL THE PROJECT IS COMPLETE.

CONSTRUCTION BARRICADING SHALL BE MAINTAINED ON A DAILY BASIS TO ASSURE THAT AT THE END OF EACH WORK DAY THE SITE IS SECURED.

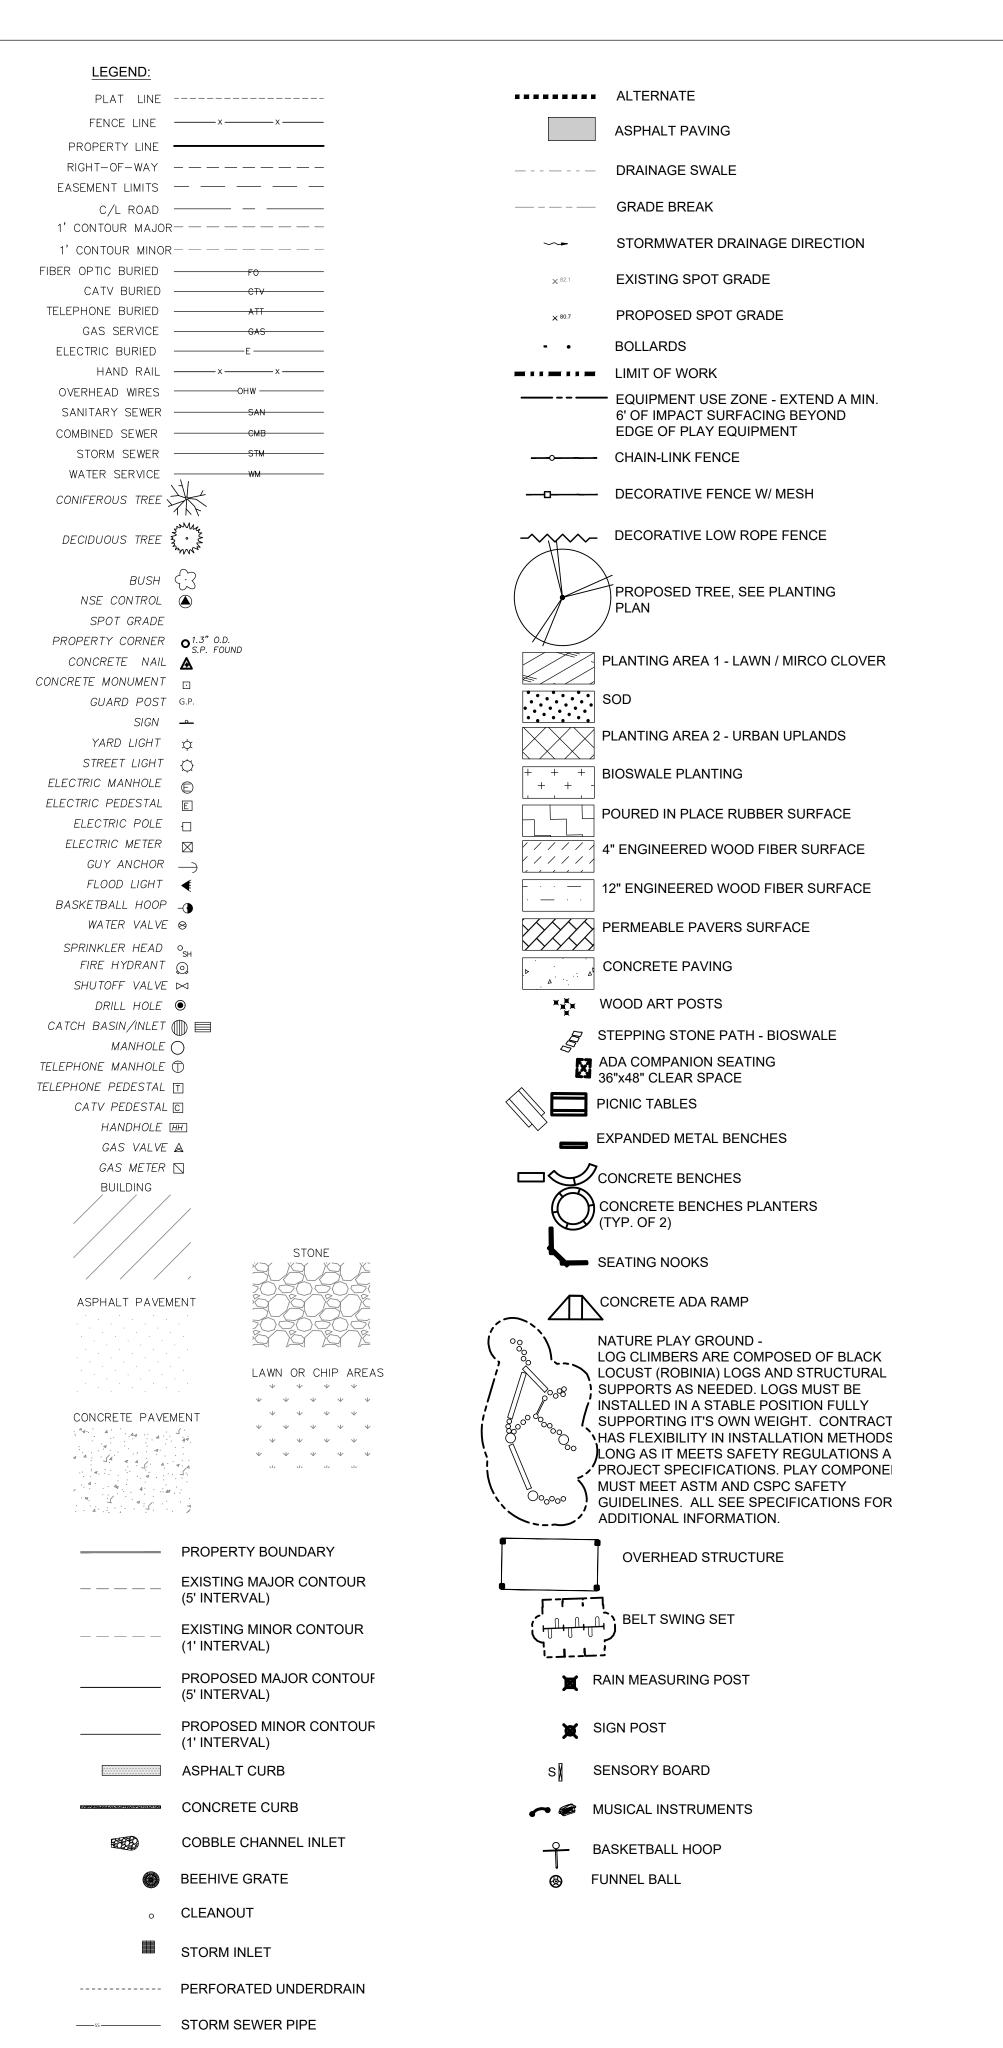

SURVEY NOTES:

- 1) SURVEY PREPARED BY NORTH SHORE ENGINEERING, INC. REFER TO PLAT OF SURVEY FOR ALL EXISTING CONDITION DETAILS.
- 2) UTILITIES MARKED BY DIGGERS HOTLINE AND ALL LINES UTILITY SERVICE.

GENERAL NOTES:

- 1. THE CONTRACTOR TO COMPLY WITH ALL APPLICABLE CODES AND REGULATIONS OF AUTHORITIES HAVING
- JURISDICTION OVER THE WORK. 2. CONTRACTOR TO VERIFY DIMENSIONS INDICATED ON DRAWINGS WITH FIELD MEASUREMENTS BEFORE FABRICATION OR ORDERING OF MATERIALS PRIOR TO COMMENCEMENT OF ANY DEMOLITION OR
- CONSTRUCTION. DO NOT SCALE DRAWINGS. 3. CONTRACTOR TO NOTIFY ENGINEER OF EXISTING CONDITIONS DIFFERING FROM THOSE INDICATED ON THE
- DRAWINGS. 4. CONTRACTOR TO CONTACT PUBLIC AND PRIVATE UNDERGROUND UTILITY LOCATING SERVICES TO HAVE THE SITE MARKED PRIOR TO ANY DIGGING OR EARTHWORK.
- 5. CONTRACTOR TO REPLACE ANY INSTALLED MATERIAL NOT MEETING THE SPECIFICATION OR PLAN REQUIREMENTS WITH MATERIAL THAT MEETS THESE REQUIREMENTS WITHOUT ADDITIONAL COST TO THE
- 6. CONTRACTOR TO REPLACE PAVEMENT, CURB AND GUTTER. TREES. LAWN AREA. ANY ABOVE GROUND APPARATUSES. OR ANY OTHER ITEM THAT WAS DAMAGED AS A RESULT OF CONSTRUCTION RELATED ACTIVITIES AS DEEMED BY OWNERS REPRESENTATIVE THAT WAS NOT CALLED OUT FOR REMOVAL OR REPLACEMENT. CONTRACTOR TO REPLACE/REPAIR DAMAGED ITEM TO THE SATISFACTION OF THE OWNER'S REPRESENTATIVE AT NO ADDITIONAL COST TO THE OWNER.
- 7. FOR CONSTRUCTION BARRICADING WHERE A SEPARATION IS NEEDED BETWEEN AN AREA TO BE RECONSTRUCTED AND AN AREA TO REMAIN, BUT THERE IS NO EXISTING FENCING, A TEMPORARY 6 FOOT HIGH CHAIN LINK FENCE, SELF SUPPORTED, FREE STANDING SHALL BE USED AND MAINTAINED UNTIL THE PROJECT IS COMPLETE.
- 9. CONSTRUCTION BARRICADING SHALL BE MAINTAINED ON A DAILY BASIS TO ASSURE THAT AT THE END OF EACH WORK DAY THE SITE IS SECURED.
- 10. CONTRACTOR IS TO SECURE CONSTRUCTION AREA FOR SAFETY. INCLUDING BUT NOT LIMITED TO: TRAFFIC CONTROL SIGNAGE, BARRICADE ENTRANCE, AND PLACE CONSTRUCTION FENCE AROUND OPEN TRENCHES AND SAWCUT AREAS.

ABBREVIATIONS

F	<u>REVIATIONS</u>	
	@	AT
	%	PERCENT SLOPE, '/', FT/FT
	ABDN	ABANDONED
	AGGR	AGGREGATE
	ALT	ALTERNATE
	APPROX	APPROXIMATE
	APVD	APPROVED
	ASTM	THE AMERICAN SOCIETY OF
		TESTING AND MATERIALS
	AVE	AVENUE
	BLDG	BUILDING
	BM	BENCHMAR
	СВ	CATCH BASIN
	CJ	CONSTRUCTION JOINT
	C/L	CENTERLINE
	DIA	DIAMETER
	DSGN	DESIGNER
	DWG	DRAWING
	E	EASTING, EAST
	EA	EACH
	EG	EXISTING GRADE
	EL	ELEVATION
	ELEV	ELEVATION
	EQL	EQUAL
	EJ	EXPANSION JOINT
	EX	EXISTING
	FT	FOOT, FEET
	GND	GROUND
	GR	GRADE
	HORIZ	HORIZONTAL
	HP	HIGH POINT
	HYD	HYDRANT
	INV	INVERT
	LF	LINEAL FEET
	LT	LEFT
	MAX	MAXIMUM
	MH	MANHOLE
	MIN	
		MINIMUM
	MISC	MISCELLANEOUS
	MMSD	MILWAUKEE METROPOLITAN SEWERAGE DISTRICT
	N	NORTH, NORTHING
	NE	NORTHEAST
	NO	NUMBER
	#	NUMBER
	NTS	NOT TO SCALE
	NW	NORTHWEST
	PROP	PROPOSED
	PVMT	PAVEMENT
	REQ'D	REQUIRED
	RT	RIGHT
	RMV	REMOVE
	ROW	RIGHT OF WAY
	R/W	RIGHT OF WAY
	S	SOUTH, SLOPE
	SE	SOUTHEAST
	SPEC	SPECIFICATIONS
	SQ	SQUARE
	ST	STREET
	STA	STATION
	STD	STANDARD
	SW	SOUTHWEST
	T&B	TOP AND BOTTOM
	TOC	TOP OF CURB
	TOS	TOP OF SLOPE
		TOPOGRAPHIC
	TOPO	
	TYP	TYPICAL

WITH

WATER SURFACE

QUANTITY NOTES:

- 1) THE BELOW QUANTITIES ARE APPROXIMATIONS AND ARE NOT INTENDED TO BE USED DURING CONSTRUCTION ACTIVITIES. CONTRACTORS ARE RESPONSIBLE FOR QUANTIFYING ITEMS PRIOR TO COMMENCING WORK.
- 2) DISCREPANCIES TO BE COMMUNICATED WITH MPS AND THE PROJECT ENGINEER.
- 3) VOLUMES PROVIDED ARE MEASURED AS IN-PLACE CUBIC YARDS.

Adjust rim elevation of existing catch basin

Permeable paver, setting bed, and joint stone

Permeable paver No. 1 clear stone

Bioswale engineered media

Bioswale No. 1 clear stone

Bioswale pea gravel

Bioswale jute mat

Cobble drain inlet

Cobble channel inlet

6" Animal guard

PERMEABLE PAVERS

HARDSCAPE

Asphalt curb

Concrete Stage

Asphalt paving / patch

Raised concrete curb

ADA concrete ramp

Stone stepping stones

EWF No. 1 clear stone

Cobble Paved Surface

for parking lot

FURNITURE & EQUIPMENT

Musical instruments

Concrete benches

Rain Measuring Post

Relocated Benches

Bollard - Collapsible

Metal edging, steel

Bioswale seed

Sensory Panel

Maypole Post

Seating Nook

Sign Post

Art Posts

LANDSCAPE

FENCING

Concrete circular tree planter

Concrete semi-circle seating area

Bollard - Recycled from Fece Posts

Topsoil, imported and placed

Perennials and grasses - plugs Grasses in Raised Planter - cont.

Mulch - shredded hardwood / 3" cover

Extend 6' fence to 12' chain link fence

Urban Erosion Control Mat for Urban Planting areas

MicroClover/ Lawn Seed Shade trees, 3" cal.

Tree protection staking

Cedar mesh fence

4' Chainlink Fence

6' Chainlink Fence

Rope Fence

Basketball Hoops

Picnic Tables

Metal Bench

Painted Play

12" engineered wood fiber (EWF)

Crack fill & clean asphalt surface

4" engineered wood fiber (EWF) and subbase

6" Concrete apron, curb, sidewalk, and driveway

Nature Play (log steppers and balancing logs)

Prep, crackfill, and Bituminous Surface Treatment

5" concrete slab / walkway

BIOSWALE

	lte m	Quantity	Unit	AL	TERNATE BID
A	SE BID			1	OVERHEAD STRUCTURE
E	NERAL & SITE PREP				Overhead Structure
	Mobilization	1	LS		
	Provide, install, maintain, and remove silt sock	825	LF	2	SWINGS WITH PIP SURFACI
	Provide, install, and maintain inlet protection	6	EA		Sawcutting
	Chain Link Fence Removal	241	LF		Asphalt and/or stone base r
	Existing play equipment and foundation removal	6	EA		Rough & fine grading
	Sawcutting	1,660	LF		Asphalt patch
	Asphalt removal	82,500	SF		6" perforated PVC underdra
	Stone base course removal	525	CY		6" solid PVC storm sewer pi
	Rough & fine grading	83,020	SF		6" Clean out with cast iron li
	Clean out existing catch basin	3	EA		6" Animal guard
	Bench removal, onsite storage	2	EA		Topsoil, imported and place
	Clearing and grubbing - topsoil removal	680	SF		MicroClover/ Lawn Seed
	Underdrain storm sewer pipe removal	91	LF		Shade trees, 3" cal.
	Timber wood edge removal	45	LF		Tree protection staking
	Curb removal	27	LF		PIP Surfacing
	Concrete sidewalk removal	102	SF		Arched Swing
				3	2-5YR OLD NATURE PLAY AR
T	ILITIES				Raised concrete curb
	6" perforated PVC underdrain and fittings	565.6	LF		12" engineered wood fiber
	6" solid PVC storm sewer pipe and fittings	218	LF		EWF No. 1 clear stone
	8" solid PVC storm sewer pipe and fittings	177	LF		Nature Play (log steppers ar
	6" Clean out with cast iron lid and fitting	9	EA		Raised concrete curb
	18 in diameter standpipe (Nyloplast)	1	EA		ADA concrete ramp
	Metal lockable beehive grate (Nyloplast)	1	EA		
	Neenah R-2561-A Beehive Grate and Casting	2	EA		
	NDS 9" catch basin kit with galvanized grate	1	EA		
	Core into existing trapped manhole	2	EA		
	5				

2 EA

592 CY

440 TONS

110 TONS

5 EA

5 EA

6 EA

7361 SF

330 LF

7248 SF 597 SF

904 SF

252 LF

1 EA

84 LF

1371 SF

477 SF

38825 SF

145 SF 1 LS

720 SF 16550 SF

1 EA

1 LS

1 LS

12 EA

3 EA

2 EA

2 LS

33 EA

2 EA 1 EA

1 EA

12 EA

1 EA

2 EA

3 EA

2 EA

1 EA

777 LF 1,021 CY

2,743 SY 6,570 SF

12,319 SF

53 EA

14 EA

36 EA

140 SF

181 SY

81 LF

0 LF 410 LF

57 LF

102 LF

9,081 EA

354 TONS

1920 SY

1	OVERHEAD STRUCTURE		
	Overhead Structure	1	EA
2	SWINGS WITH PIP SURFACING		
	Sawcutting	108	LF
	Asphalt and/or stone base removal	81	CY
	Rough & fine grading	2,377	SF
	Asphalt patch	118	SF
	6" perforated PVC underdrain and fittings	50	LF
	6" solid PVC storm sewer pipe and fittings	64	LF
	6" Clean out with cast iron lid and fitting	1	EA
	6" Animal guard	1	EA
	Topsoil, imported and placed	12	CY
	MicroClover/ Lawn Seed	537	SF
	Shade trees, 3" cal.	2	EA
	Tree protection staking	2	EA
	PIP Surfacing	1772	SF
	Arched Swing	1	EA
3	2-5YR OLD NATURE PLAY AREA		
	Raised concrete curb	140	LF
	12" engineered wood fiber (EWF)	1122	SF
	EWF No. 1 clear stone	54	TON
	Nature Play (log steppers and balancing logs)	1	LS
	Raised concrete curb	252	LF
	ADA concrete ramp	1	EA



247 W. FRESHWATER WAY, SUITE 410 MILWAUKEE, WI 53204 PHONE: (414) 810-1245 WWW.STORMWATER-SOLUTIONS-**ENGINEERING.COM**



LEARNING LANDSCAPES DESIGN, LLC **4241 SW TUNNELWOOD STREET** PORTLAND, OR 97221



DIVISION OF FACILITIES AND MAINTENANCE SERVICES

1124 NORTH 11TH STREET **MILWAUKEE, WI 53205-0259** PHONE: 414-283-4600 FAX: 414-283-4682

SHEET NAME: LEGEND AND NOTES	PROJECT NAME: 2023 GREEN INFRASTRUCTURE UPGRADES	PROJECT ADDRESS: MILWAUKEE GERMAN IMMERSION ELEMENTARY SCHO 3778 N. 82ND STREET, MILWAUKEE, WI 53222
ISSUED FOR	REV:	DATE:
50% CD 90% CD		1 <u>1/14/2</u> 022 12/22/2022
100% CD		<u>1/23/2</u> 023

KLK

CNH

CBG

January 2023

PROJECT NUMBER: 7331 (DIVISION 1)

DRAWN BY:

DATE:

REVIEWED BY:

APPROVED BY:


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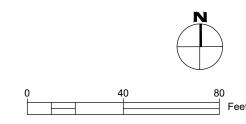
Know what's **below**.

Call before you dig.

SITE NUMBER: 146 SHEET:

G001



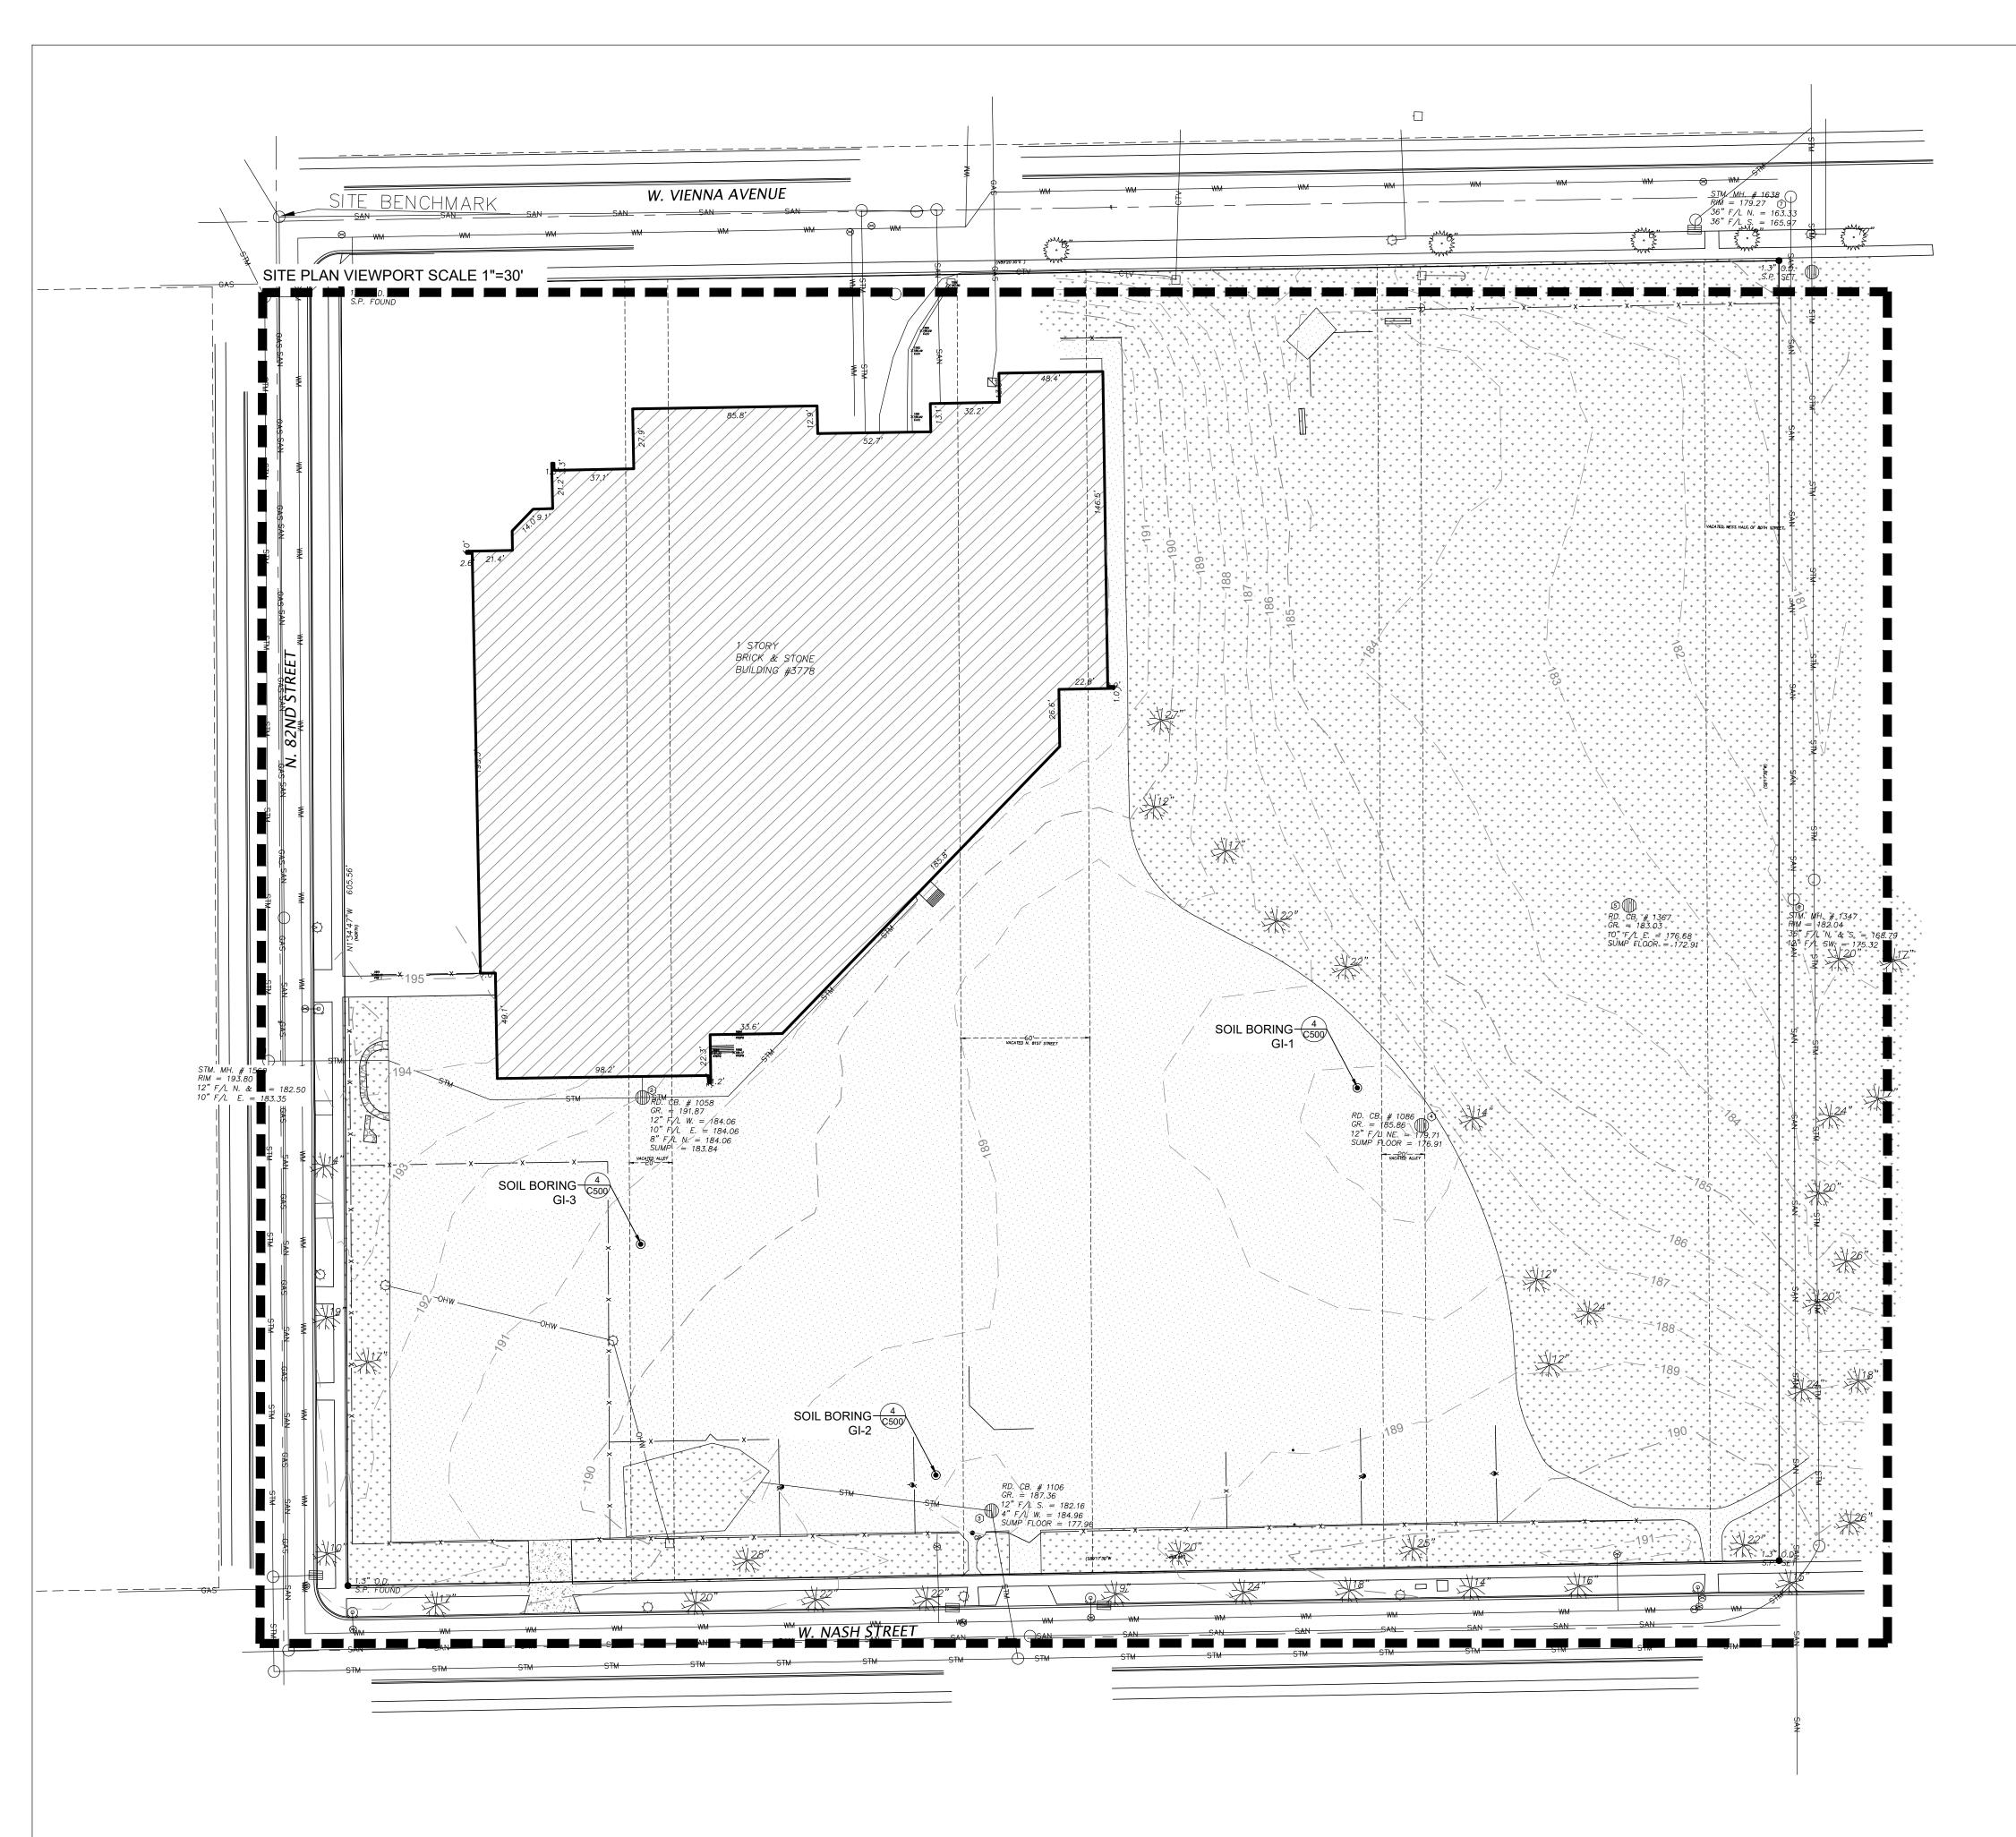

ASPHALT PAVEMENT

STONE

LAWN OR CHIP AREAS

y y y y

· • • • •

 \vee \vee \vee \vee · • • • •

LEGEND:

CONIFEROUS TREE

DECIDUOUS TREE 💈 ° ,

NSE CONTROL 🛆 SPOT GRADE

CONCRETE NAIL A CONCRETE MONUMENT

ELECTRIC MANHOLE ELECTRIC PEDESTAL E ELECTRIC POLE -

> ELECTRIC METER 🖂 GUY ANCHOR \longrightarrow

BASKETBALL HOOP _

FLOOD LIGHT 🍕

WATER VALVE ⊗ SPRINKLER HEAD ON FIRE HYDRANT 🔘 SHUTOFF VALVE ⋈ DRILL HOLE 🔘 CATCH BASIN/INLET 🌑 🗏

MANHOLE (

HANDHOLE HH

GAS VALVE 🛆

GAS METER 🖂

PROPERTY LINE -

PLAT LINE -----

RIGHT-OF-WAY -----EASEMENT LIMITS — — — — —

1' CONTOUR MAJOR———————— 1' CONTOUR MINOR-----

FIBER OPTIC BURIED FO

ELECTRIC BURIED —————E—————

SANITARY SEWER — SAN COMBINED SEWER — CMB STORM SEWER - STM WATER SERVICE ------

1. SURVEY PREPARED BY NORTH SHORE

LOCATED BY ALL LINES.

DATED OCTOBER 7, 2022.

MILWAUKEE DATUM)

MILWUKEE DATUM)

BENCHMARK NOTES:

FULL EXISTING CONDITION DETAILS. 2. UTILITIES MARKED BY DIGGERS HOTLINE AND

3. 4-INCH DIAMETER PAVEMENT CORES WERE

IDENTIFIED ON THE PLANS BY GESTRA ENGINEERING, INC. FOLLOWING, A 4-FOOT

COLLECTED AT THE 'SOIL BORING' LOCATIONS

SUBGRADE SAMPLE WAS COLLECTED BELOW THE CORE SAMPLES. RESULTS ARE PRESENTED IN THE

'DRILLING AND LABORATORY TESTING SUMMARY',

BEHIND CURB LINE SE. CORNER OF INTERSECTION, TOP OF NOZZLE ELEVATION = 192.02 (CITY OF

> Know what's **below.** Call before you dig.

1. MAIN BENCHMARK: REFERENCE BENCHMARK FOR SECTION CORNER LOCATION: N. 84TH STREET & W. CAPITOL DRIVE DESCRIPTION: FIRE HYDRANT

2. SITE BENCHMARK: SANITARY MANHOLE LOCATION: INTERSECTION OF N. 82ND STREET AND W. VIENNA AVENUE, AS SHOWN ON SURVEY DESCRIPTION: MANHOLE RIM ELEVATION = 189.93 (CITY OF

CATV BURIED — CTV

ENGINEERING, INC. REFER TO PLAT OF SURVEY FOR

C/L ROAD -----

TELEPHONE MANHOLE 🗇

TELEPHONE PEDESTAL T CATV PEDESTAL C

GENERAL NOTES:

PROPERTY CORNER 1.3" O.D. S.P. FOUND

GUARD POST

YARD LIGHT 🌣 STREET LIGHT 💍

SIGN -

 $BUSH \{ \}$

STORMWATER SOLUTIONS ENGINEERING 247 W. FRESHWATER WAY, SUITE 410 MILWAUKEE, WI 53204 PHONE: (414) 810-1245

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ENGINEERING.COM

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DIVISION OF FACILITIES AND MAINTENANCE SERVICES

1124 NORTH 11TH STREET

SHEET NAME: EXISTING CONDITIONS	PROJECT NAME:	2023 GREEN INFRASTRUCTURE UPGRADES	PROJECT ADDRESS: MILWAUKEE GERMAN IMMERSION ELEMENTARY SCHOOL 3778 N. 82ND STREET, MILWAUKEE, WI 53222
ISSUED FOR	R: RI	EV:	DATE: 1 <u>1/14/2</u> 022
90% CD	_		1 <u>2/22/2</u> 022
100% CD			<u>1/23/2</u> 023
	<u> </u>		
	_		
	DRAWN BY:		KLK
DRAWN BY	:		
DRAWN BY: REVIEWED APPROVED	BY:		CNH


PROJECT NUMBER: 7331 (DIVISION 1)

SITE NUMBER: 146

C001

SHEET:

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DIVISION OF FACILITIES AND MAINTENANCE SERVICES

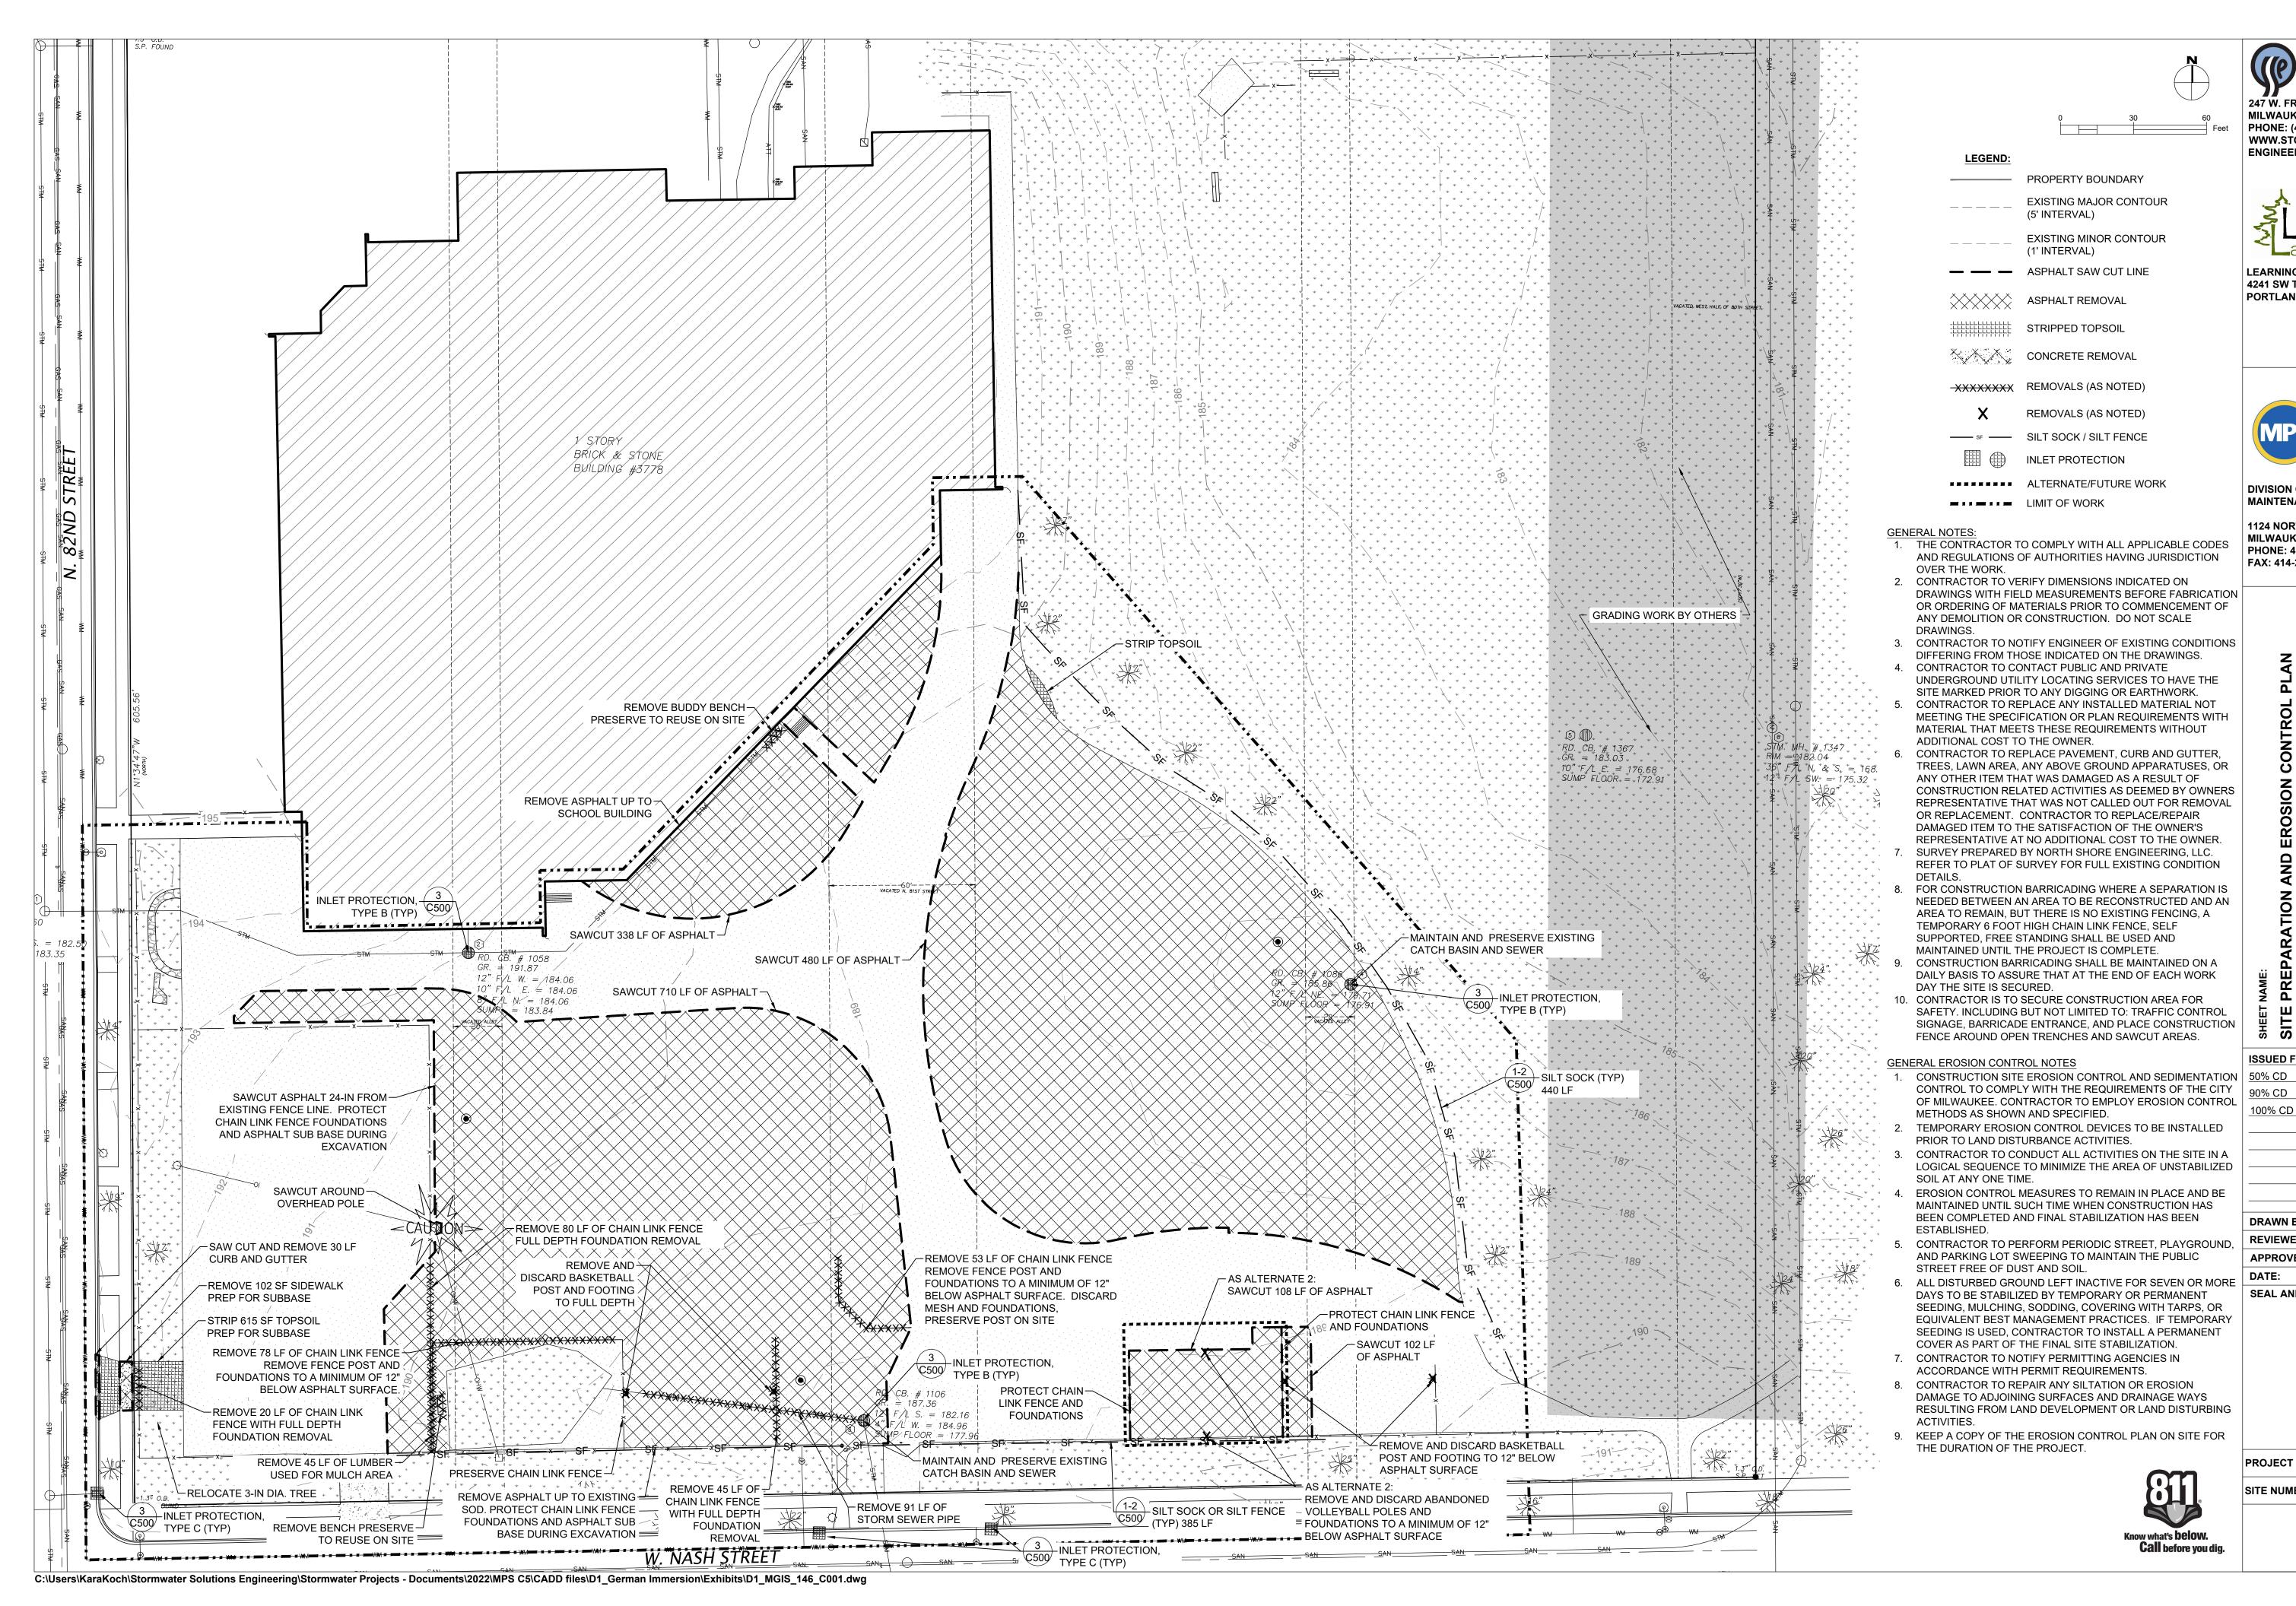1124 NORTH 11TH STREET

MILWAUKEE, WI 53205-0259 PHONE: 414-283-4600 FAX: 414-283-4682

SITE ISSUED FOR: 1<u>1/14/2</u>022 <u>1/23/2</u>023

DRAWN BY: KLK **REVIEWED BY:** CNH **APPROVED BY:** CBG DATE: January 2023 **SEAL AND SIGNATURE**

PROJECT NUMBER: 7331 (DIVISION 1)

SITE NUMBER: 146

SHEET:





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1. CONTRACTOR TO REMOVE AND HAUL OFF ASPHALT FROM PROPOSED DEPAVING AREAS. ASPHALT ASSUMED TO BE 4 TO 4.9 INCHES ACROSS SITE FROM THE GEOTECHNICAL REPORT.

— PROPERTY BOUNDARY

(5' INTERVAL)

(1' INTERVAL)

EXISTING MAJOR CONTOUR

EXISTING MINOR CONTOUR

ASPHALT REMOVAL ONLY

MIN 2-IN BASE COURSE REMOVED

FULL DEPTH BASE COURSE REMOVED

- 2. AREAS WHERE GREEN INFRASTRUCTURE OR UPLAND PLANTINGS ARE PROPOSED, BASE COURSE TO BE REMOVED AND HAULED OFF SITE AT FULL DEPTH. THICKNESS OF BASE COURSE IS ASSUMED TO BE 6 INCHES FROM GEOTECHNICAL REPORT.
- 3. AREAS OF SOD OR MICRO CLOVER ARE TO HAVE A MINIMUM OF 4 INCHES OF TOPSOIL, 6 INCHES PREFERRED. BASE COURSE BELOW THE 4-6 INCHES CAN REMAIN IN PLACE.



DIVISION OF FACILITIES AND

MAINTENANCE SERVICES

1124 NORTH 11TH STREET MILWAUKEE, WI 53205-0259 PHONE: 414-283-4600 FAX: 414-283-4682

SHEET NAME: ASPHALT BASE COURSE REMOVAL PLAN	PROJECT NAME: 2023 GREEN INFRASTRUCTURE UPGRADES	PROJECT ADDRESS: MILWAUKEE GERMAN IMMERSION ELEMENTARY S 3778 N. 82ND STREET, MILWAUKEE, WI 53222
ISSUED FOR: 50% CD	REV:	<u>DATE:</u> 1 <u>1/14/2</u> 022

DRAWN BY: KLK **REVIEWED BY:** CNH **APPROVED BY:** CBG DATE: January 2023


<u>1/23/2</u>023


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PROJECT NUMBER: 7331 (DIVISION 1) SITE NUMBER: 146

SHEET: C003

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DIVISION OF FACILITIES AND MAINTENANCE SERVICES

1124 NORTH 11TH STREET **MILWAUKEE, WI 53205-0259** PHONE: 414-283-4600 FAX: 414-283-4682

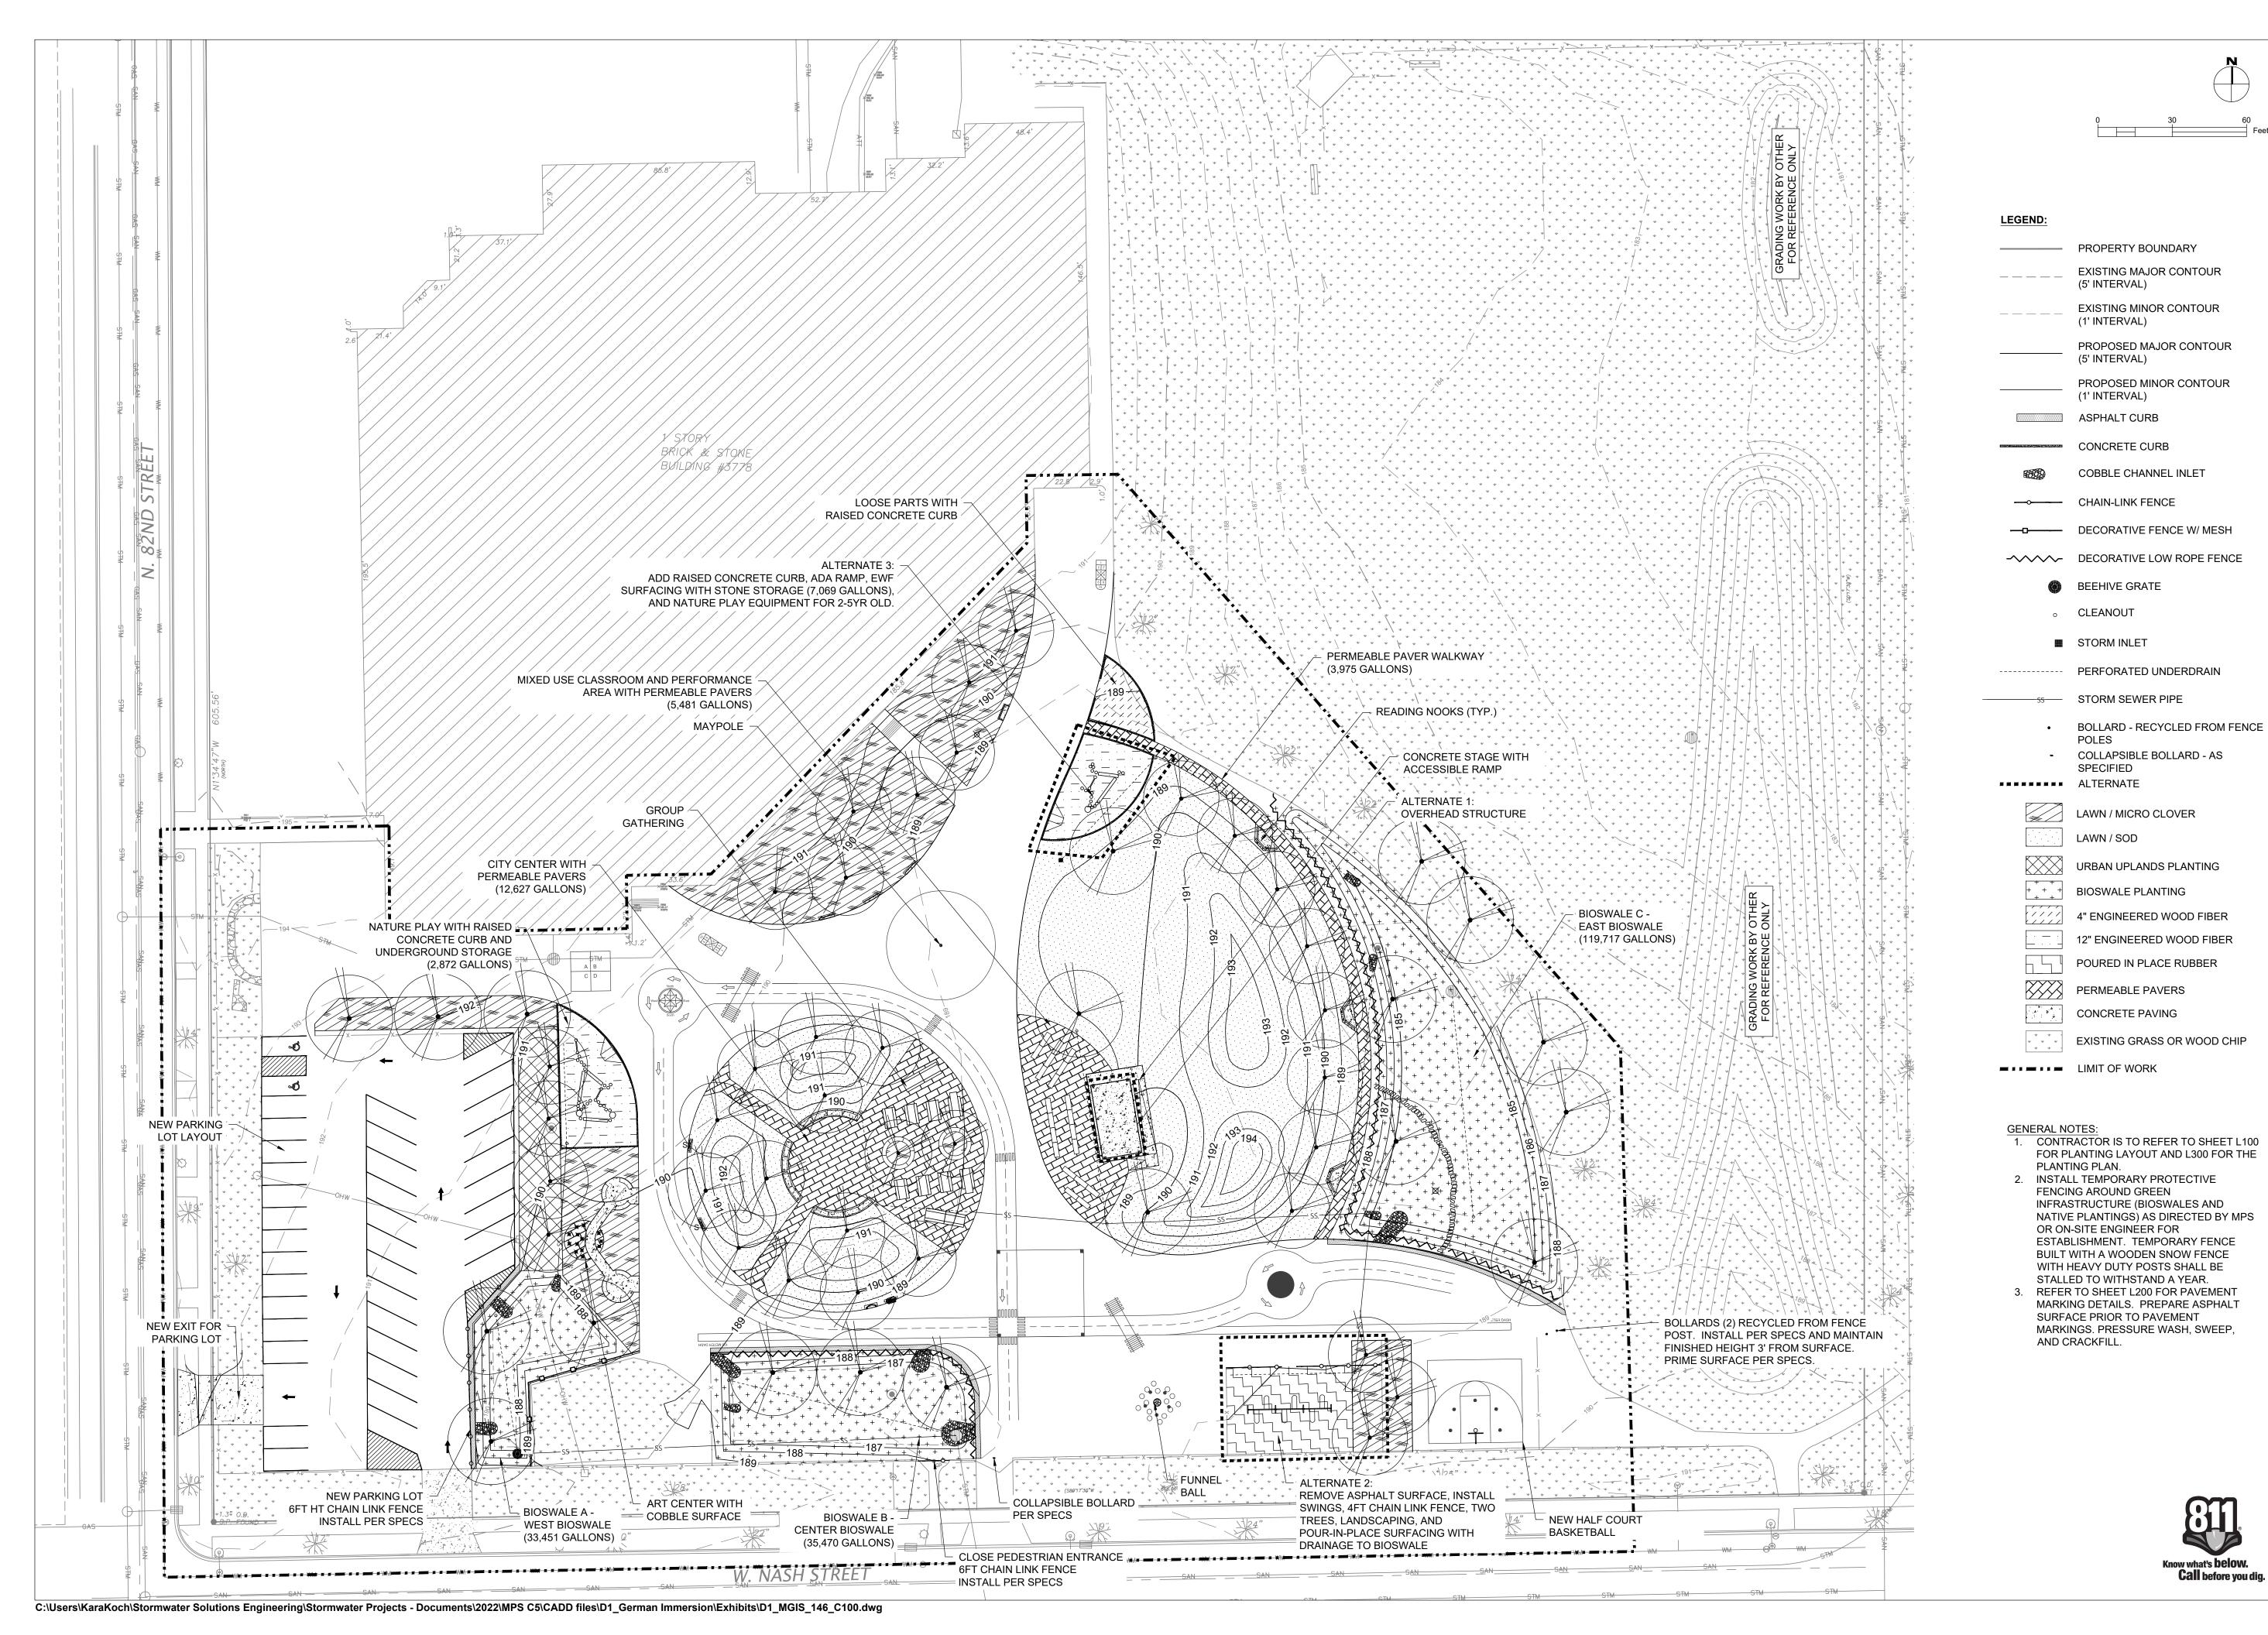CT NAME: GREEN

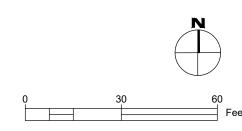SITE	PROJEC 2023	PROJEC MILW 3778
IED FOR:	REV:	DATE:
CD		1 <u>1/14/2</u> 022
CD		1 <u>2/22/2</u> 022
% CD		1/23/2023


DRAWN BY: KLK **REVIEWED BY:** CNH CBG **APPROVED BY:** DATE: January 2023


SEAL AND SIGNATURE

PROJECT NUMBER: 7331 (DIVISION 1) SITE NUMBER: 146

811		
now what's below .		
Call before you dig.		

SHEET:

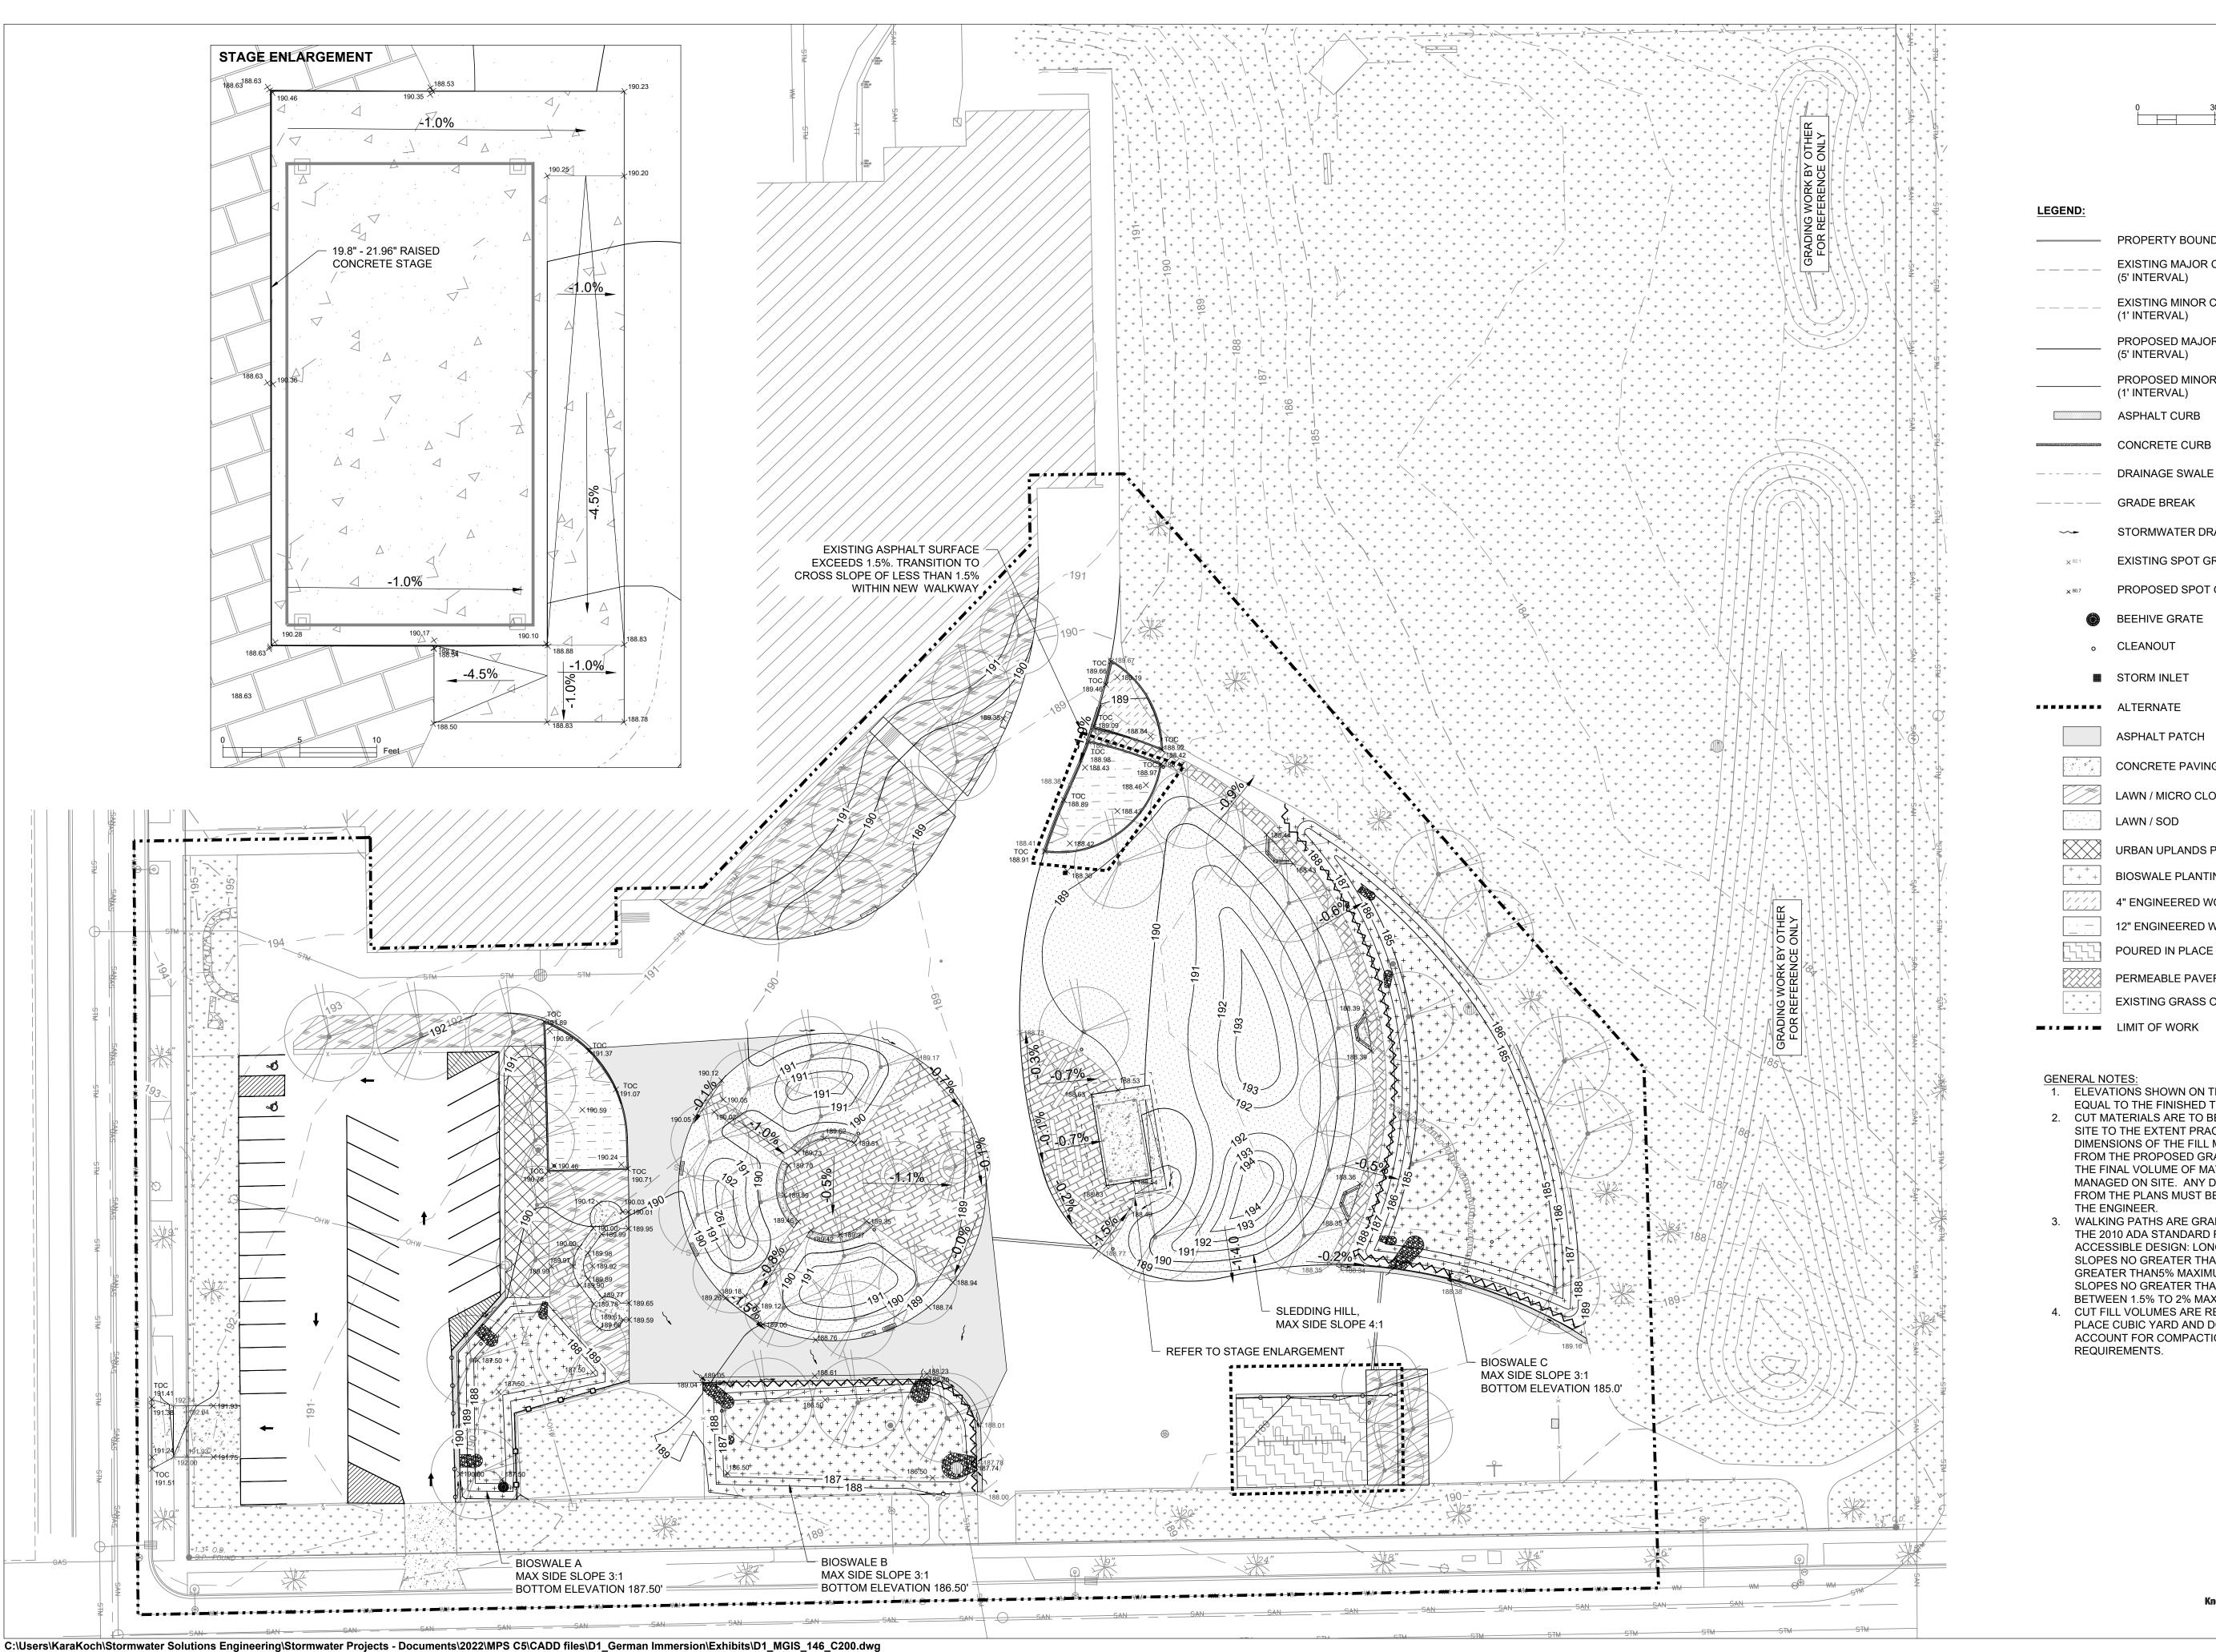

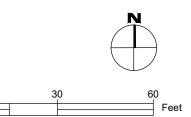

PROPERTY BOUNDARY

(5' INTERVAL)

(1' INTERVAL)

(5' INTERVAL)

(1' INTERVAL)

DRAINAGE SWALE

ASPHALT PATCH

LAWN / SOD

CONCRETE PAVING

LAWN / MICRO CLOVER

BIOSWALE PLANTING

PERMEABLE PAVERS

URBAN UPLANDS PLANTING

4" ENGINEERED WOOD FIBER

12" ENGINEERED WOOD FIBER

EXISTING GRASS OR WOOD CHIP

POURED IN PLACE RUBBER

EXISTING MAJOR CONTOUR

EXISTING MINOR CONTOUR

PROPOSED MAJOR CONTOUR

PROPOSED MINOR CONTOUR

STORMWATER SOLUTIONS ENGINEERING 247 W. FRESHWATER WAY, SUITE 410 MILWAUKEE, WI 53204

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DIVISION OF FACILITIES AND MAINTENANCE SERVICES

STORMWATER DRAINAGE DIRECTION 1124 NORTH 11TH STREET MILWAUKEE, WI 53205-0259

EXISTING SPOT GRADE PHONE: 414-283-4600 FAX: 414-283-4682 PROPOSED SPOT GRADE

1<u>1/14/2</u>022

GENERAL NOTES:

- 1. ELEVATIONS SHOWN ON THE PLAN ARE
- EQUAL TO THE FINISHED TOP OF GRADE. 2. CUT MATERIALS ARE TO BE MANAGED ON SITE TO THE EXTENT PRACTICABLE. THE DIMENSIONS OF THE FILL MAY ALTER FROM THE PROPOSED GRADES DUE TO THE FINAL VOLUME OF MATERIALS TO BE MANAGED ON SITE. ANY DEVIATIONS FROM THE PLANS MUST BE APPROVED BY THE ENGINEER.
- 3. WALKING PATHS ARE GRADED TO MEET THE 2010 ADA STANDARD FOR ACCESSIBLE DESIGN: LONGITUDINAL SLOPES NO GREATER THAN 1:20 FEET, NO GREATER THAN5% MAXIMUM, AND CROSS SLOPES NO GREATER THAN 1:50 FEET OR BETWEEN 1.5% TO 2% MAXIMUM.
- 4. CUT FILL VOLUMES ARE REPRESENTED IN PLACE CUBIC YARD AND DOES NOT ACCOUNT FOR COMPACTION REQUIREMENTS.



50% CD


PROJECT NUMBER: 7331 (DIVISION 1)

SITE NUMBER: 146

SHEET:

C200

Know what's **below.** Call before you dig.

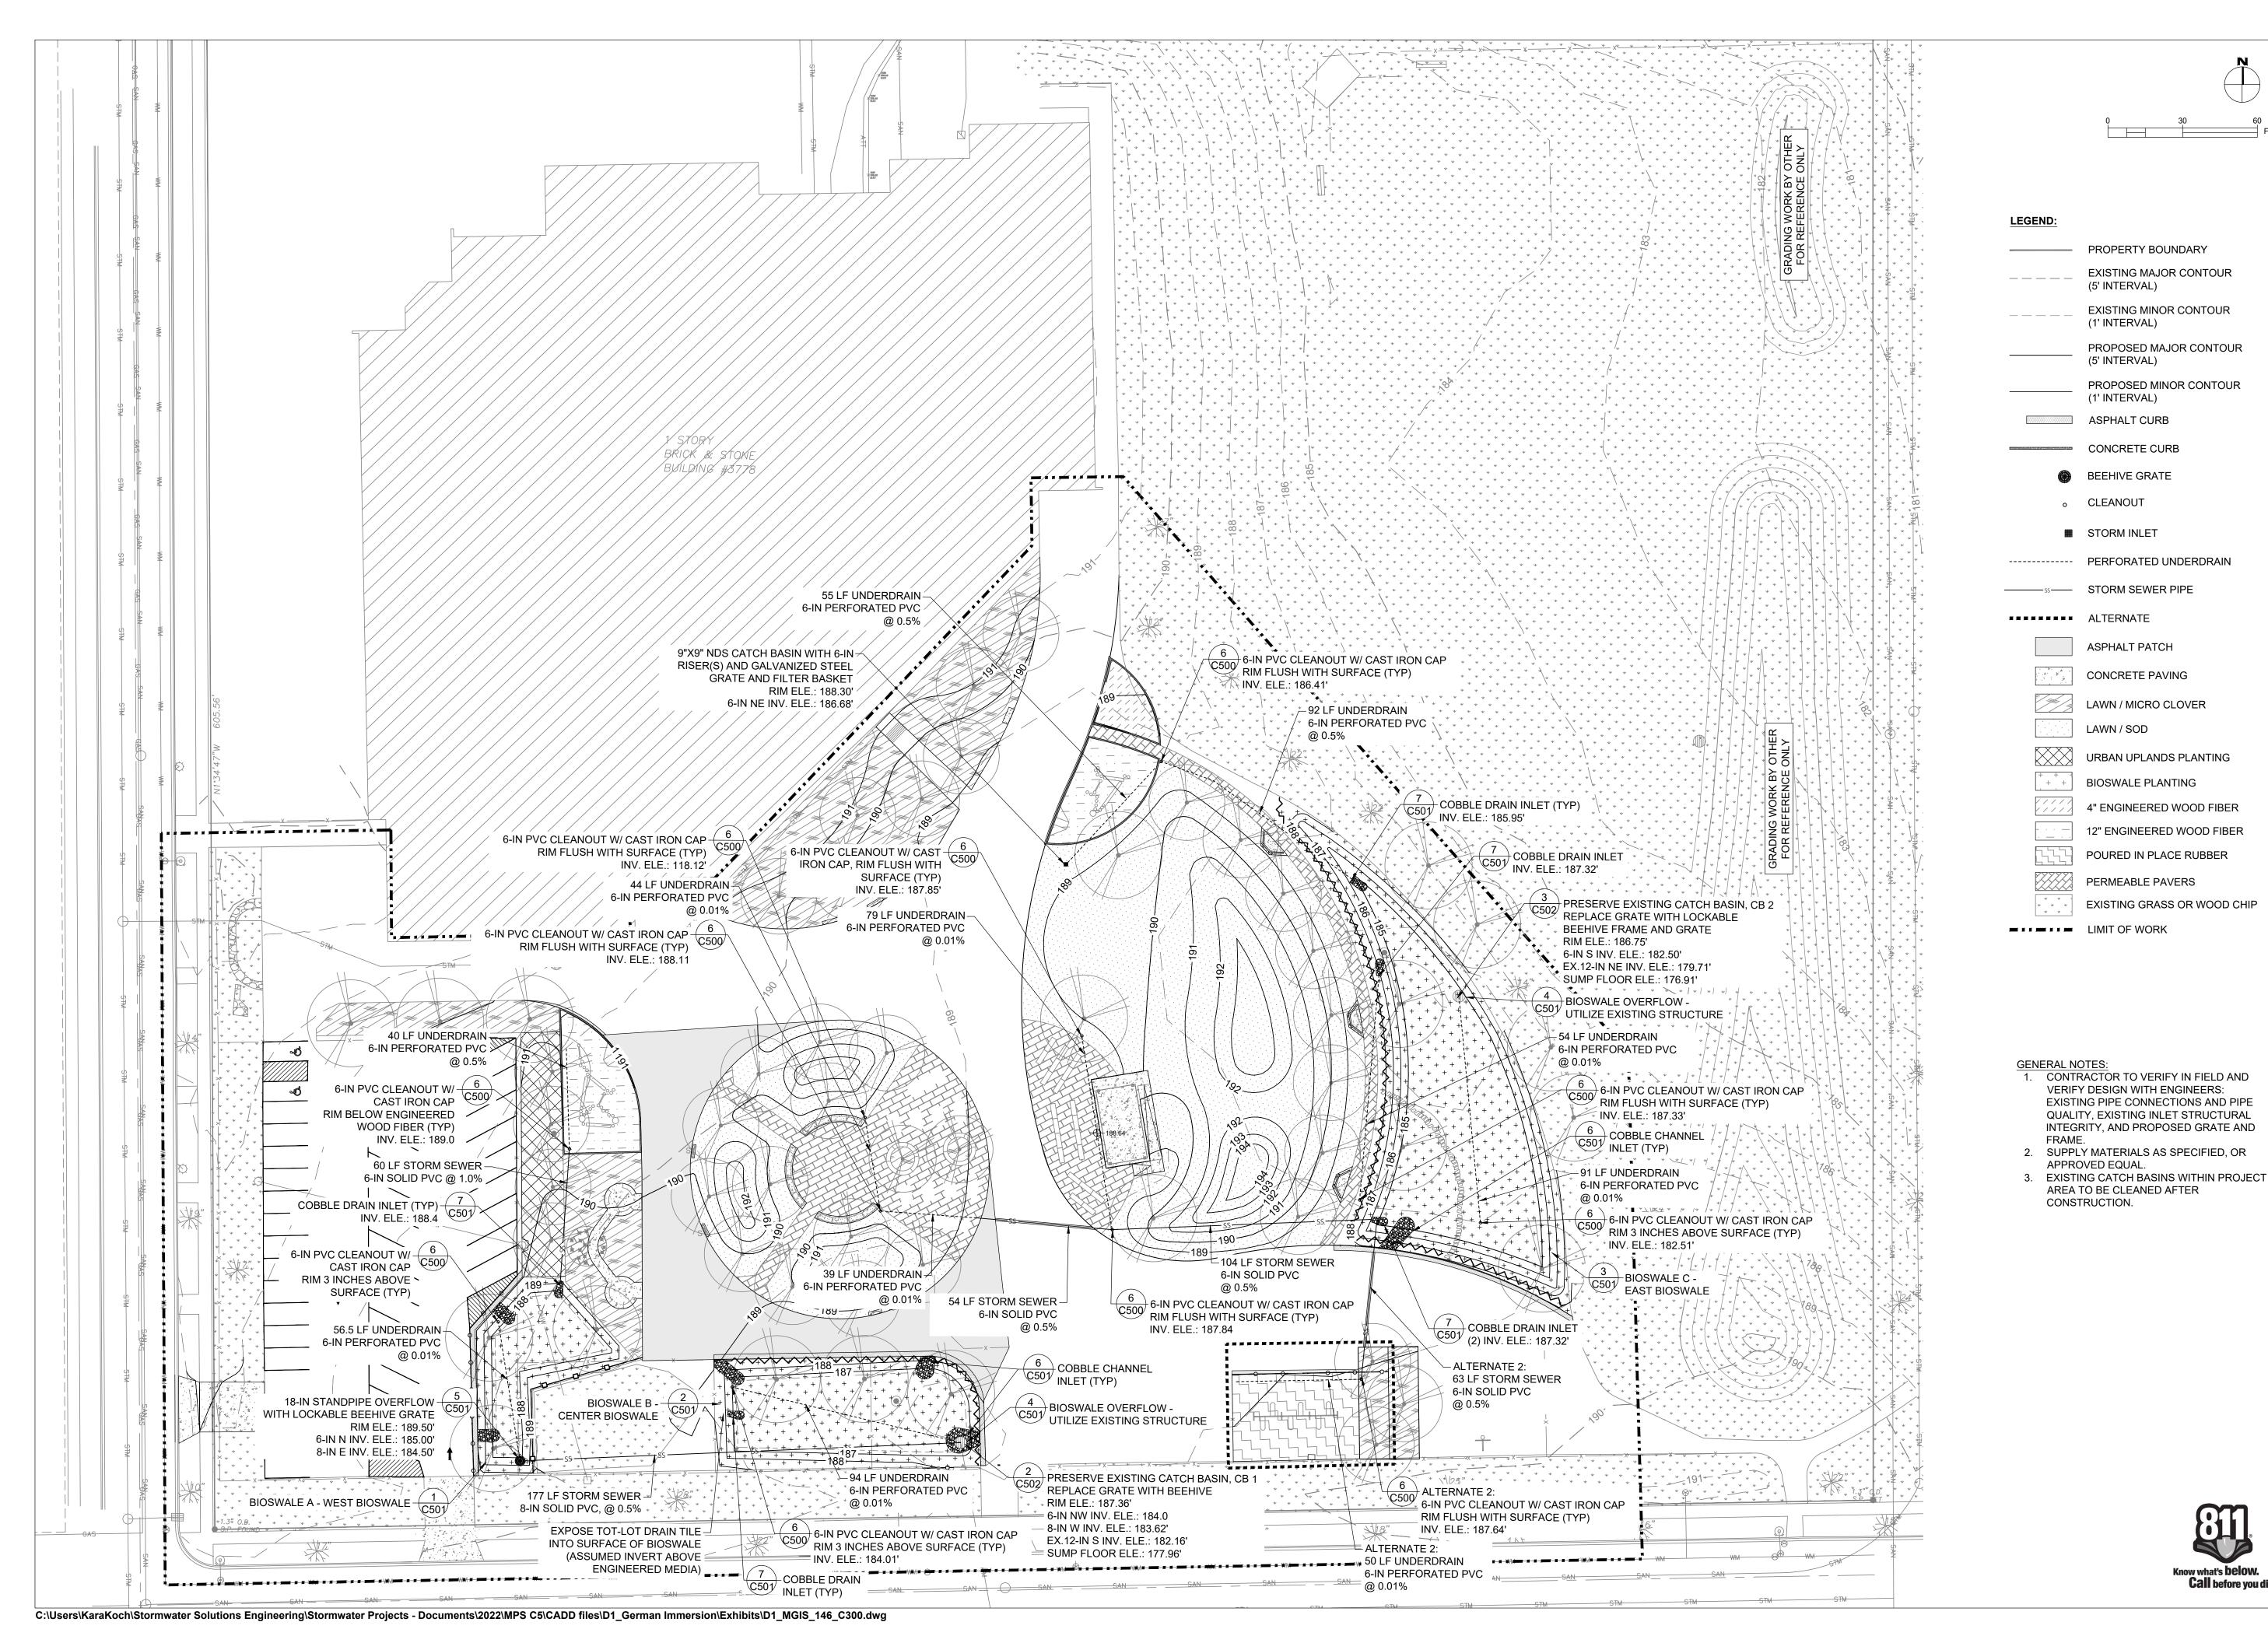



247 W. FRESHWATER WAY, SUITE 410 MILWAUKEE, WI 53204 PHONE: (414) 810-1245 WWW.STORMWATER-SOLUTIONS-**ENGINEERING.COM**



LEARNING LANDSCAPES DESIGN, LLC **4241 SW TUNNELWOOD STREET** PORTLAND, OR 97221



DIVISION OF FACILITIES AND MAINTENANCE SERVICES

1124 NORTH 11TH STREET **MILWAUKEE, WI 53205-0259** PHONE: 414-283-4600 FAX: 414-283-4682

PROJECT NAME: 2023 GREEN INFRASTRUCTURE UPGRADES	PROJECT ADDRESS: MILWAUKEE GERMAN IMMERSION ELEMENTARY S 3778 N. 82ND STREET, MILWAUKEE, WI 53222
REV:	DATE:
	1 <u>1/14/2</u> 022
	1 <u>2/22/2</u> 022

AWN BY:	KLK	
VIEWED BY:	CNH	
PROVED BY:	CBG	
TE:	January 2023	
AL AND SIGNATURE		

SITE NUMBER: 146

Know what's **below**.

Call before you dig.

SHEET NAM STORM

ISSUED FOR:


50% CD


90% CD

100% CD

SHEET:

PROJECT NUMBER: 7331 (DIVISION 1)

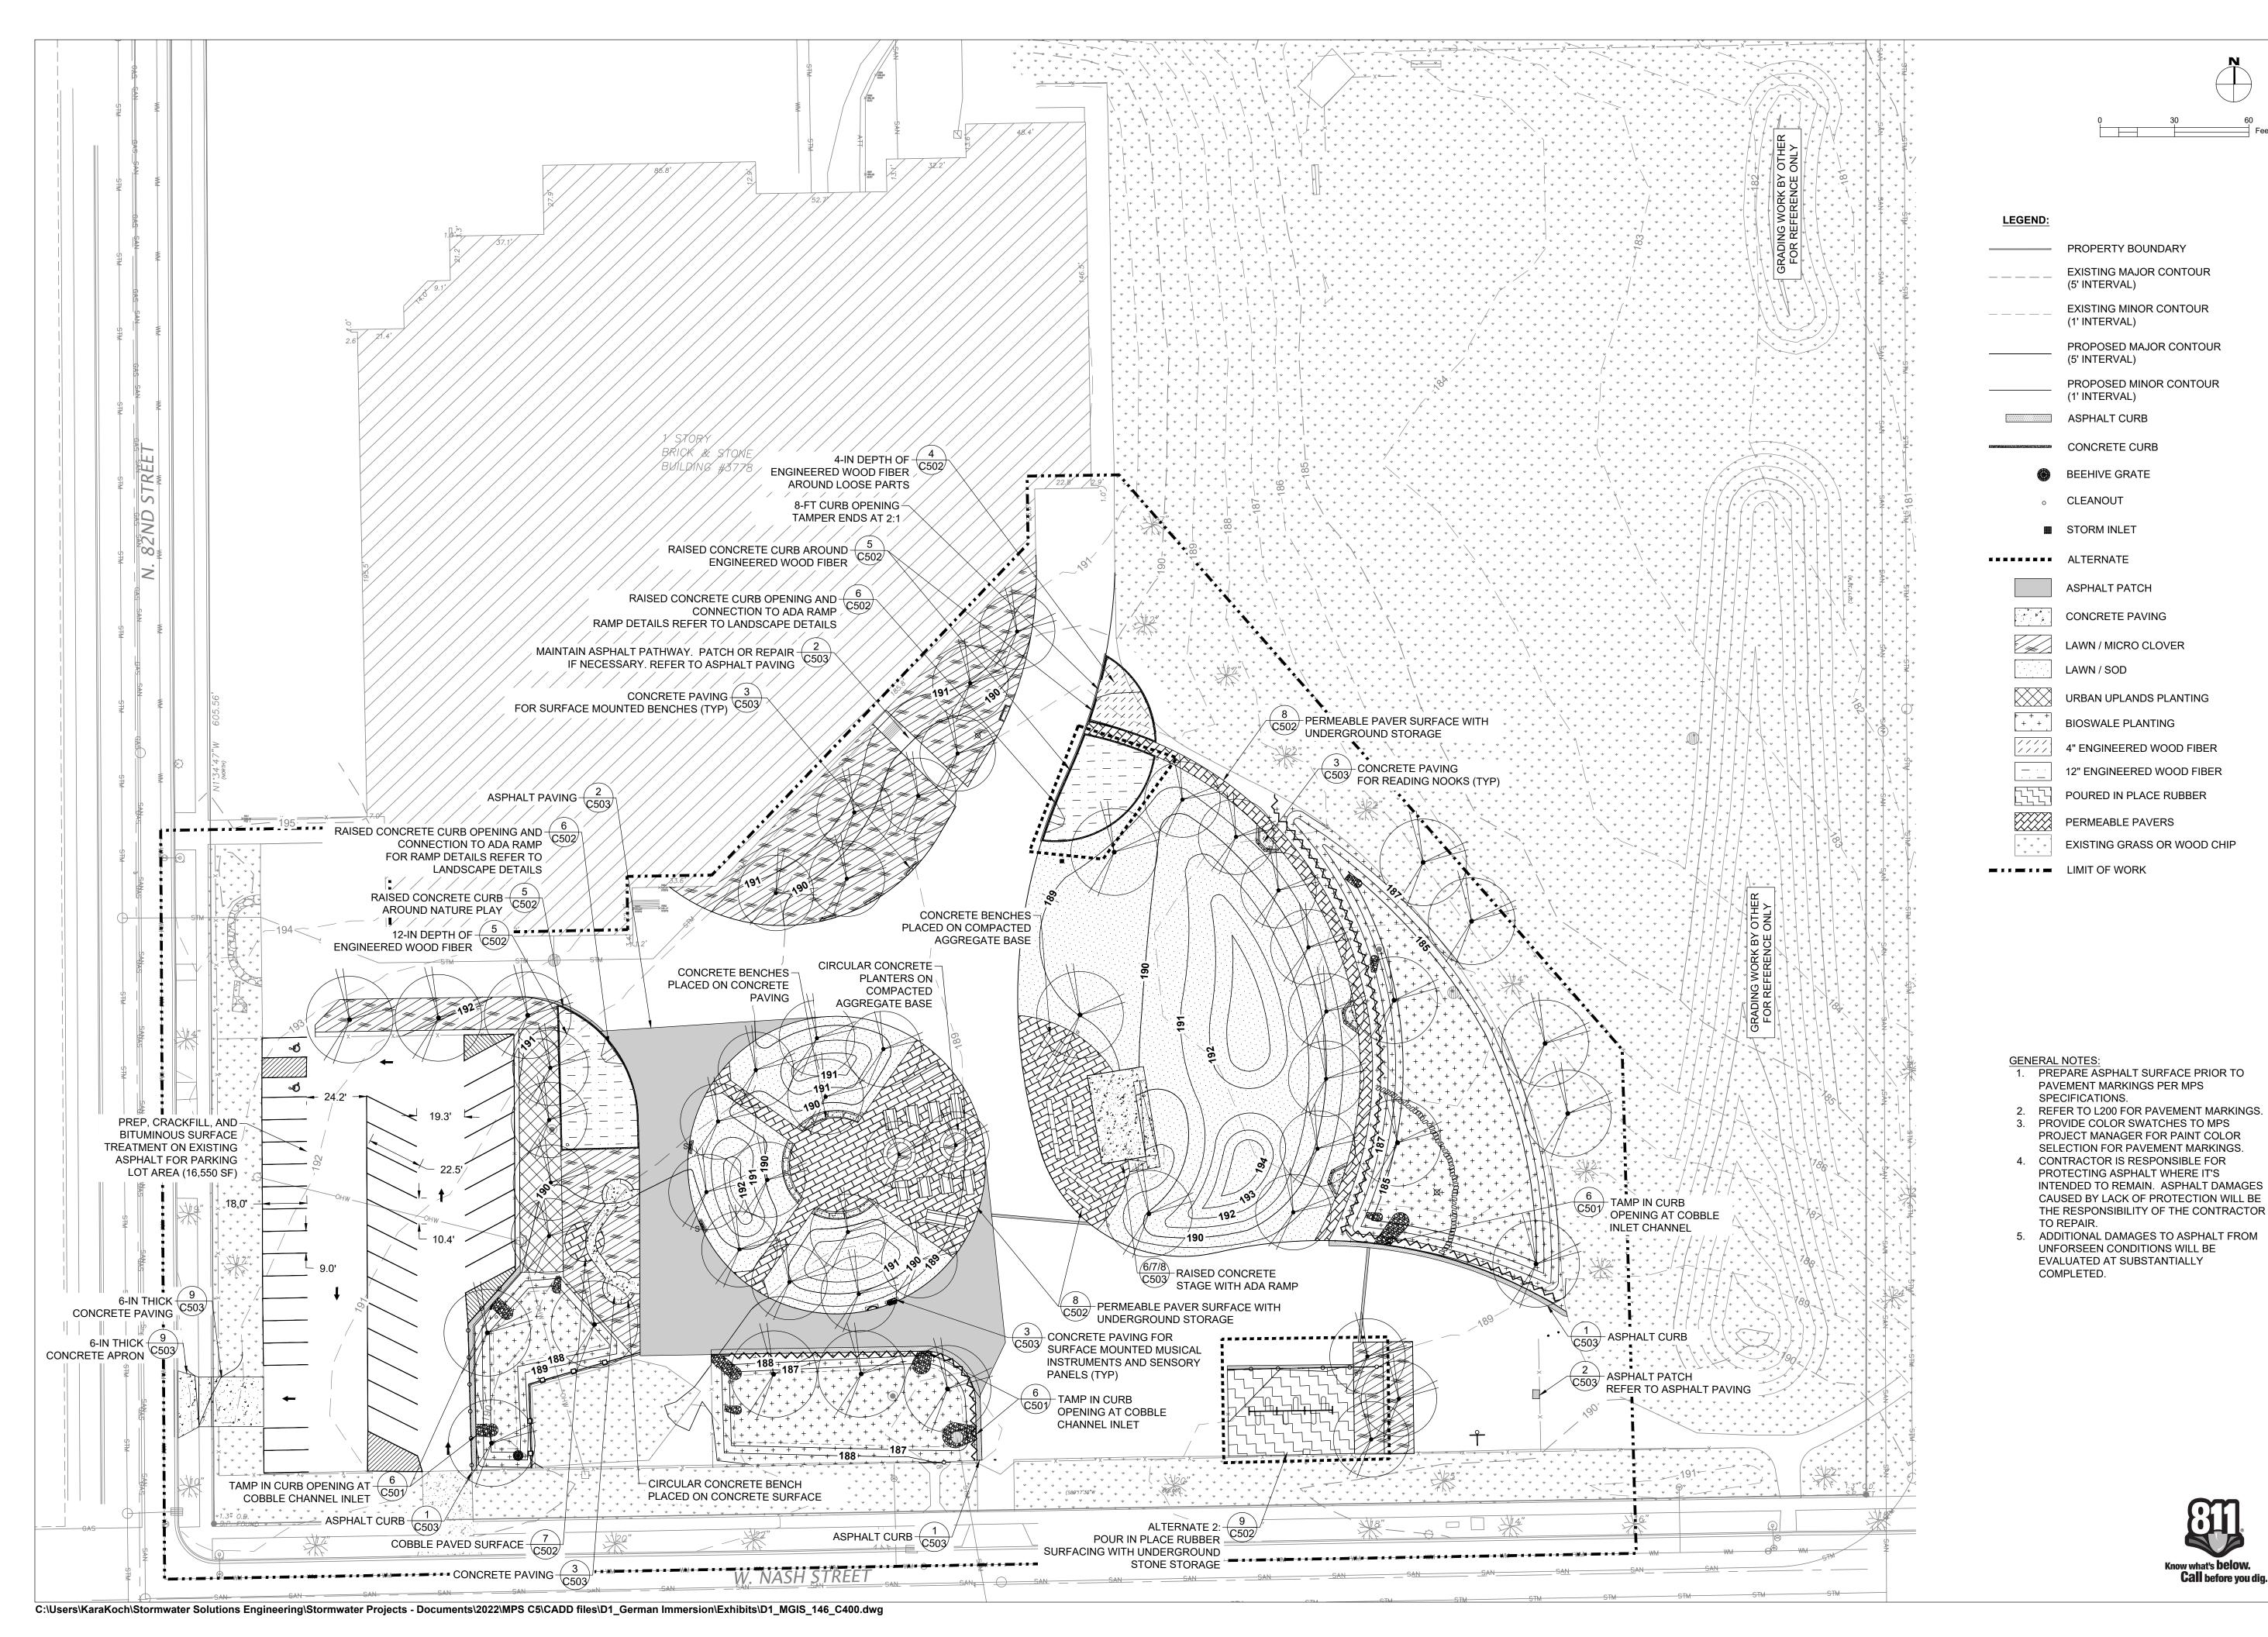

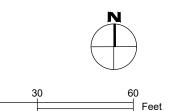

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MILWAUKEE, WI 53204 PHONE: (414) 810-1245 WWW.STORMWATER-SOLUTIONS-**ENGINEERING.COM**



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DIVISION OF FACILITIES AND MAINTENANCE SERVICES

1124 NORTH 11TH STREET **MILWAUKEE, WI 53205-0259** PHONE: 414-283-4600 FAX: 414-283-4682

11/14/2022

DRAWN BY: KLK **REVIEWED BY:** CNH **APPROVED BY:** CBG DATE: January 2023

SEAL AND SIGNATURE

PROJECT NUMBER: 7331 (DIVISION 1)

SITE NUMBER: 146


Know what's **below**.


Call before you dig.

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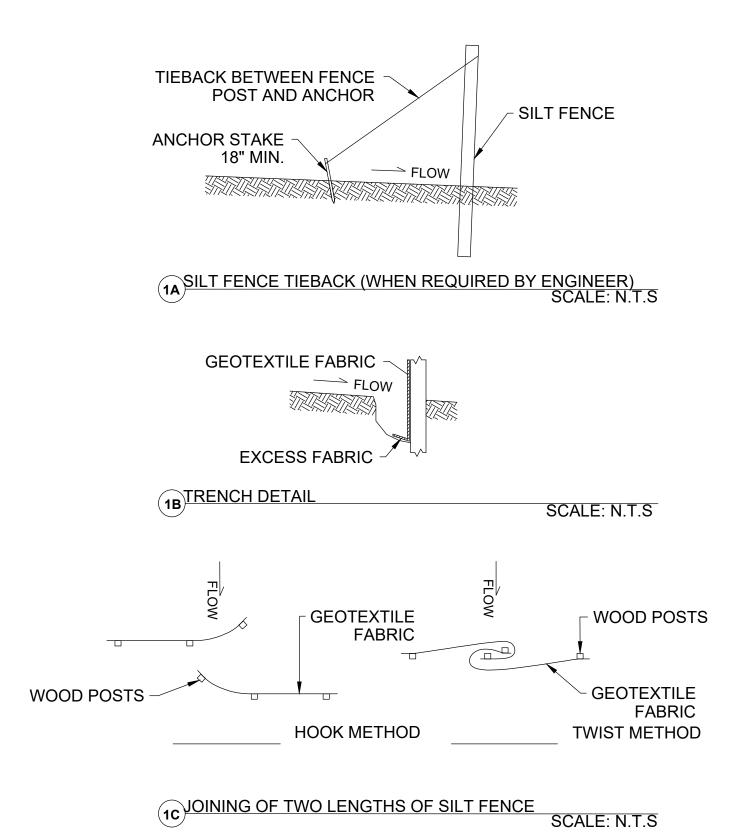
50% CD

SHEET:



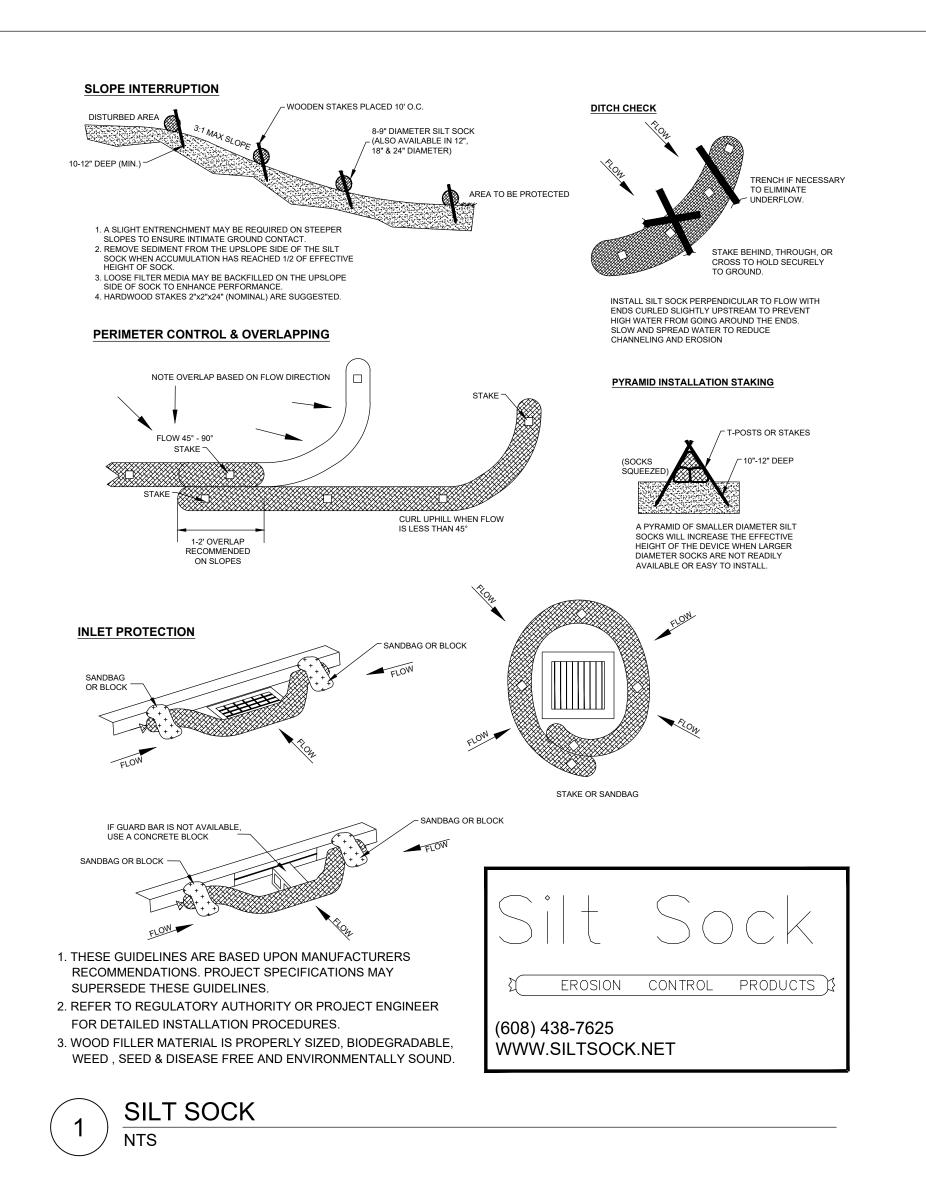

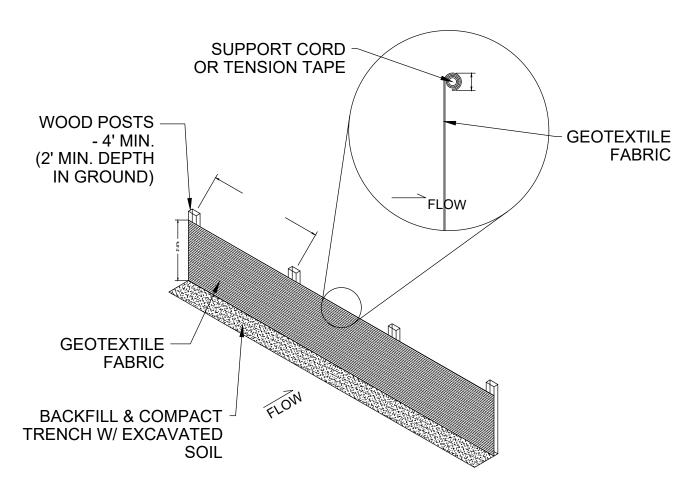SILT FENCE SCALE: N.T.S SILT FENCE NOTES: 1. ADDITIONAL POST DEPTH OR TIEBACKS MAY BE REQUIRED IN UNSTABLE SOILS. 2. 8' POST SPACING ALLOWED IF A WOVEN GEOTEXTILE FABRIC IS USED. 3. HORIZONTAL BRACE REQUIRED WITH 2"x4" WOODEN FRAME OR EQUIVALENT AT TOP OF POSTS. 4. FOR MANUAL INSTALLATIONS THE TRENCH SHALL BE A MINIMUM OF 4" WIDE & 6" DEEP TO BURY AND ANCHOR THE GEOTEXTILE FABRIC. FOLD MATERIAL TO FIT TRENCH AND BACKFILL & COMPACT TRENCH WITH EXCAVATED SOIL 5. WOOD POSTS SHALL BE A MINIMUM OF $1\frac{1}{8}$ "x $1\frac{1}{8}$ " OF OAK OR HICKORY. 6. SILT FENCE TO EXTEND ACROSS THE TOP OF THE PIPE 7. CONSTRUCT SILT FENCE FROM A CONTINUOUS ROLL IF POSSIBLE BY CUTTING LENGTHS TO AVOID JOINTS. IF A JOINT IS NECESSARY USE ONE OF THE FOLLOWING TWO METHODS; A.) OVERLAP THE END POSTS AND TWIST OR ROTATE AT LEAST 180 DEGREES, B.) HOOK THE END OF EACH SILT FENCE LENGTH.



CAST IRON CLEAN OUT


LID AND FITTING, BOLTED


CONNECT CAST IRON

ZURN NEO-LOC FITTING OR


EQUIVALENT TO SECURELY



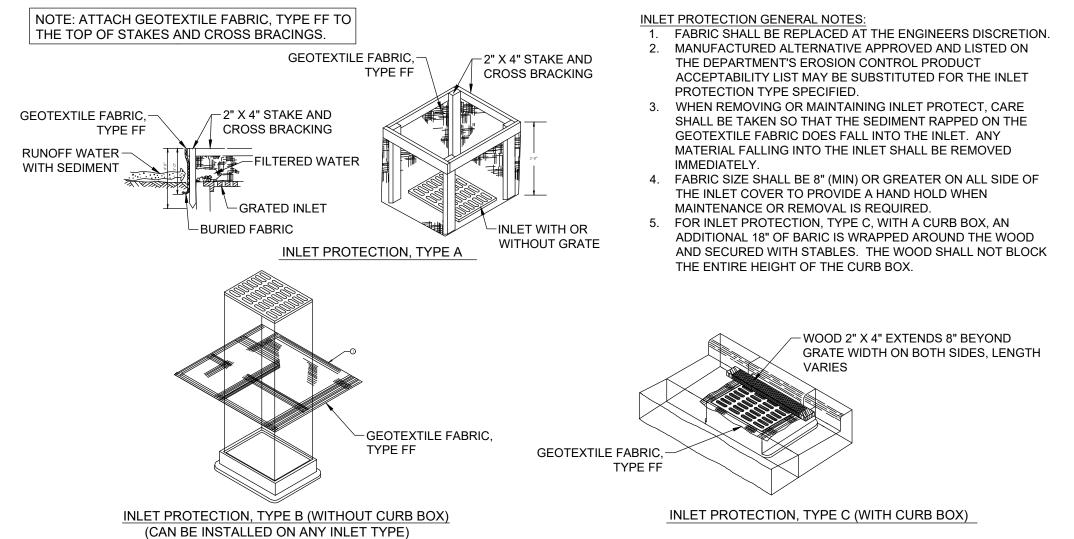

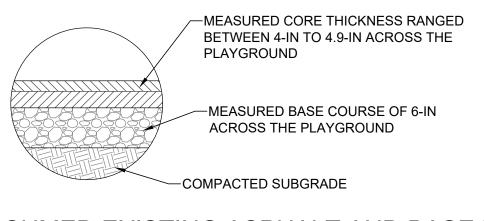



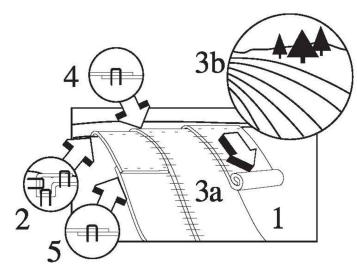


SLOPE APPLICATION NOTES: PREPARE SOIL SO THAT AREA IS SMOOTH, THEN ADD SEED, FERTILIZER & LIME AS REQUIRED.


START BY STAPLING THE BLANKET AT THE TOP OF THE SLOPE IN A 6" DEEP X 6" WIDE TRENCH. BACKFILL & COMPACT TRENCH SO THAT THE WATER WILL FLOW EVENLY ONTO THE BLANKET.

3. (a). ROLL BLANKET DOWN THE SLOPE, OR (b) HORIZONTALLY ACROSS SLOPES <50 FEET, INSURING SOIL BLANKET CONTACT. 4. OVERLAP EDGES OF BLANKET A MINIMUM OF 2" WITH

PARALLEL BLANKETS. 5. IF MORE THAN ONE BLANKET IS NEEDED FOR THE RUN THEN OVERLAP ADJOINING ENDS A MINIMUM OF 4"

SHINGLE STYLE. STAPLE OVERLAP AREAS WITH STAGGERED PATTERN WITH STAPLES.

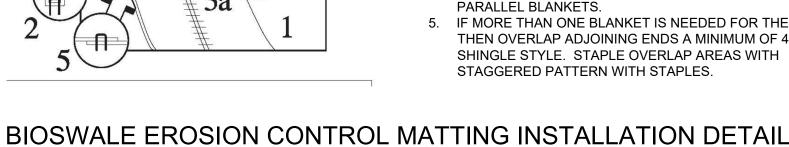

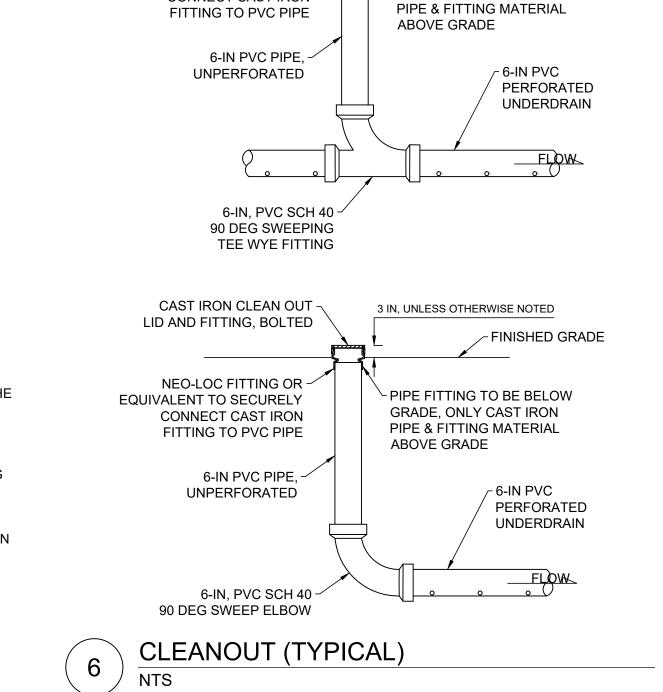

3 IN, UNLESS OTHERWISE NOTED

PIPE FITTING TO BE BELOW


GRADE, ONLY CAST IRON

FINISHED GRADE


STORMWATER SOLUTIONS ENGINEERING 247 W. FRESHWATER WAY, SUITE 410 MILWAUKEE, WI 53204 PHONE: (414) 810-1245 WWW.STORMWATER-SOLUTIONS-**ENGINEERING.COM _**andscapes LEARNING LANDSCAPES DESIGN, LLC **4241 SW TUNNELWOOD STREET** PORTLAND, OR 97221 **MILWAUKEE PUBLIC SCHOOLS DIVISION OF FACILITIES AND** MAINTENANCE SERVICES **1124 NORTH 11TH STREET MILWAUKEE, WI 53205-0259** PHONE: 414-283-4600 FAX: 414-283-4682 S GREI ISSUED FOR: DATE: 1<u>1/14/2</u>022 50% CD 90% CD 1<u>2/22/2</u>022 <u>1/23/2</u>023 100% CD **DRAWN BY:** KLK **REVIEWED BY:** CNH CBG **APPROVED BY:** DATE: January 2023 **SEAL AND SIGNATURE** PROJECT NUMBER: 7331 (DIVISION 1) SITE NUMBER: 146 SHEET:

C500


INLET PROTECTION DETAIL

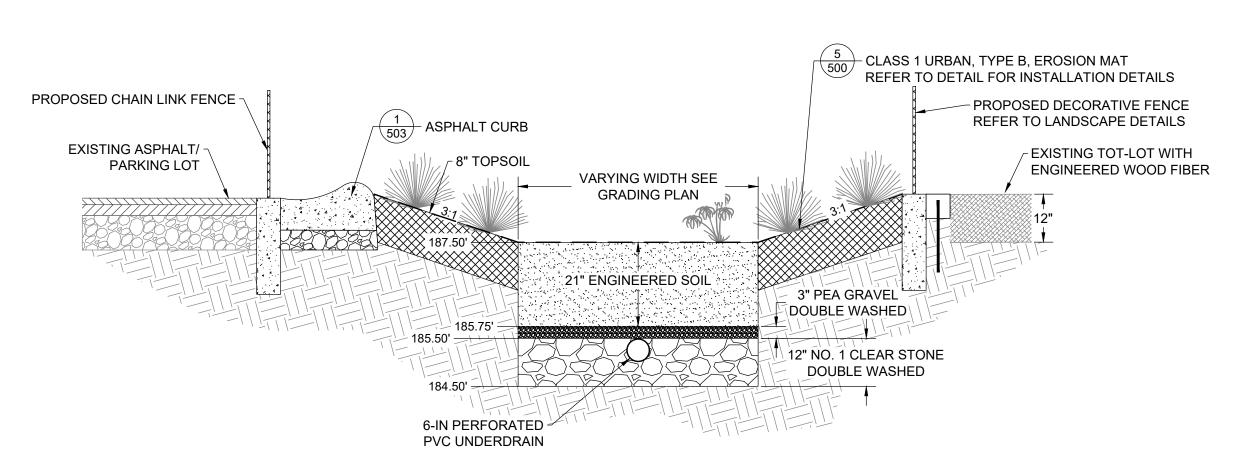


1 BIOSWALE A - WEST BIOSWALE

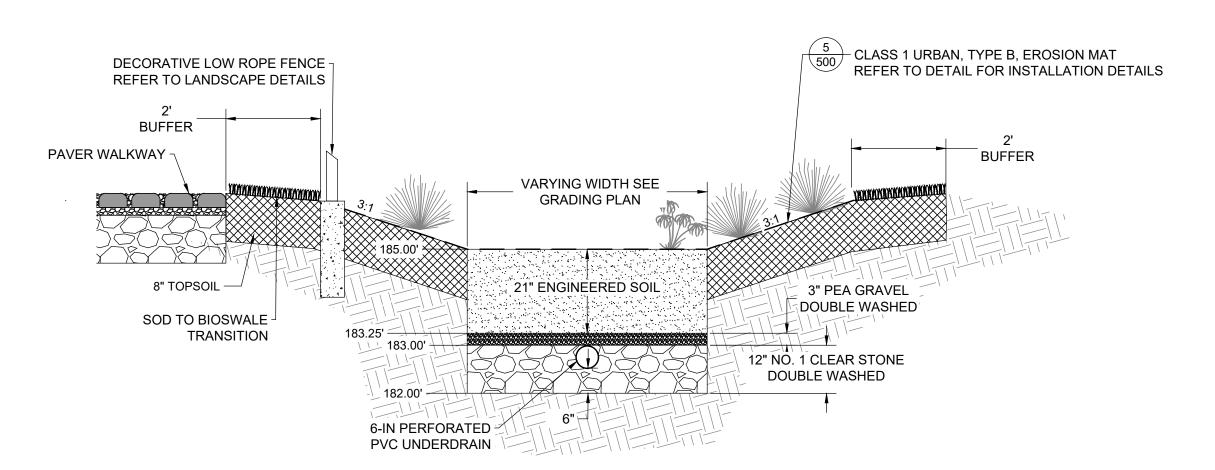


3 BIOSWALE C - EAST BIOSWALE

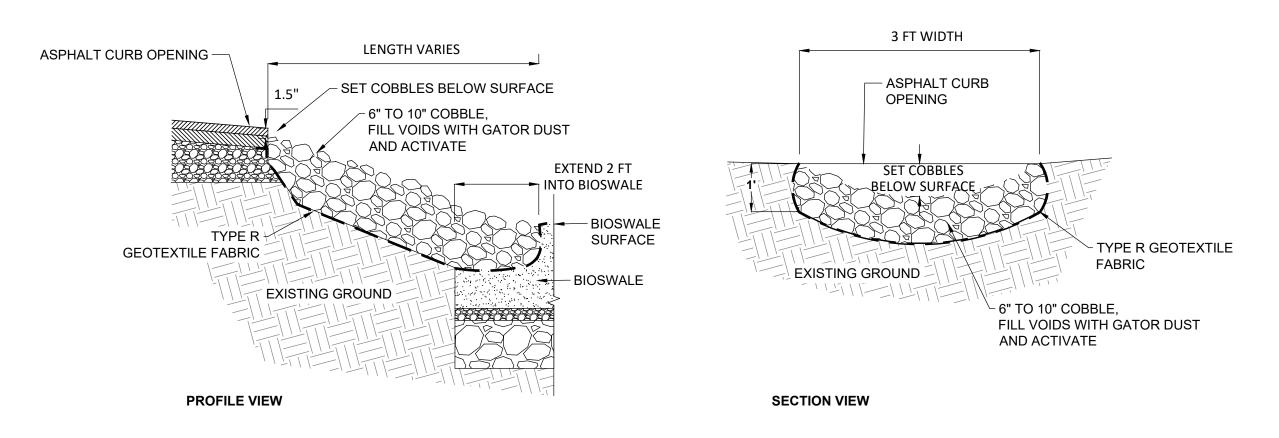


6 COBBLE CHANNEL INLET

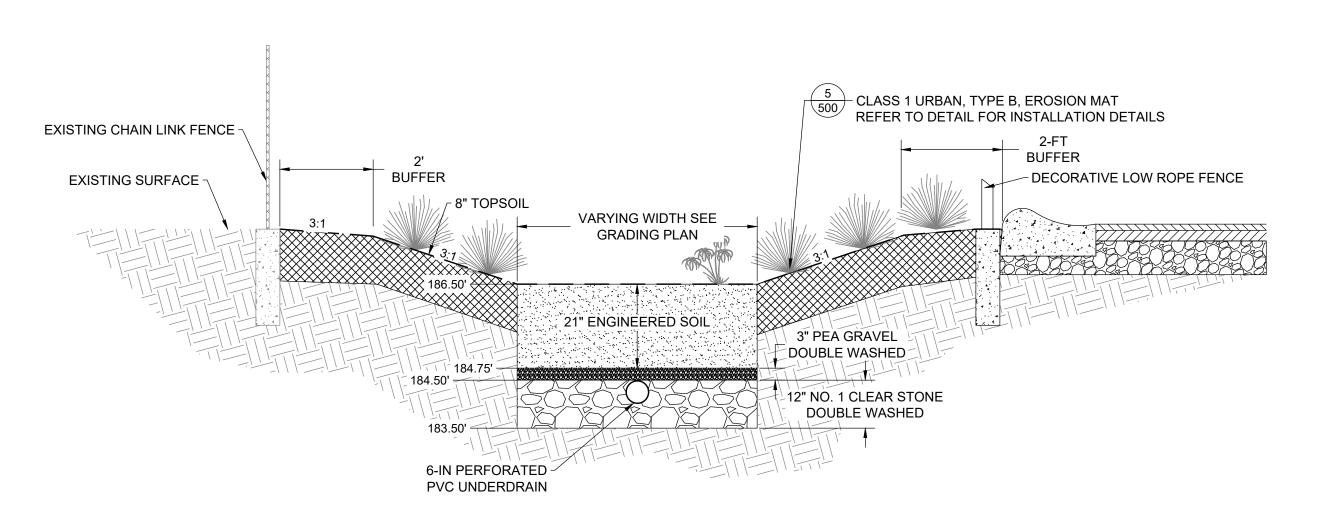

2 BIOSWALE B - CENTER BIOSWALE

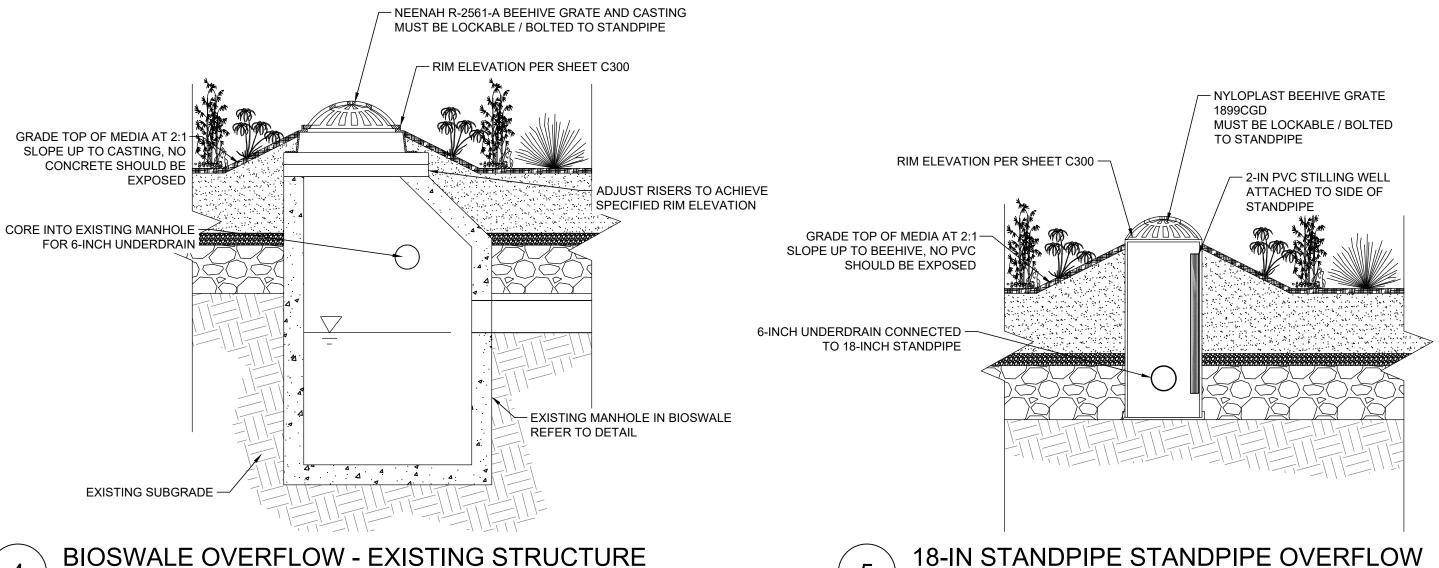

 $\underbrace{ \text{ 4 } }_{\text{NTS}} \underbrace{ \text{ BIOSWALE OVERFLOW - EXISTING STRUCTURE} }_{\text{NTS}}$

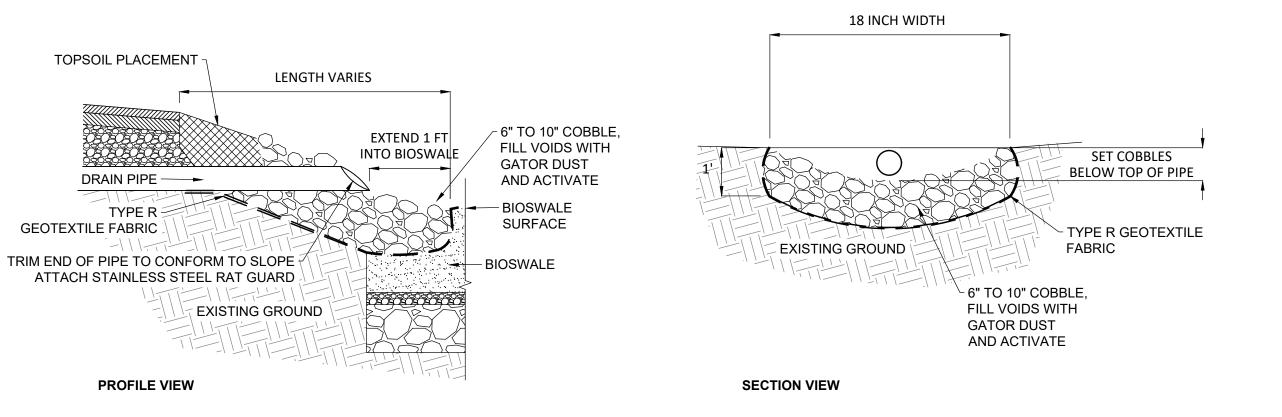

7 COBBLE DRAIN INLET

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DIVISION OF FACILITIES AND MAINTENANCE SERVICES

1124 NORTH 11TH STREET MILWAUKEE, WI 53205-0259 PHONE: 414-283-4600 FAX: 414-283-4682

1023 GREEN INFRASTRUCTURE UPGRADES

ROJECT ADDRESS:

ILWAUKEE GERMAN IMMERSION ELEMENTARY SCHOOL

778 N 82ND STREET MII WALIKEE WI 53222

| SHEET NAME:
| SHEET NAME:
| SHEET NAME:
| SOURCE | SHEET NAME:
| S


DRAWN BY: KLK
REVIEWED BY: CNH
APPROVED BY: CBG
DATE: January 2023


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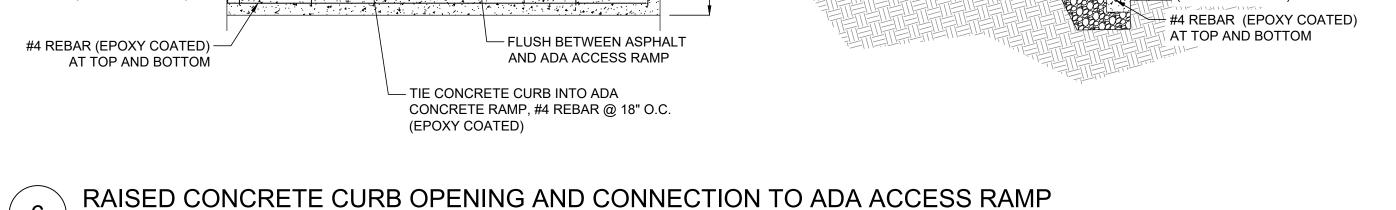
PROJECT NUMBER: 7331 (DIVISION 1)


SITE NUMBER: 146

SHEET:



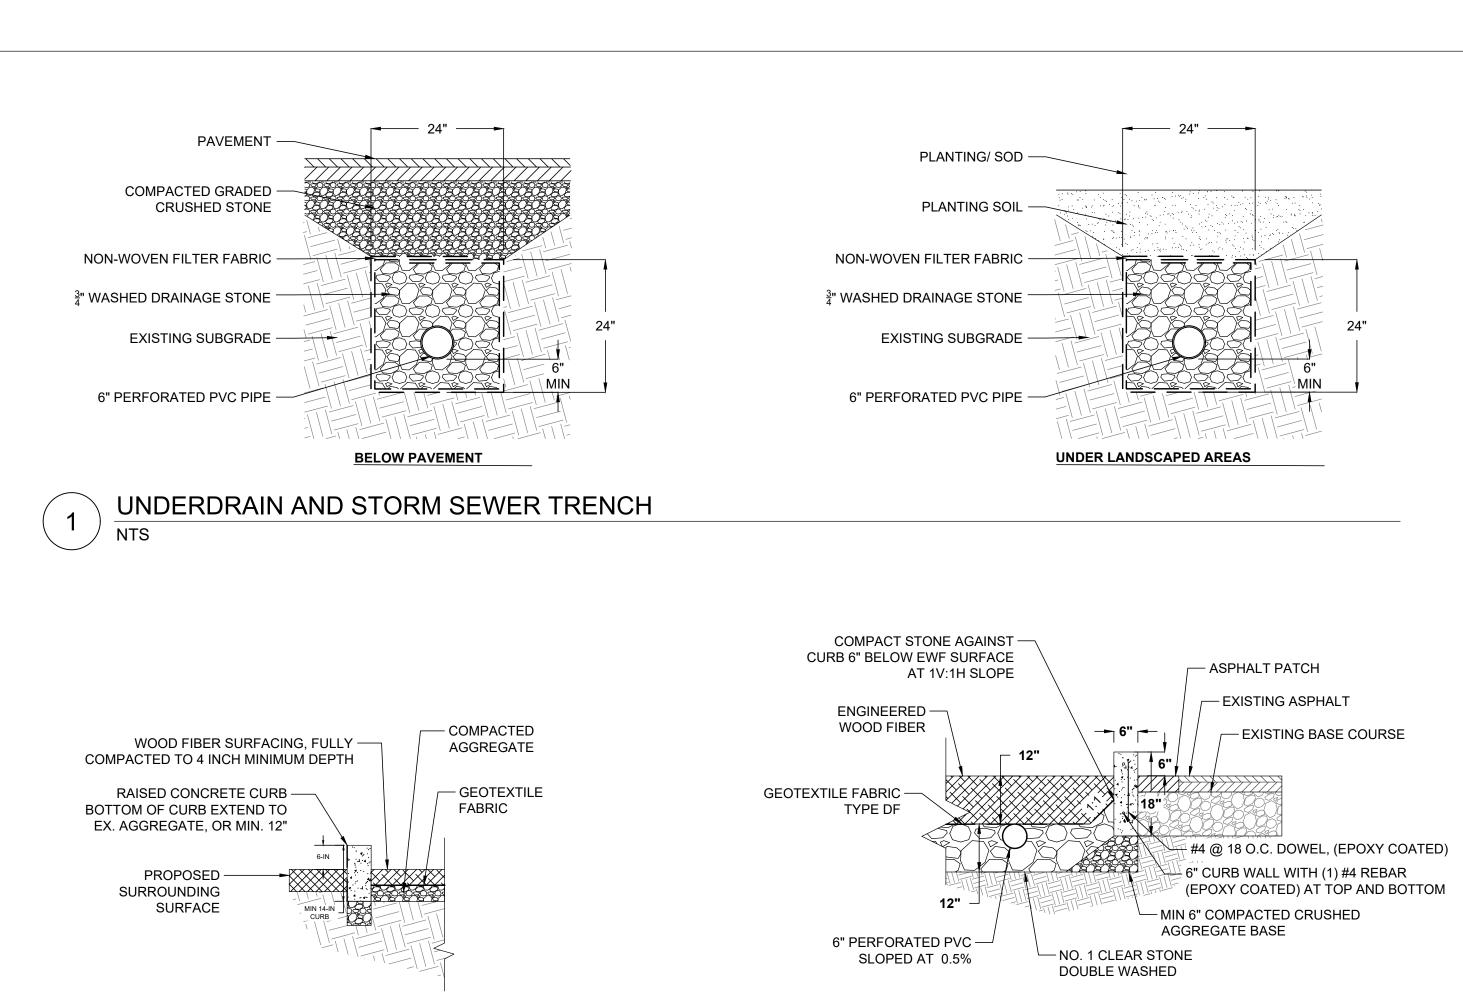

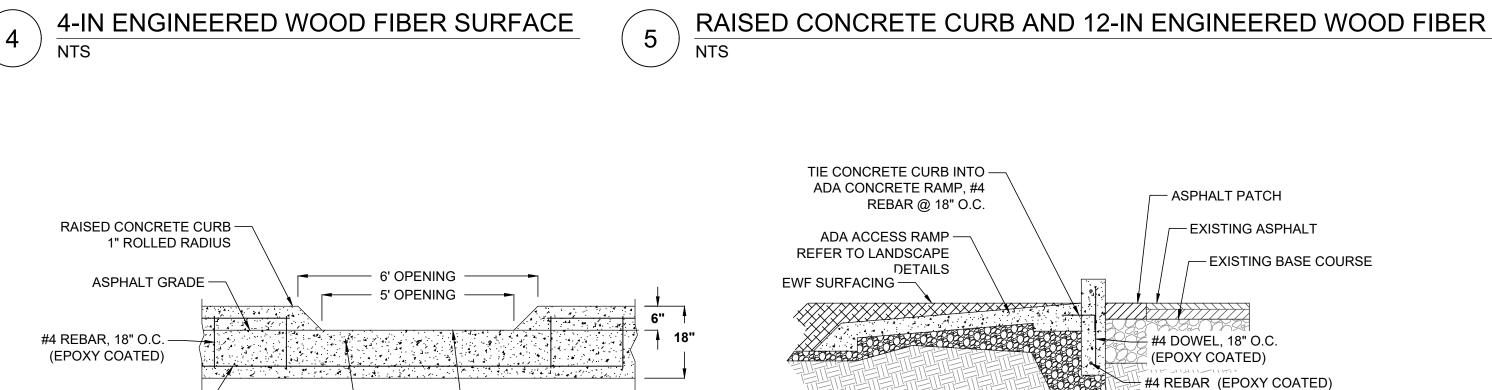


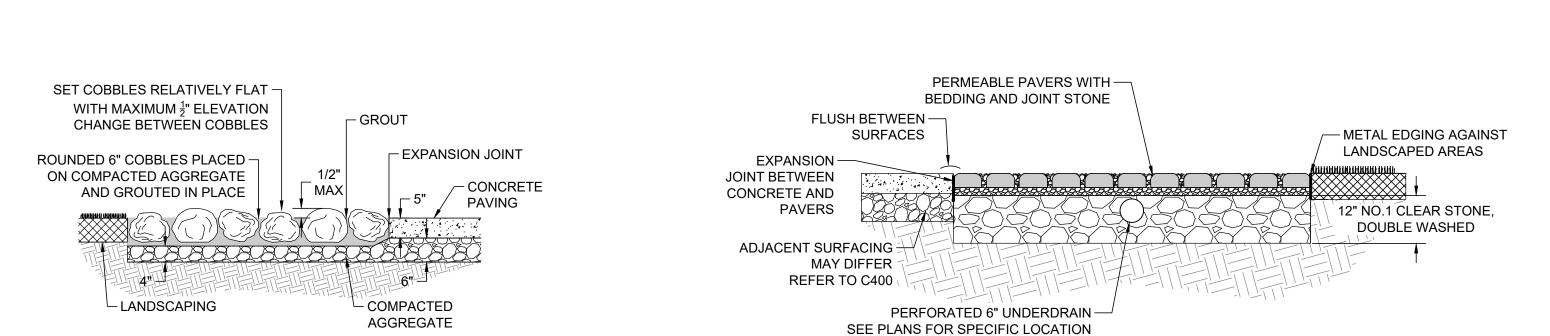




PERMEABLE PAVER SURFACE WITH UNDERGROUND STORAGE


NTS

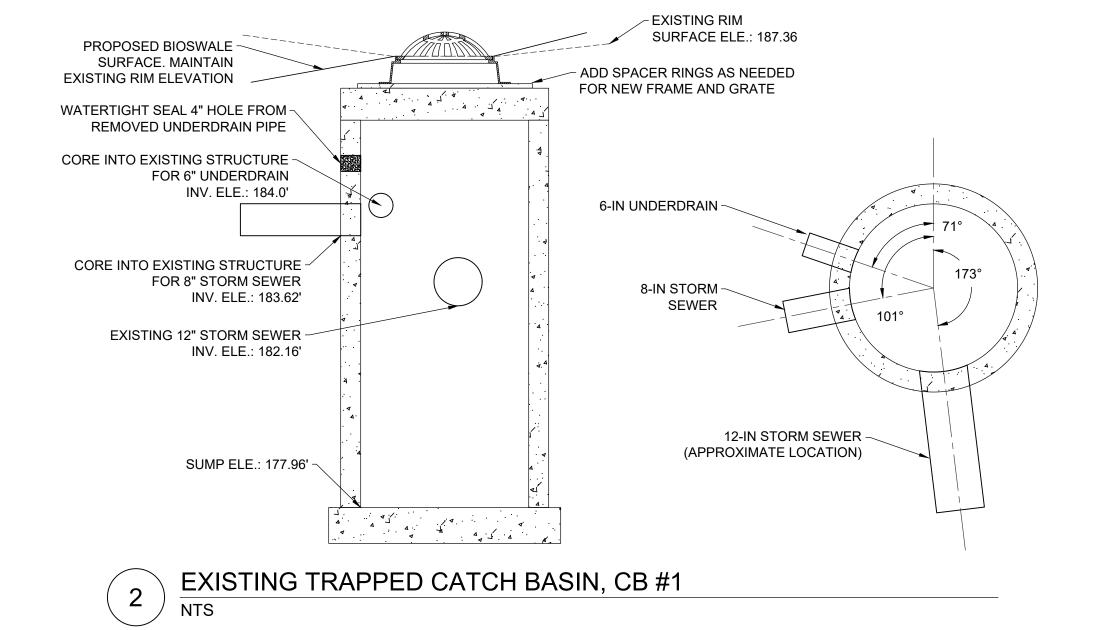

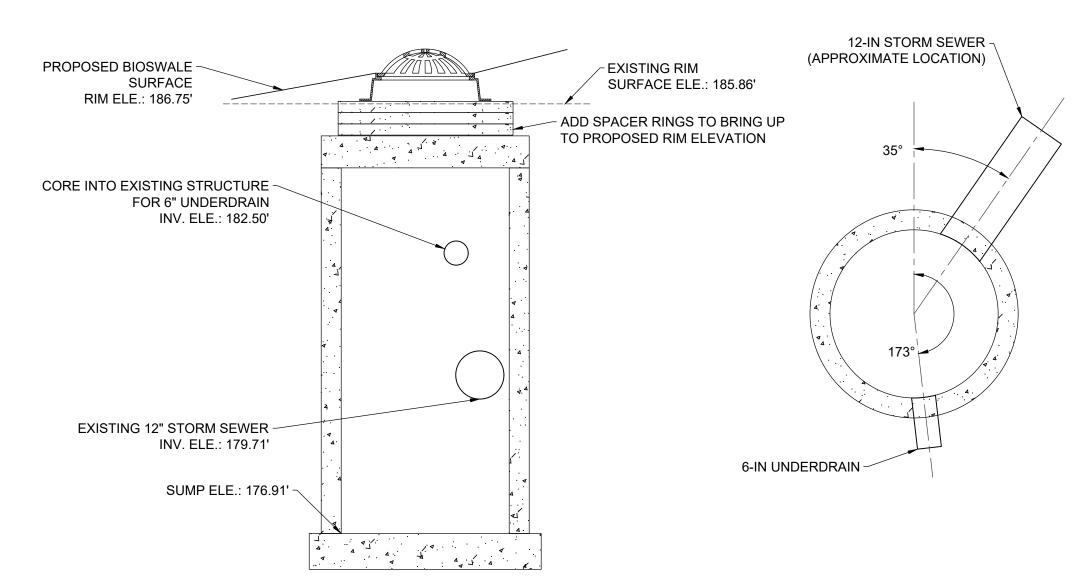

EXISTING TRAPPED CATCH BASIN, CB #2

9

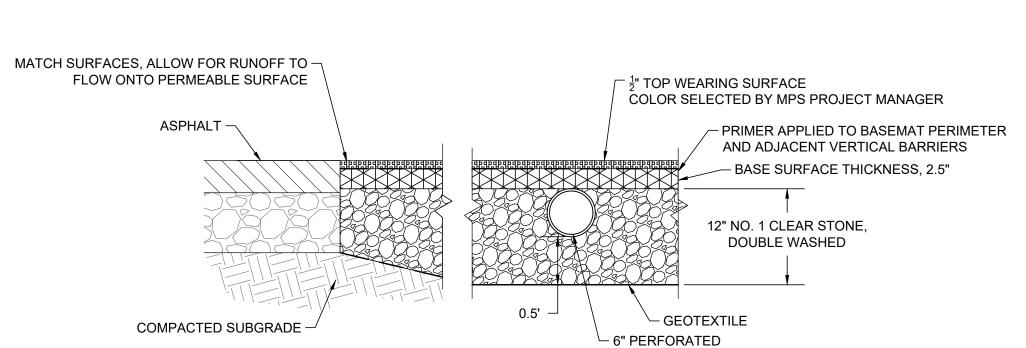

POUR-IN-PLACE RUBBER SURFACE WITH UNDERGROUND STORAGE

NTS

UNDERDRAIN

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SHEET NAME:

DETAILS

PROJECT NAME:

2023 GREEN INFRASTRUCTURE UPGRADES

PROJECT ADDRESS:

MILWAUKEE GERMAN IMMERSION ELEMENTARY SCHOOL

DRAWN BY: KLK
REVIEWED BY: CNH
APPROVED BY: CBG
DATE: January 2023
SEAL AND SIGNATURE

1<u>1/14/2</u>022

1<u>2/22/2</u>022

1/23/2023

50% CD


90% CD

100% CD

PROJECT NUMBER: 7331 (DIVISION 1)

SHEET:

SITE NUMBER: 146

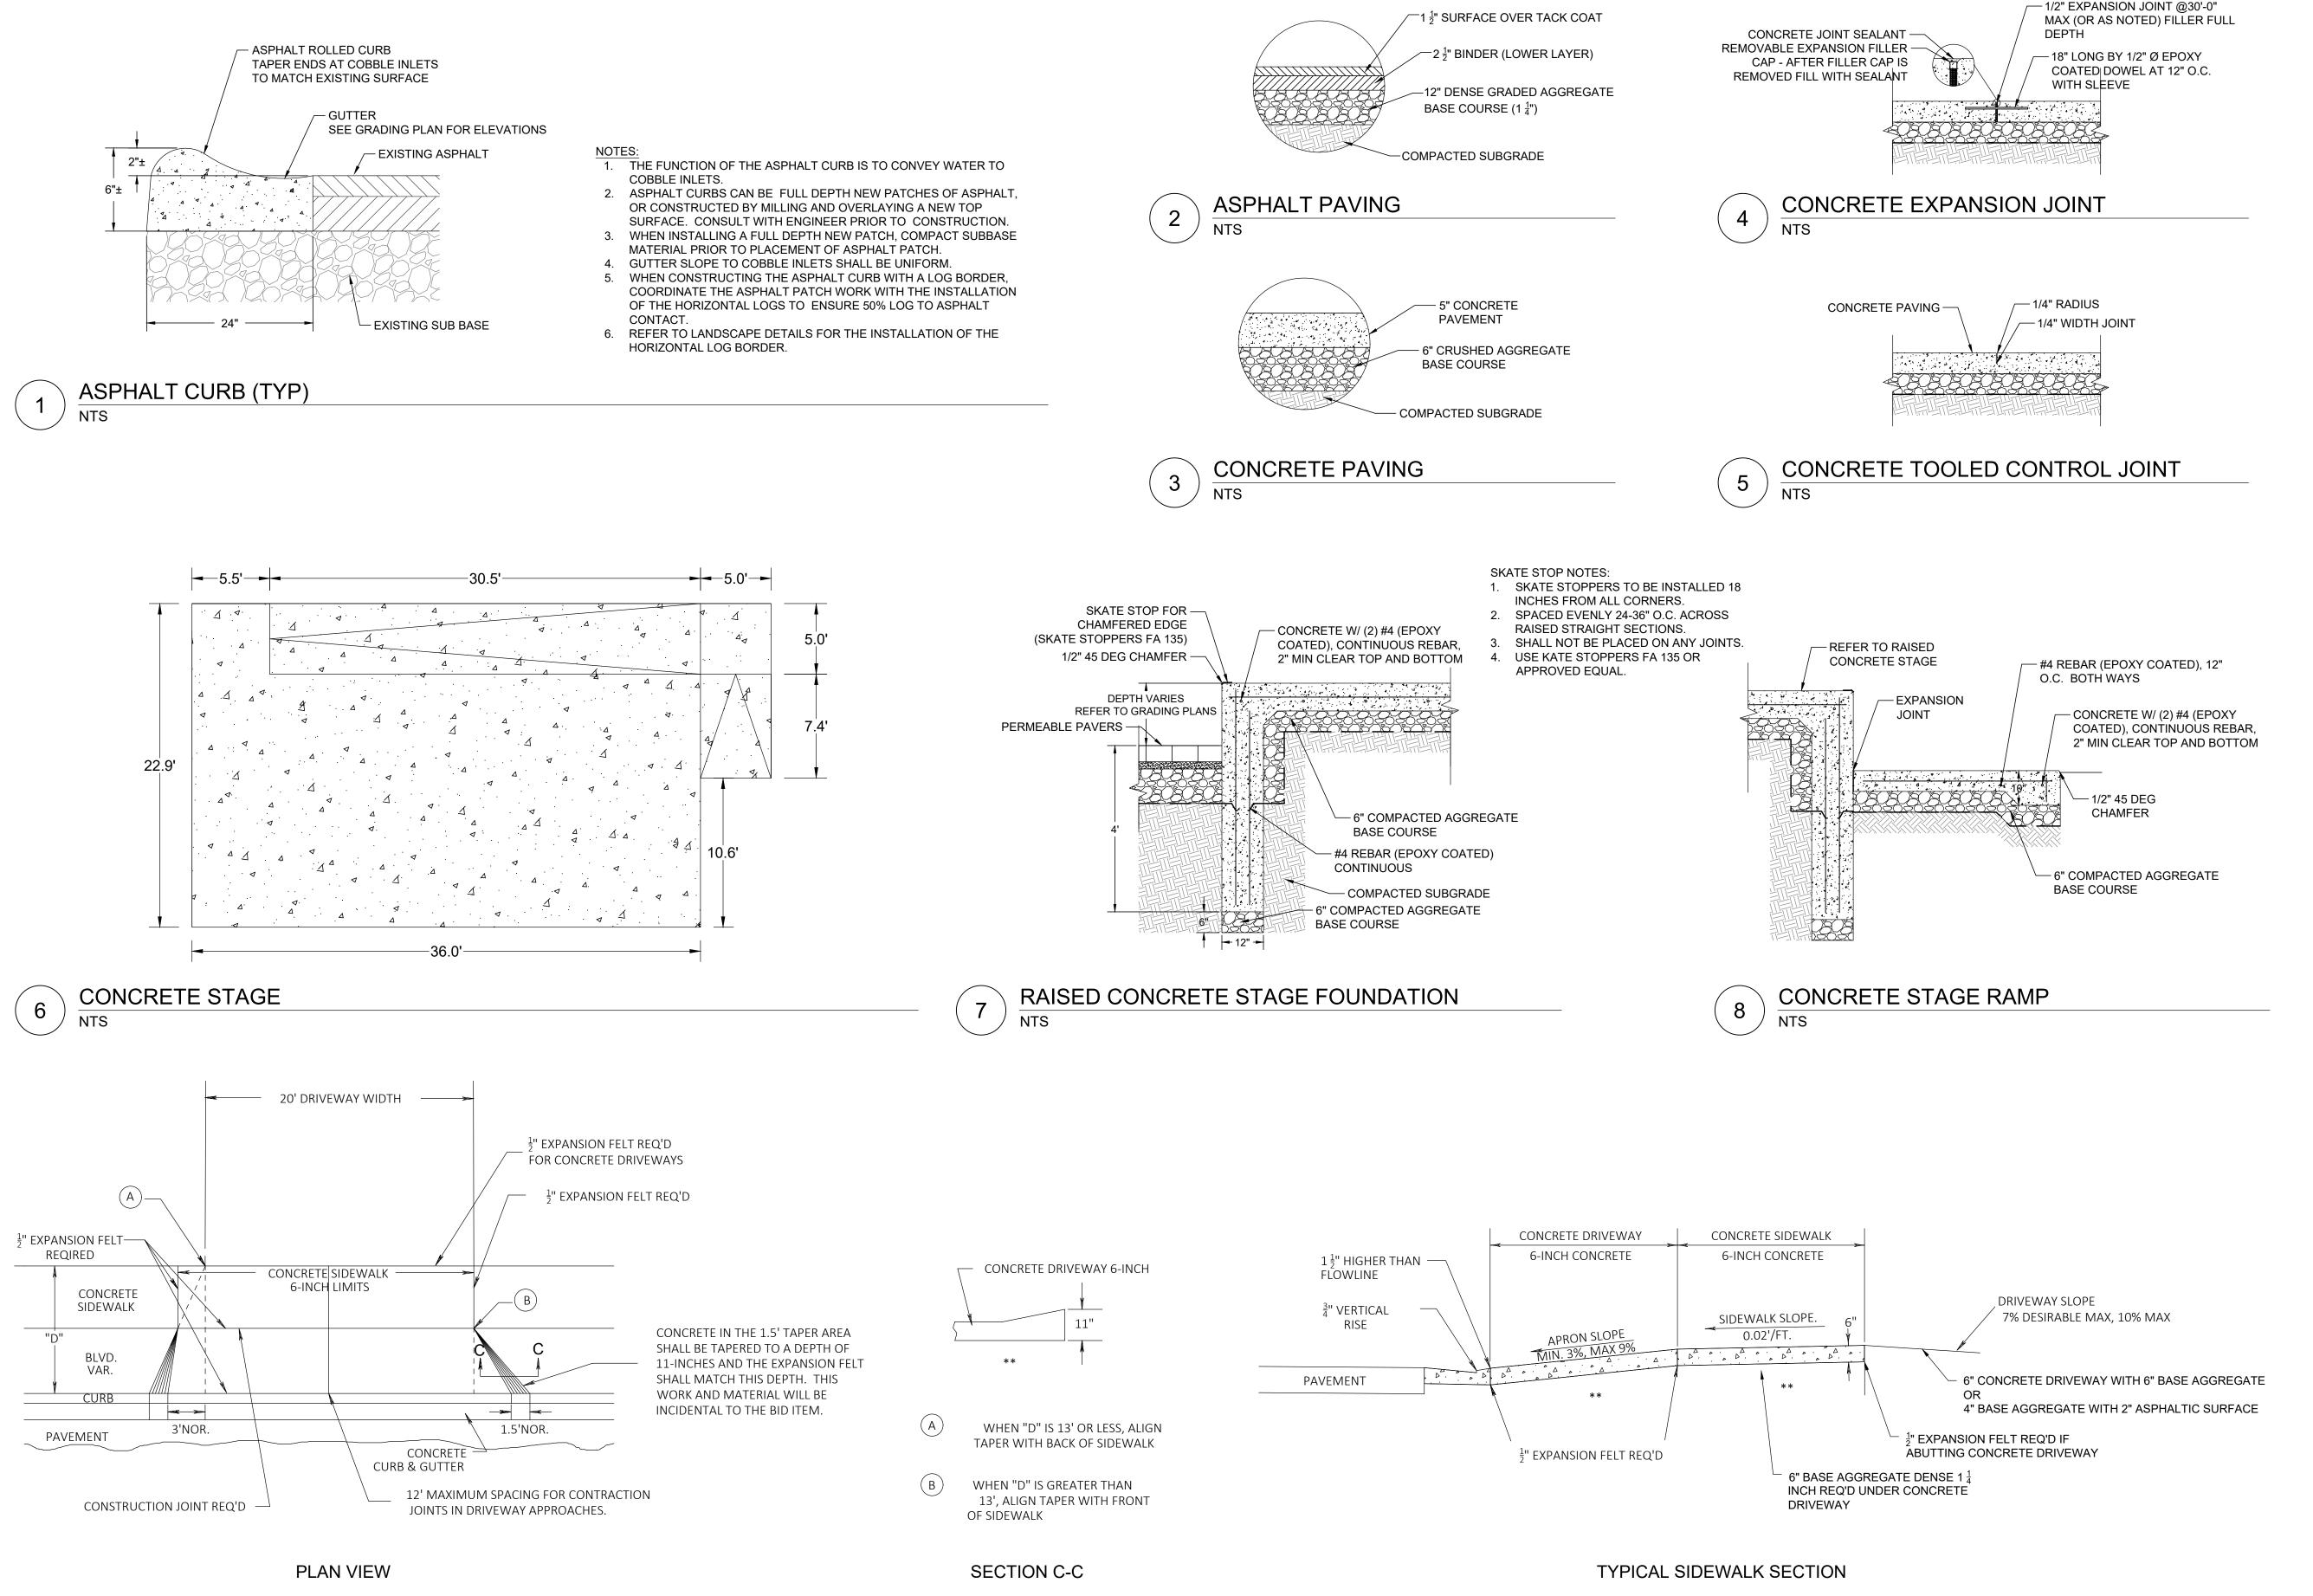

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1124 NORTH 11TH STREET MILWAUKEE, WI 53205-0259 PHONE: 414-283-4600 FAX: 414-283-4682

2023 GREEN INFRASTRUCTURE UPGRADES
PROJECT ADDRESS:
MILWAUKEE GERMAN IMMERSION ELEMENTARY SCHOOL
3778 N. 82ND STREET, MILWAUKEE, WI 53222

| SHEET NAME: |

DRAWN BY: KLK
REVIEWED BY: CNH
APPROVED BY: CBG
DATE: January 2023

SEAL AND SIGNATURE

PROJECT NUMBER: 7331 (DIVISION 1)


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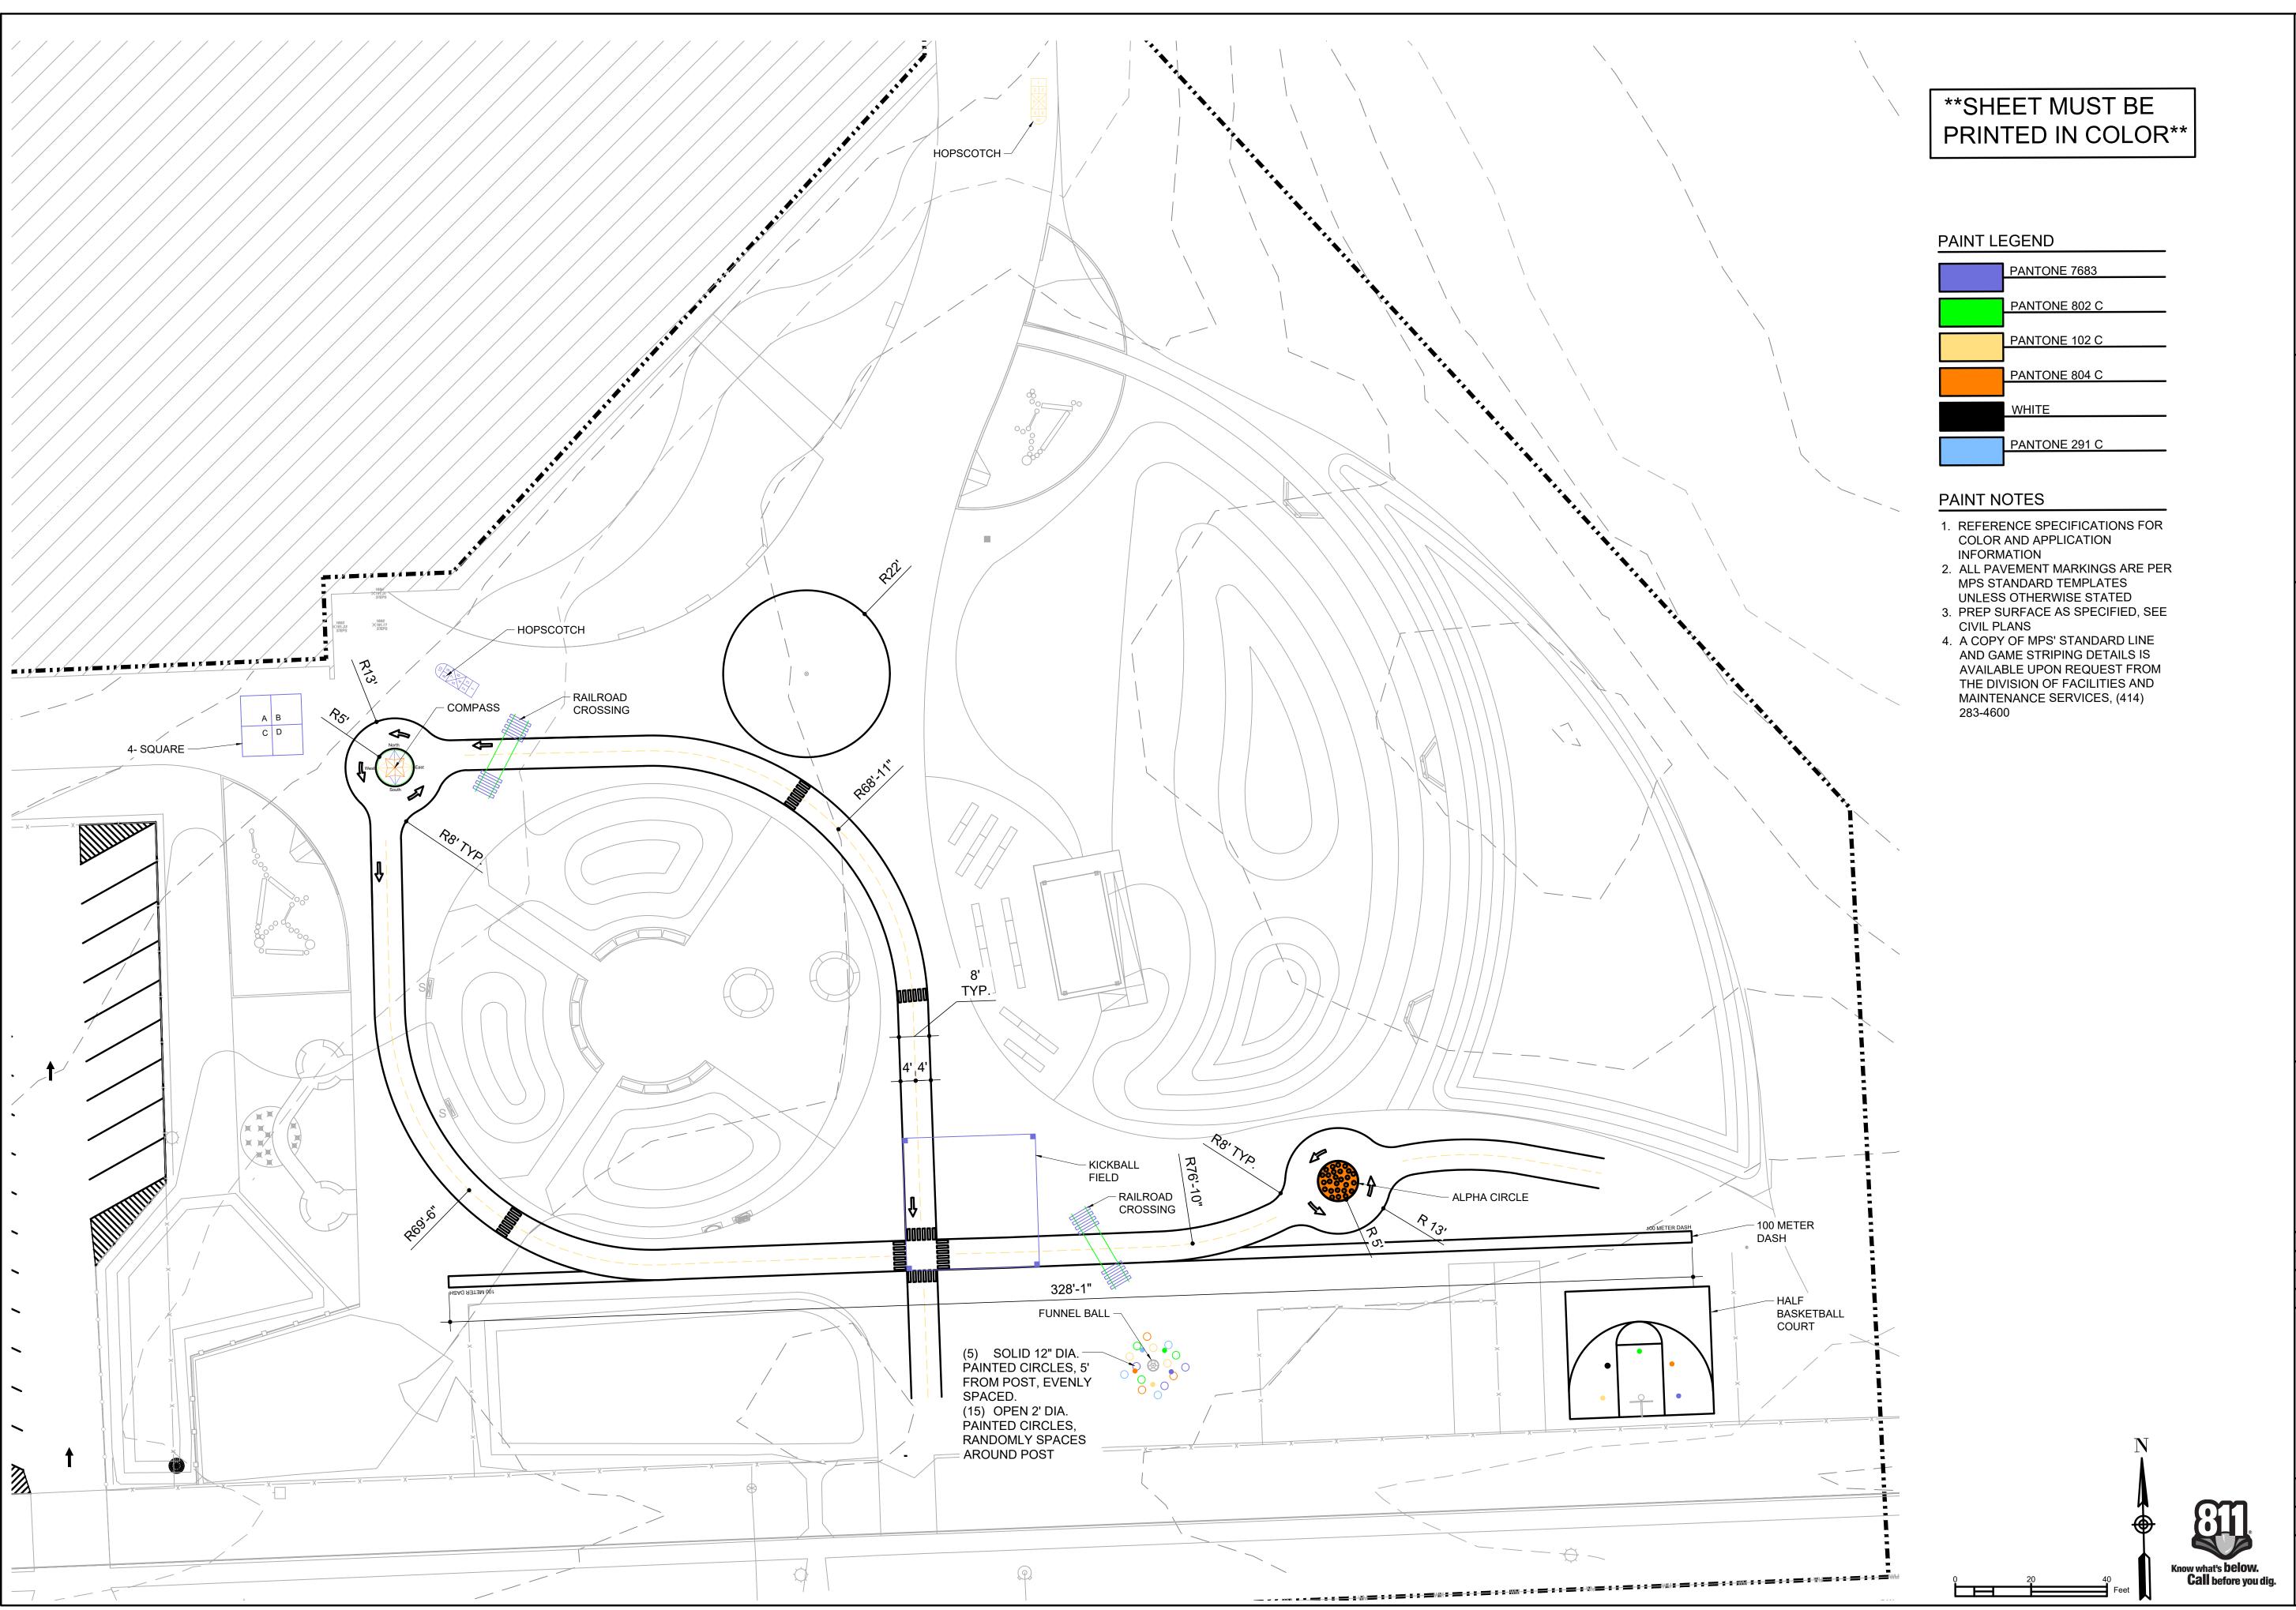
SHEET:

C503

C:\Users\KaraKoch\Stormwater Solutions Engineering\Stormwater Projects - Documents\2022\MPS C5\CADD files\D1 German Immersion\Exhibits\D1 MGIS 146 C500.dwg

DRIVEWAY APRON



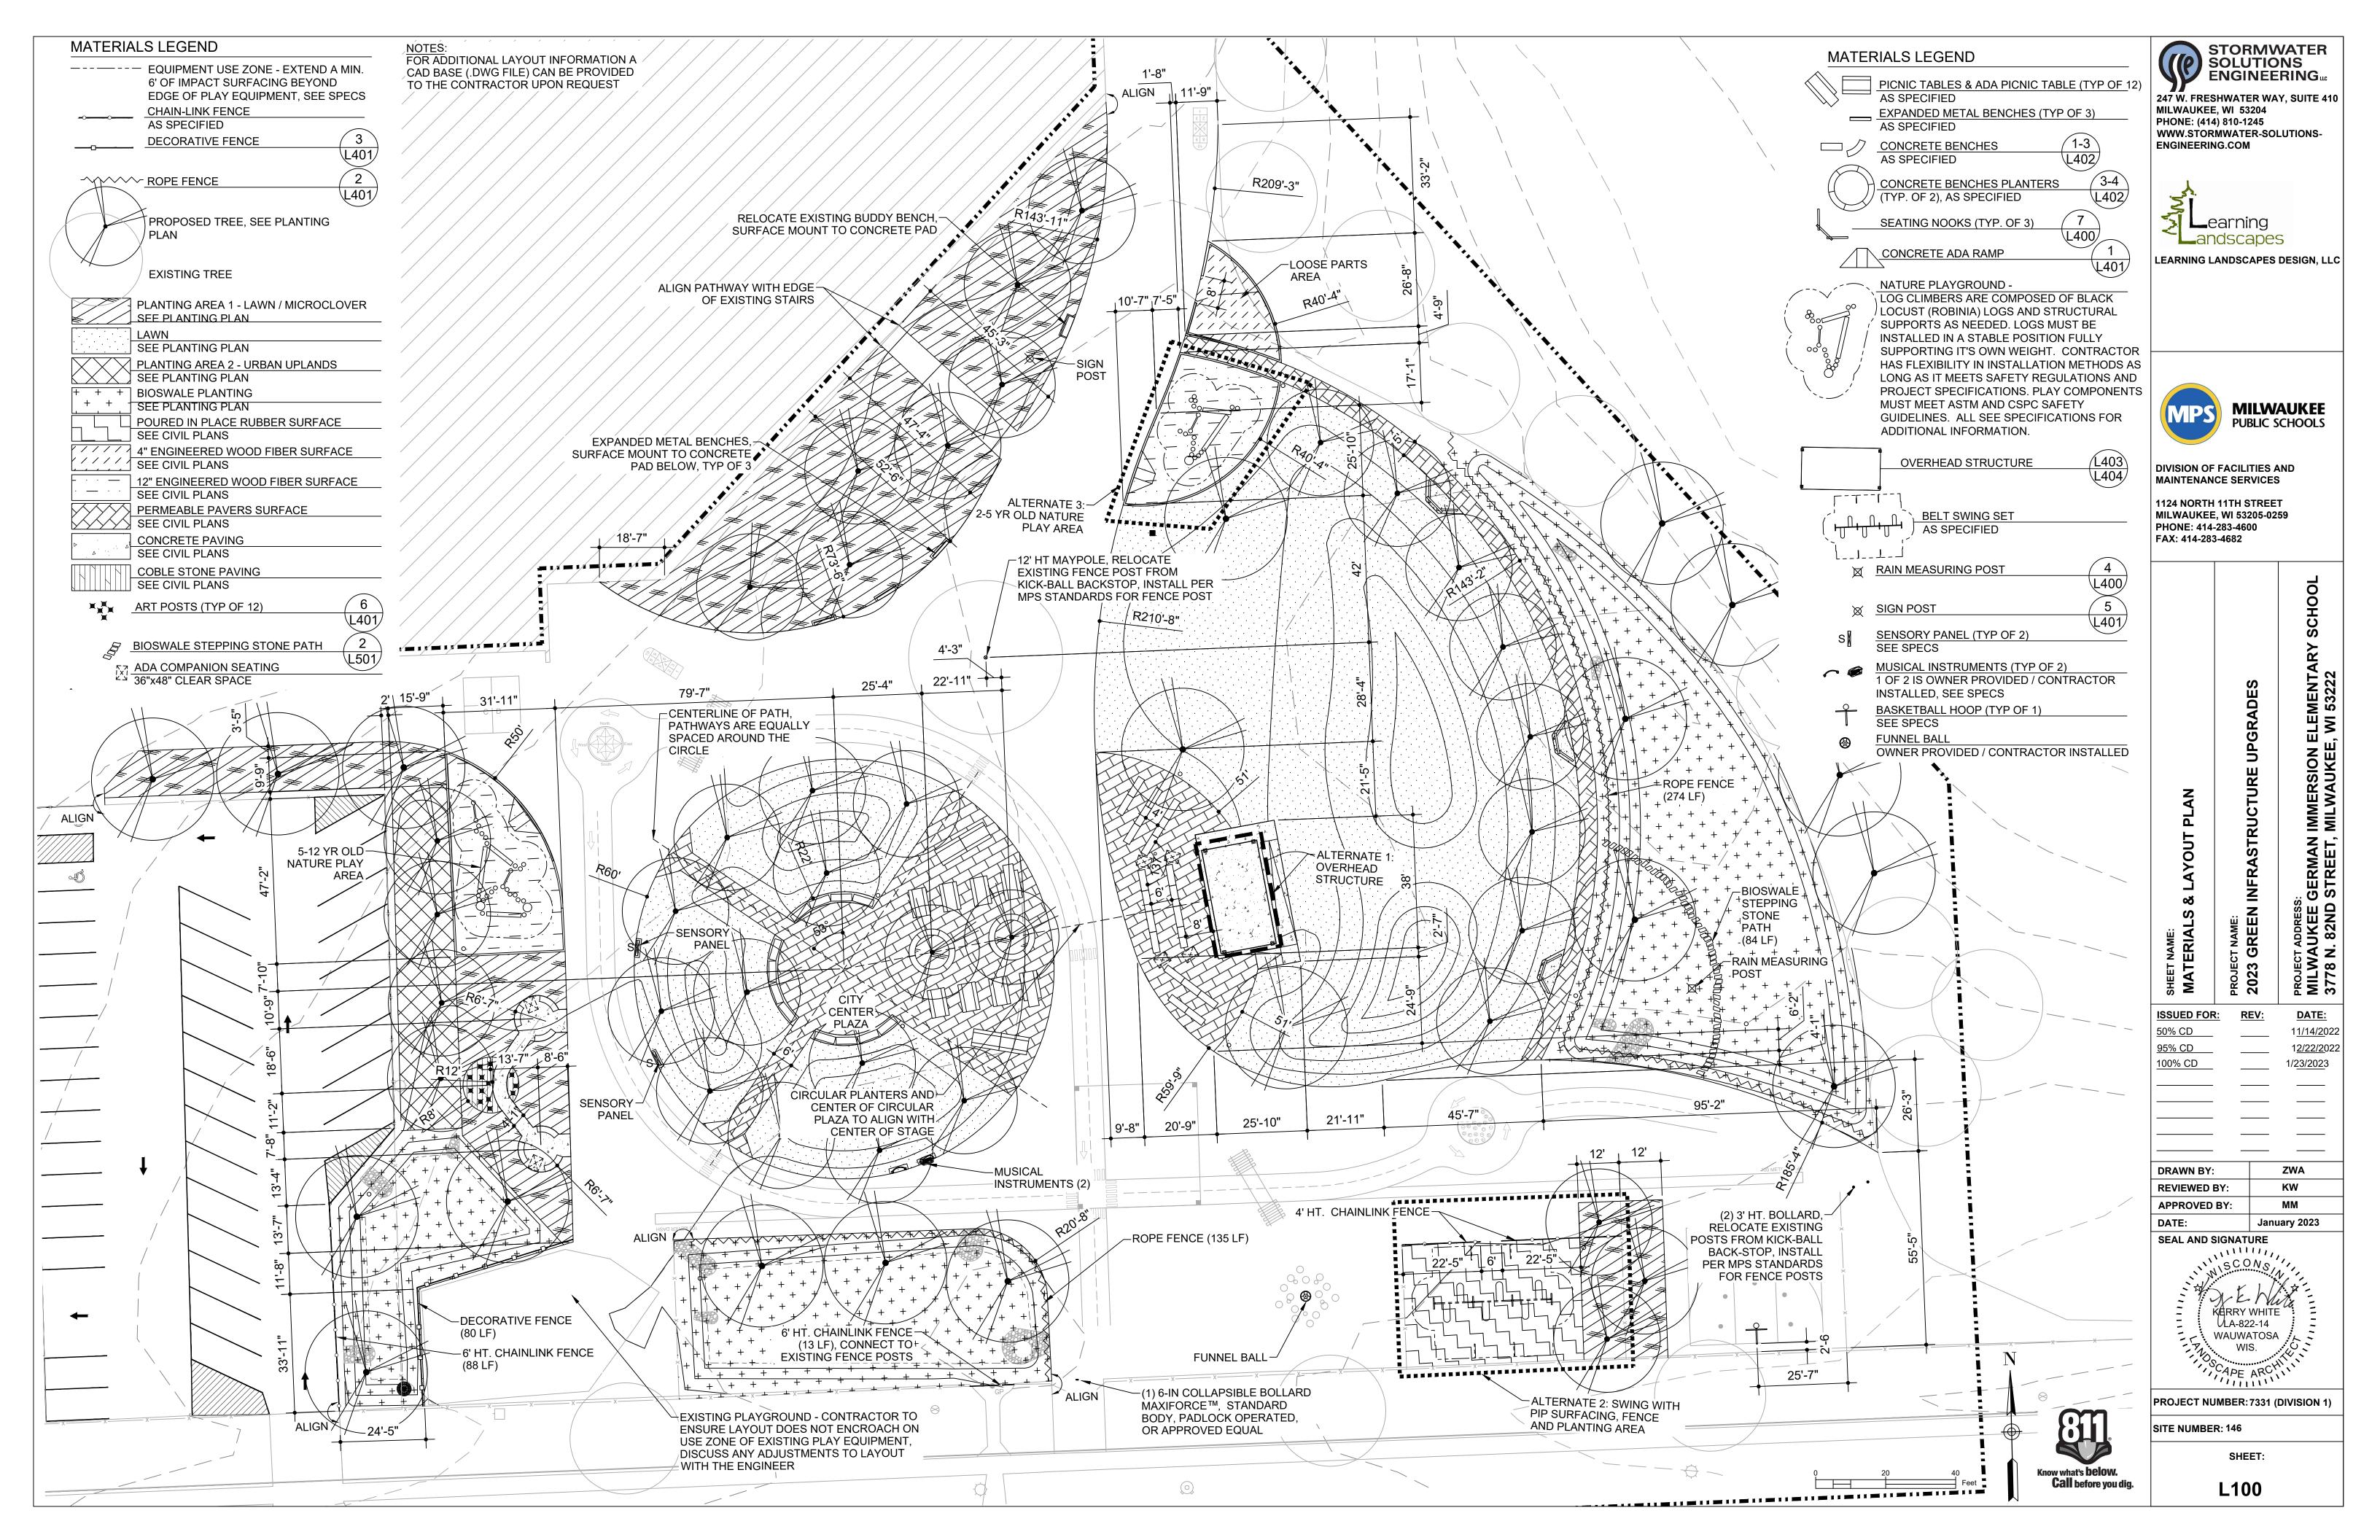

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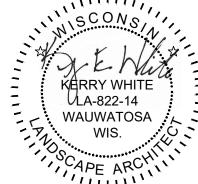
DIVISION OF FACILITIES AND MAINTENANCE SERVICES

1124 NORTH 11TH STREET MILWAUKEE, WI 53205-0259 PHONE: 414-283-4600 FAX: 414-283-4682

MARKINGS PLAN	N INFRASTRUCTURE UPGRADES	ESS: E GERMAN IMMERSION ELEMENTARY SCHOOL
MARKIN	N INFRA	ESS: E GERM

AWN BY:	ZWA
VIEWED BY:	KW
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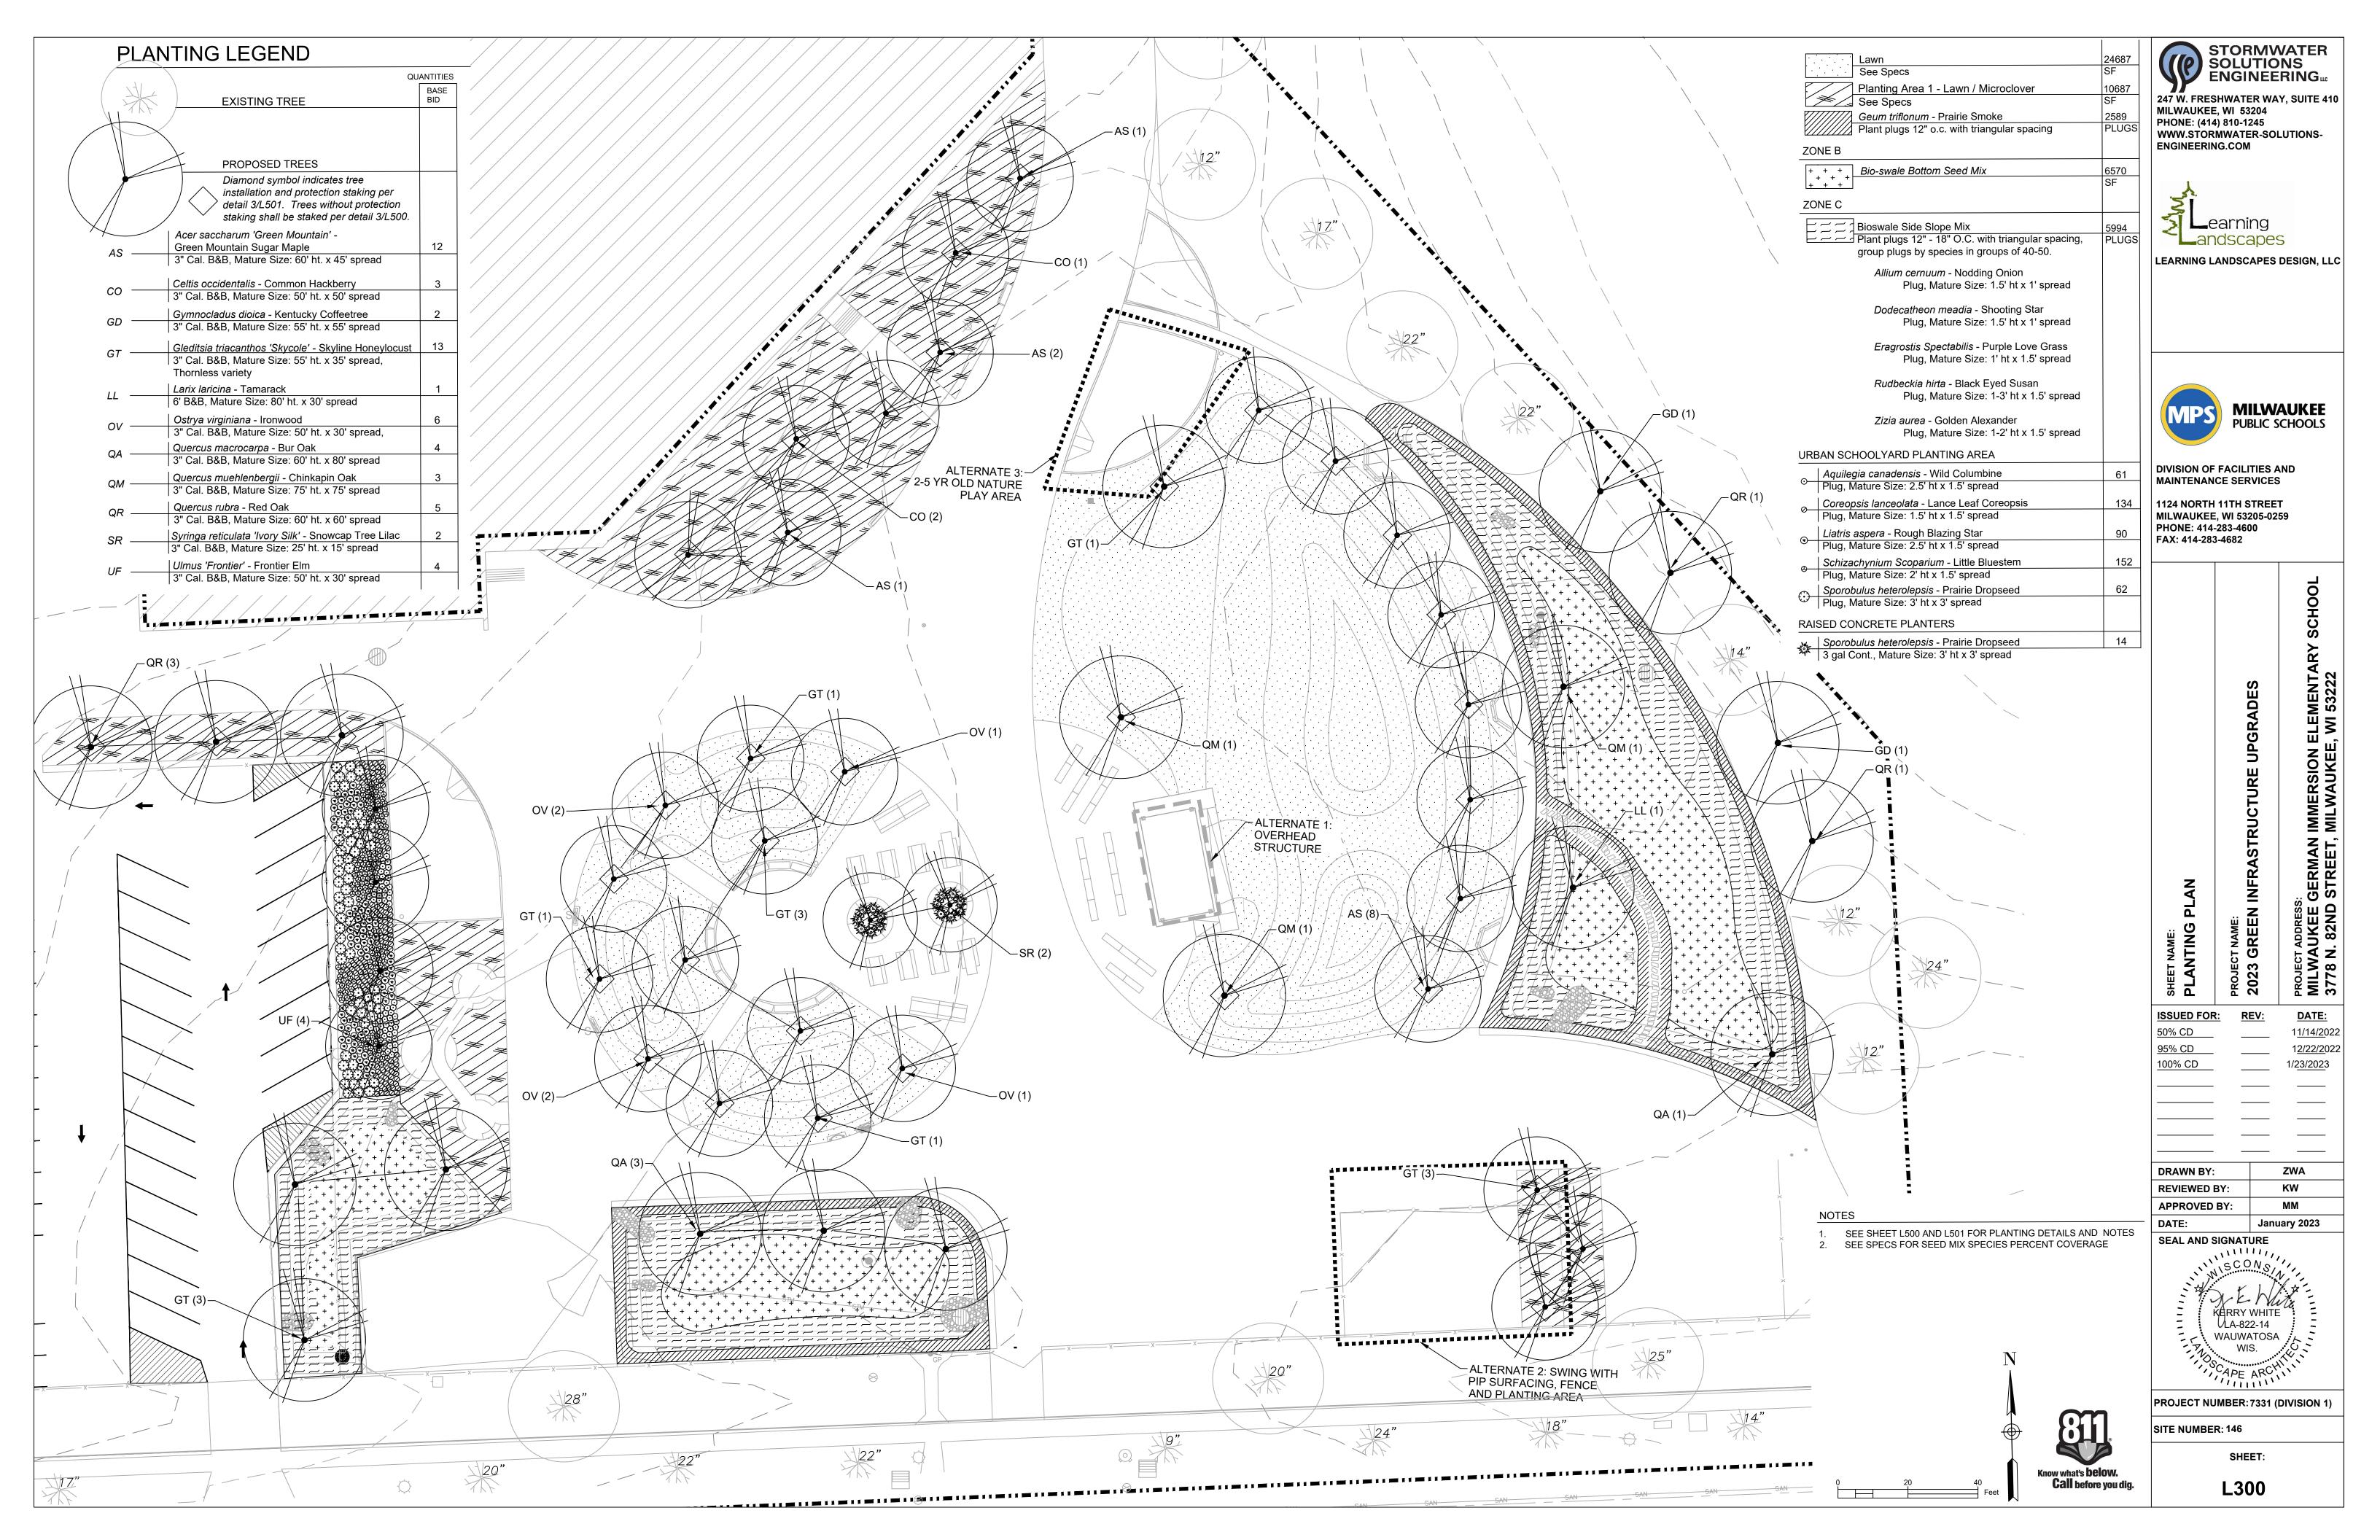
DRA REV APPROVED BY: January 2023 SEAL AND SIGNATURE




PROJECT NUMBER: 7331 (DIVISION 1)

SITE NUMBER: 146

SHEET: **L200**



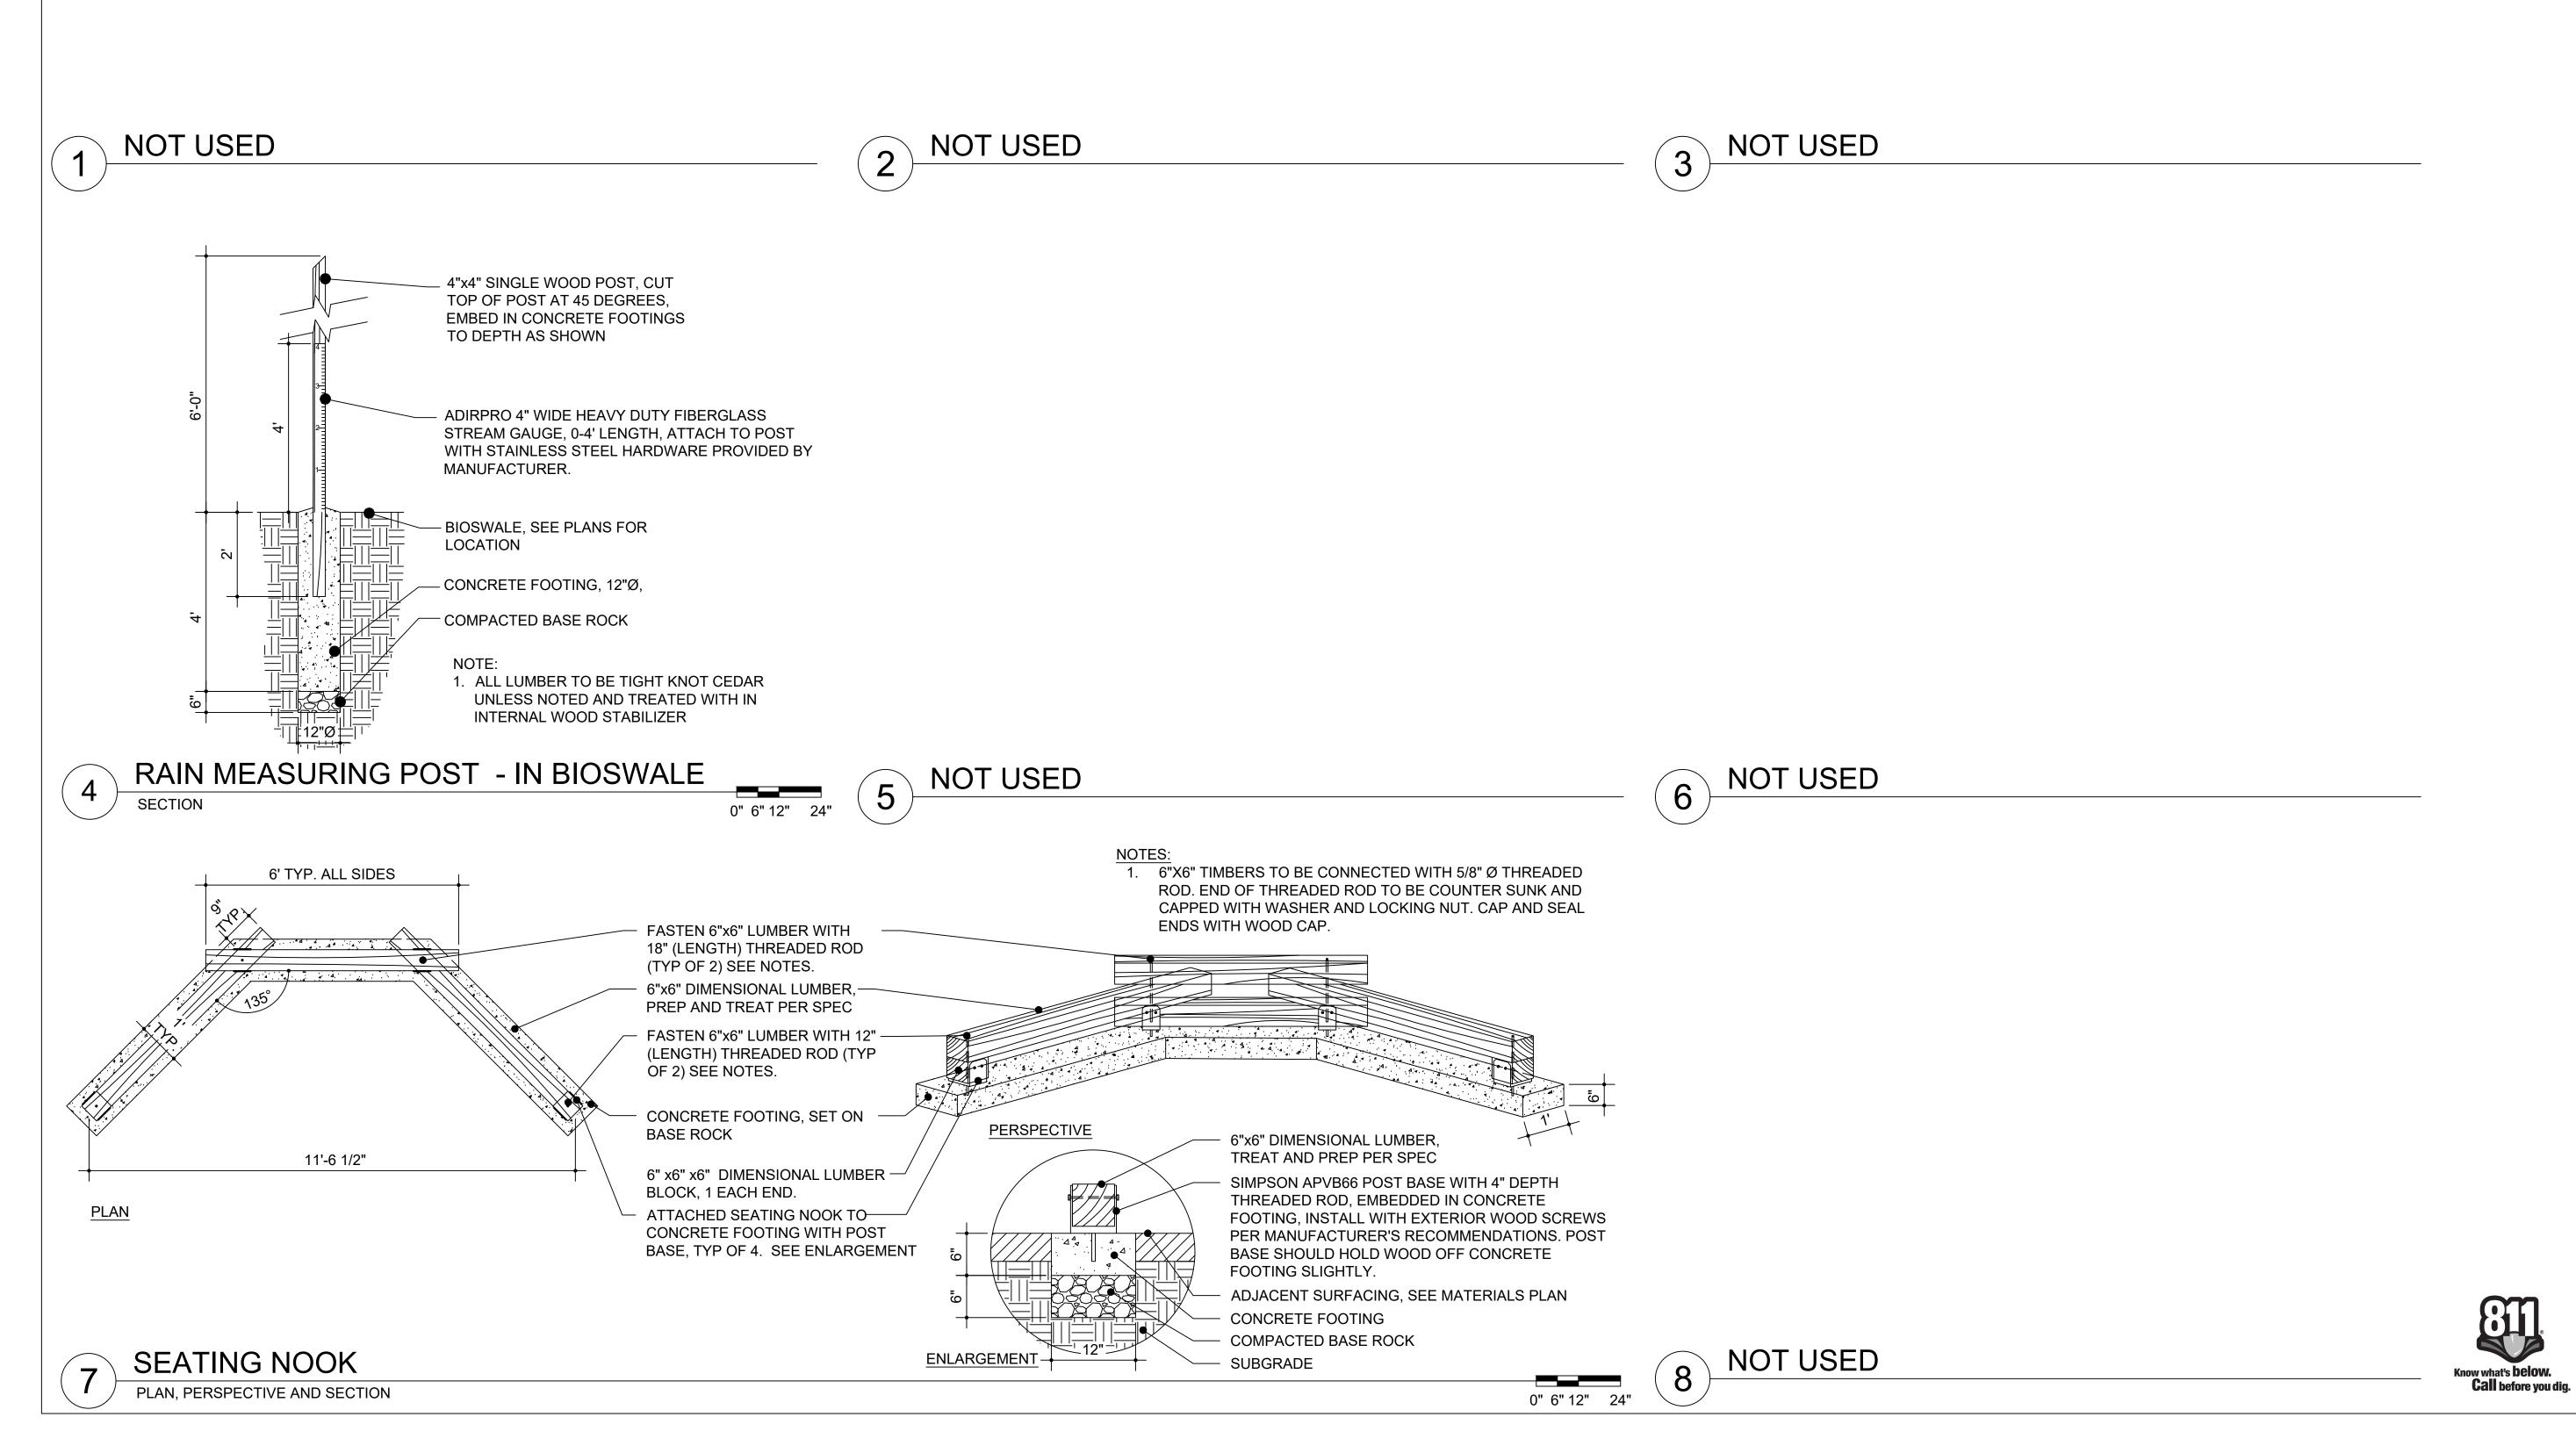

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SITE DETAILS PROJECT NAME: 2023 GREEN INFRASTRUCTURE UPGRADES PROJECT ADDRESS:	MILWAUKEE GERMAN IMMERSION ELEMENTARY SCHOOL	2770 N OOND STDEET MI WALKER WESSON
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SUED FOR	: <u>REV:</u>	DATE:
% CD		1 <u>1/14/2</u> 02
5% CD		1 <u>2/22/2</u> 02
0% CD		1/2 <u>3/202</u> 3

DRAWN BY:	ZWA
REVIEWED BY:	KW
APPROVED BY:	ММ
DATE:	January 2023

SEAL AND SIGNATURE





PROJECT NUMBER: 7331 (DIVISION 1)

SITE NUMBER: 146

SHEET:

L400

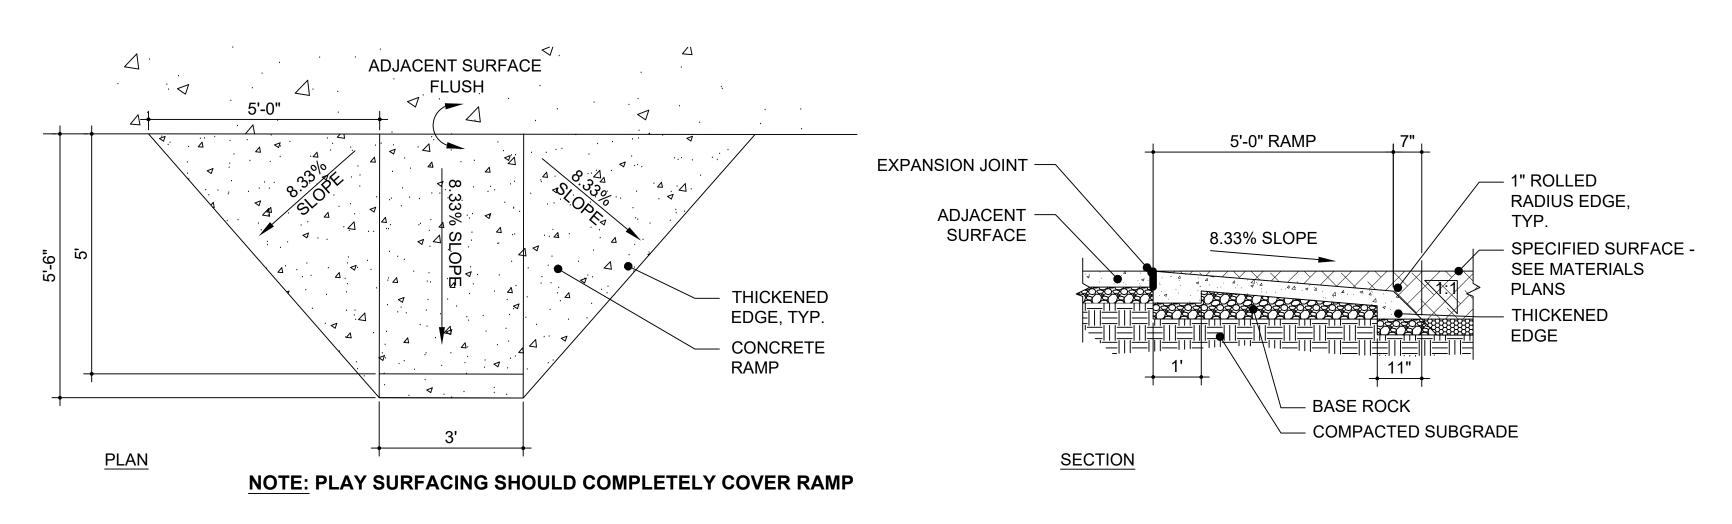

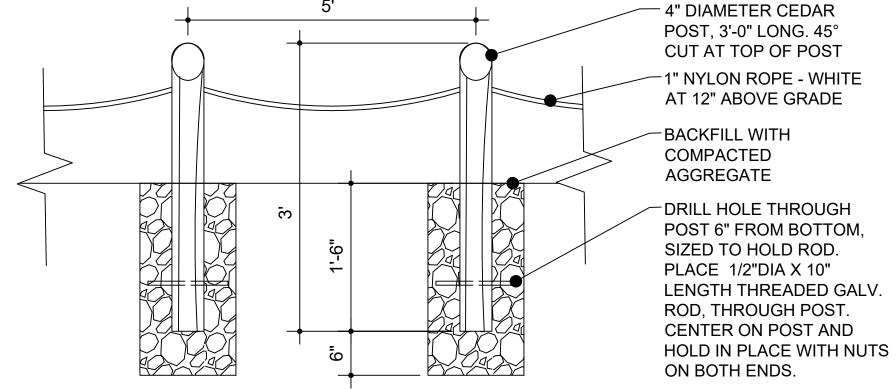

NOTES:

0" 6" 12" 24"

- 1. DRILL HOLE THROUGH POST TO ACCEPT ROPE, SAND ALL ROUGH EDGES SMOOTH.
- 2. ROPE INSTALLATION: AT EACH POST TIE KNOT IN ROPE, INSERT ROPE IN POST, LOOP THE ROPE AROUND ONE SIDE OF THE POST, INSERT THE ROPE THROUGH THE POST AGAIN, TIE ANOTHER KNOT, REPEAT AT EACH POST.
- 3. ROPE BETWEEN POSTS SHALL BE LOOSE ENOUGH THAT IF STEPPED ON IT NEARLY TOUCHES THE
- 4. POST TO BE SET 5' O.C. AND CLOSER AS NEEDED AT TIGHT TURNS.





PLAN AND SECTION

4" DIAMETER CEDAR POST, 6'-0" LONG FOR POST AND RAILING CARRIAGE BOLT, ENDS CUT FLUSH WITH BOLT AND SAND SMOOTH 3' GALVANIZED STEEL 5'-0" O.C. 3' GALVANIZED STEEL WELDED WELDED 2"x4" WIRE MESH. MESH, SANDWICH BETWEEN

SAND TOP AND BOTTOM OF MESH TO BE SMOOTH. ATTACH WIRE MESH TO TOP AND BOTTOM RAILS WITH 3/4" LENGTH GALVANIZED STAPLES, 1

PER MESH SQUARE

1/2" DIA. X 10" LENGTH GALVANIZED CARRIAGE BOLT WITH NUTS AND WASHERS

12" DIAMETER CONCRETE FOOTING, SLOPE TOP OF FOOTING **AWAY FROM POST**

COMPACTED AGGREGATE SUBGRADE

DECORATIVE FENCE

SIGN POST

3

MILWAUKEE I SIGNS TO BE OWNER PROVIDED, ← MENOMONEE RIVER ATTACH SIGNS TO POST WITH **EXTERIOR WOOD SCREWS**

•

4"x4" SINGLE WOOD POST, CUT TOP OF POST AT 45 DEGREES, EMBED IN CONCRETE FOOTINGS TO DEPTH AS SHOWN

CONCRETE FOOTING, 12"Ø,

1. ALL LUMBER TO BE TIGHT KNOT CEDAR UNLESS NOTED AND TREATED WITH IN INTERNAL WOOD STABILIZER

0" 6" 12" 24"

- COMPACTED BASE ROCK

POST AND RAILINGS

FENCE

PLANTING AREA BEHIND

CEDAR POST RAILINGS FACE

PAVED OR SOD SURFACING

ADJACENT SURFACING OR

MATERIALS PLANS

PLANTING AREA, REFERENCE

0" 6" 12" 24"

1. ALL LUMBER TO BE TIGHT KNOT CEDAR UNLESS NOTED AND TREATED WITH IN INTERNAL WOOD STABILIZER

4"x4" SINGLE WOOD POST, CUT

TOP OF POST AT 45 DEGREES, EMBED IN CONCRETE FOOTINGS

TO DEPTH AS SHOWN

ADJACENT SURFACE, SEE PLANS FOR LOCATION

- CONCRETE FOOTING, 12"Ø,

NOT USED

ART POST SECTION





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STORMWATER



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DIVISION OF FACILITIES AND MAINTENANCE SERVICES

1124 NORTH 11TH STREET **MILWAUKEE, WI 53205-0259** PHONE: 414-283-4600 FAX: 414-283-4682

SHEET NAME: SITE DETAILS	PROJECT NAME: 2023 GREEN INFRASTRUCTURE UPGRADES	PROJECT ADDRESS: MILWAUKEE GERMAN IMMERSION ELEMENTARY SCHC 3778 N. 82ND STREET, MILWAUKEE, WI 53222
ISSUED FOR	R: REV:	<u>DATE:</u> 1 <u>1/14/2</u> 022

100% CD	_	 1/2 <u>3/202</u> 3
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-	_	
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	_	
DRAWN BY:		ZWA
REVIEWED BY:		KW

1<u>2/22/2</u>022

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REVIEWED BY:	KW	
APPROVED BY:	ММ	
DATE: January 2023		
SEAL AND SIGNATURE		

ULA-822-14 WAUWATOSA


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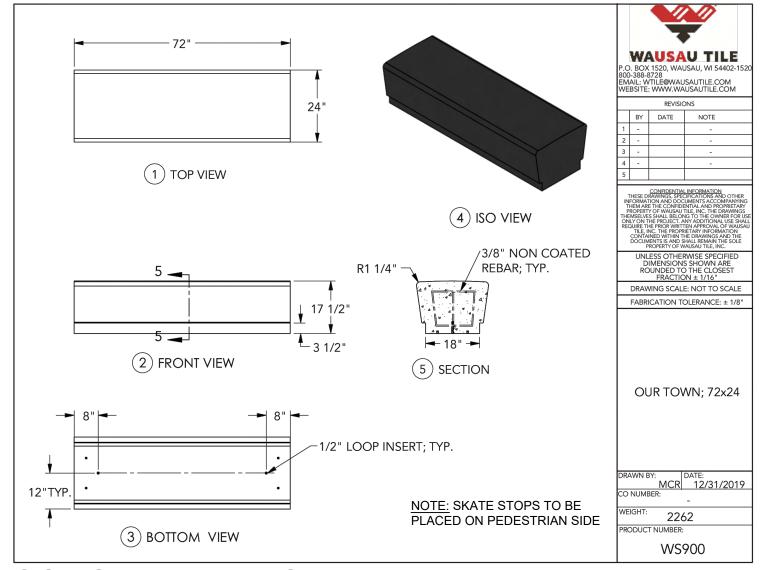
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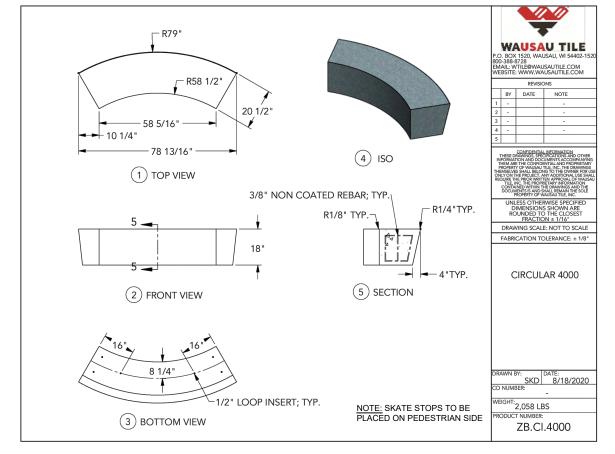
95% CD

L401

SHEET:





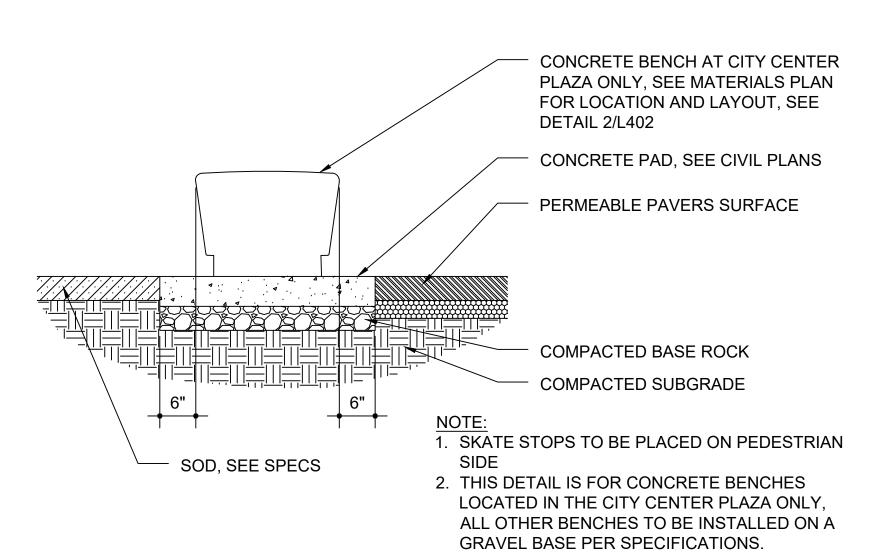




CONCRETE BENCH

CONCRETE BENCH / TREE PLANTER

0" 12" 24" 48"

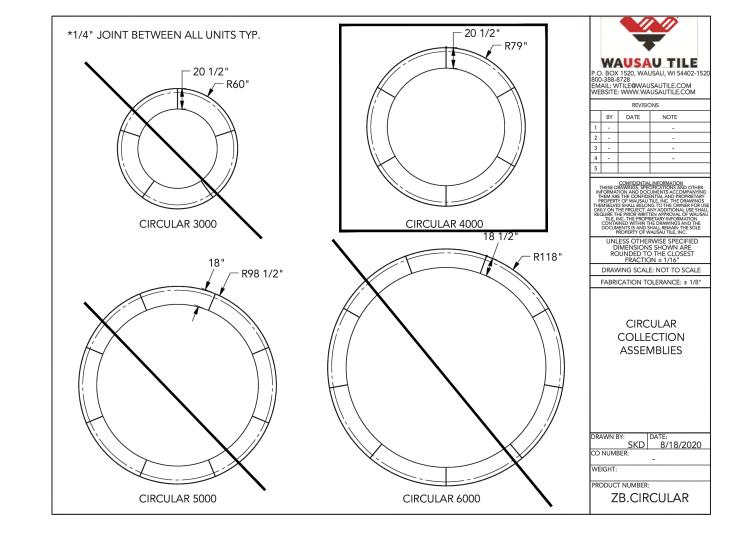





50% CD

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247 W. FRESHWATER WAY, SUITE 410

WWW.STORMWATER-SOLUTIONS-

Landscapes

DIVISION OF FACILITIES AND

MAINTENANCE SERVICES

1124 NORTH 11TH STREET

MILWAUKEE, WI 53205-0259 PHONE: 414-283-4600 FAX: 414-283-4682

LEARNING LANDSCAPES DESIGN, LLC

MILWAUKEE PUBLIC SCHOOLS

MILWAUKEE, WI 53204

PHONE: (414) 810-1245

ENGINEERING.COM

DRAWN BY: ZWA **REVIEWED BY:** KW APPROVED BY: January 2023

SEAL AND SIGNATURE

WAUWATOSA


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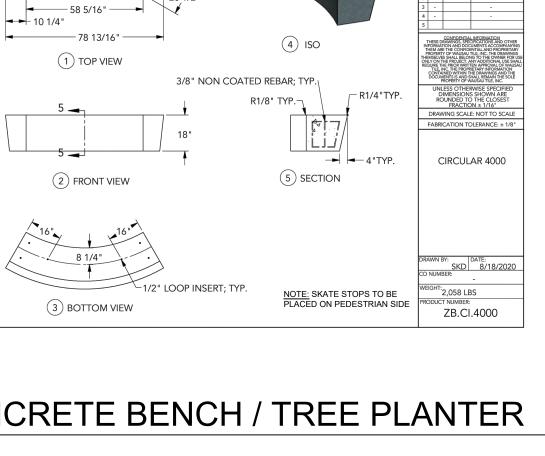
SITE NUMBER: 146

SHEET:

L402

Know what's **below. Call** before you dig.



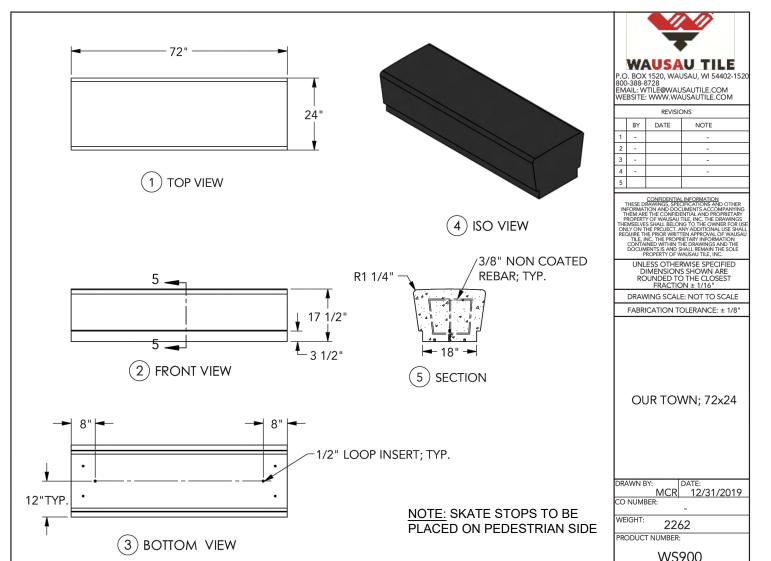



PROJECT NAME: OUTDOOR CLASSROM MPS

PROJECT LOCATION: MILWAUKEE, WI

BUILDING TYPE: MSE 16X30

ROOF TYPE: MULTI-RIB BUILDING NUMBER: P14115

ORDER NUMBER: 72044

DRAWING LIST:

ROOF LAYOUT

MANUFACTURER NOTES:

MATERIALS:

CHEDULE PIPE

RMT PIPE LIGHT GAGE COLD FORMED STRUCTURAL STEEL PLATE ROOF PANELS (STEEL)

7-7.1 ROOF CONNECTION DETAILS

SHEET NUMBER DRAWING DESCRIPTION COVER SHEET ARCHITECTURAL ELEVATIONS ANCHOR AND FOOTING LAYOUT / DETAILS STRUCTURAL FRAMING PLAN FRAME CONNECTION DETAILS

ASTM DESIGNATION A500 (GRADE B) A53 (GRADE B)

A1003 (GRADE 50)

A653 SEE SHEET 2.1

GENERAL NOTES:
UNLESS NOTED OTHERWISE, THIS STRUCTURE WAS DESIGNED TO ONLY SUPPORT WHAT IS SHOWN ON THESE DRAWINGS. POLIGON MUST BE CONTACTED IF ANYTHING ELSE IS TO BE ATTACHED TO THIS STRUCTURE (WALLS, COLUMN WRAPS, RAILINGS, ETC.) SO THE DESIGN OF THIS STRUCTURE CAN BE REVIEWED AND POSSIBLY REVISED.

UNLESS NOTED OTHERWISE, THIS STRUCTURE WAS DESIGNED ASSUMING A 20' SEPARATION BETWEEN ANY ADJACENT STRUCTURE WITH AN EAVE HEIGHT EQUAL TO OR GREATER THAN THE EAVE HEIGHT OF THIS STRUCTURE. IF THAT SEPARATION DOES NOT EXIST, POLIGON MUST BE CONTACTED SO THE DESIGN OF THIS STRUCTURE CAN BE REVIEWED AND POSSIBLY REVISED.

STRUCTURAL STEEL SHALL BE DETAILED, FABRICATED, AND ERECTED IN ACCORDANCE WITH THE LATEST EDITION OF THE AMERICAN INSTITUTE OF STEEL CONSTRUCTION (AISC) SPECIFICATION MANUAL.

ALL WELDING IS PERFORMED BY AMERICAN WELDING SOCIETY CERTIFIED WELDERS AND CONFORMS TO THE LATEST EDITION OF AWS D1.1 OR D1.3 AS REQUIRED.

PARTS SHOWN MAY BE UPGRADED DUE TO STANDARDIZED FABRICATION. REFER TO THE SHIPPING BILL OF MATERIALS AND FINAL INSTALLATION INSTRUCTIONS NCLUDED WITH THE STRUCTURE FOR POSSIBLE SUBSTITUTIONS AND IMPROVEMENTS.

FOR PROPER FIELD INSTALLATION OF THE BUILDING IT IS RECOMMENDED THAT THE PRIMARY FRAME INSTALLER AND THE ROOF INSTALLER HAVE A MINIMUM FIVE (5) YEARS DOCUMENTED EXPERIENCE INSTALLING THIS TYPE OF PRODUCT.

FOR PROPER FIELD INSTALLATION OF THE BUILDING IT IS RECOMMENDED THAT ELECTRIC WIRING, IF REQUIRED, BE RUN THROUGH THE STRUCTURAL MEMBERS BEFORE THE BUILDING IS ERECTED.

CERTIFICATES:
MIAMI-DADE COUNTY CERTIFICATE OF COMPETENCY NO. 21-0819.13
PCI (POWDER COATING INSTITUTE) 4000 CERTIFIED

FABRICATOR APPROVALS: CITY OF PHOENIX, AZ APPROVED FABRICATOR #C08-2010

CITY OF PHOENIX, AZ APPROVED FABRICATOR #C08-2010
CITY OF LOS ANGELES, CA APPROVED FABRICATOR #FB01596
CITY OF RIVERSIDE, CA APPROVED FABRICATOR #SF_000042
CITY OF HOUSTON, TX APPROVED FABRICATOR #470
CLARK COUNTY, NV APPROVED FABRICATOR #264
STATE OF UTAH APPROVED FABRICATOR 02008-14
AISC APPROVED FABRICATOR C-00018751

ROOF DEAD LOAD: 2 PSF FRAME DEAD LOAD: SELF WEIGHT LIVE LOAD: ELECTRICAL DETAILS ROOF LIVE LOAD: 20 PSF

SNOW DESIGN DATA:
GROUND SNOW LOAD (Pg): 30 PSF
FLAT ROOF SNOW LOAD (Pf): 25 PSF
SNOW EXPOSURE FACTOR (Ce): 1.0 SNOW LOAD IMPORTANCE FACTOR (Is): 1.0 THERMAL FACTOR (Ct): 1.2


2015 INTERNATIONAL BUILDING CODE RISK CATEGORY: II


DESIGN CRITERIA


WIND DESIGN DATA: BASIC WIND SPEED (V): 115 MPH GUST EFFECT FACTOR (G): 0.85 INTERNAL PRESSURE COEFFICIENT (GCpi): 0 WIND EXPOSURE: C


SEISMIC DESIGN DATA:
STEEL SYSTEMS NOT SPECIFICALLY DETAILED
FOR SEISMIC RESISTANCE
SEISMIC IMPORTANCE FACTOR (Ie): 1.0
SEISMIC DESIGN CATEGORY: C
SEISMIC SITE CLASS: D SEE CALCULATIONS FOR ADDITIONAL DATA

ADDITIONAL CRITERIA:

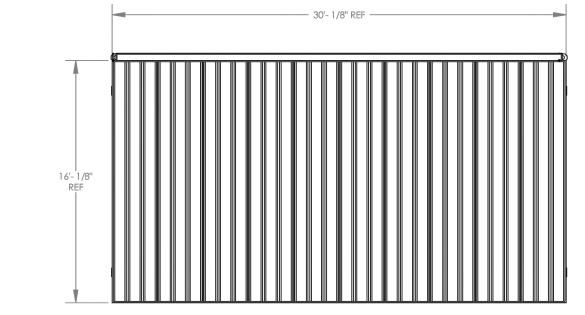

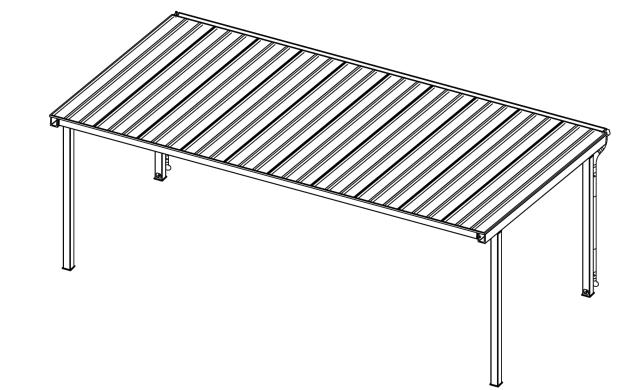

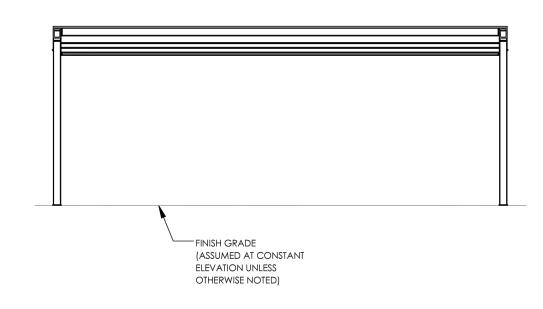

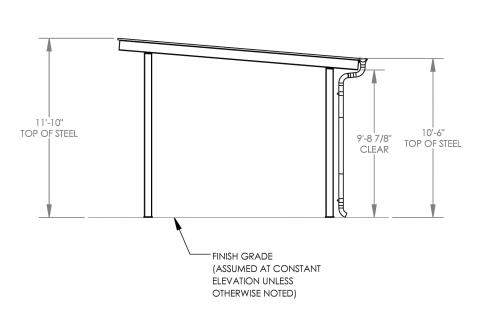

SHADE SHELTER - COVER SHEET

NOT TO SCALE

SHADE SHELTER - ARCHITECTURAL ELEVATIONS

NOT TO SCALE

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DIVISION OF FACILITIES AND MAINTENANCE SERVICES

1124 NORTH 11TH STREET

MILWAUKEE, WI 53205-0259

ST NAME: GREEN

REV:

DATE:

11/14/2022

12/22/2022

1/23/2023

ZWA

KW

MM

January 2023

2 □

ISSUED FOR:

50% CD

95% CD

100% CD

DRAWN BY:

DATE:

REVIEWED BY:

APPROVED BY:

SEAL AND SIGNATURE

,\sCONs/

KARRY WHITE VLA-822-14

WAUWATOSA WIS.

PROJECT NUMBER: 7331 (DIVISION 1

SHEET:

L403

SITE NUMBER: 146

PHONE: 414-283-4600 FAX: 414-283-4682

LEARNING LANDSCAPES DESIGN, LLC


MILWAUKEE


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MILWAUKEE, WI 53204

PHONE: (414) 810-1245

ENGINEERING.COM



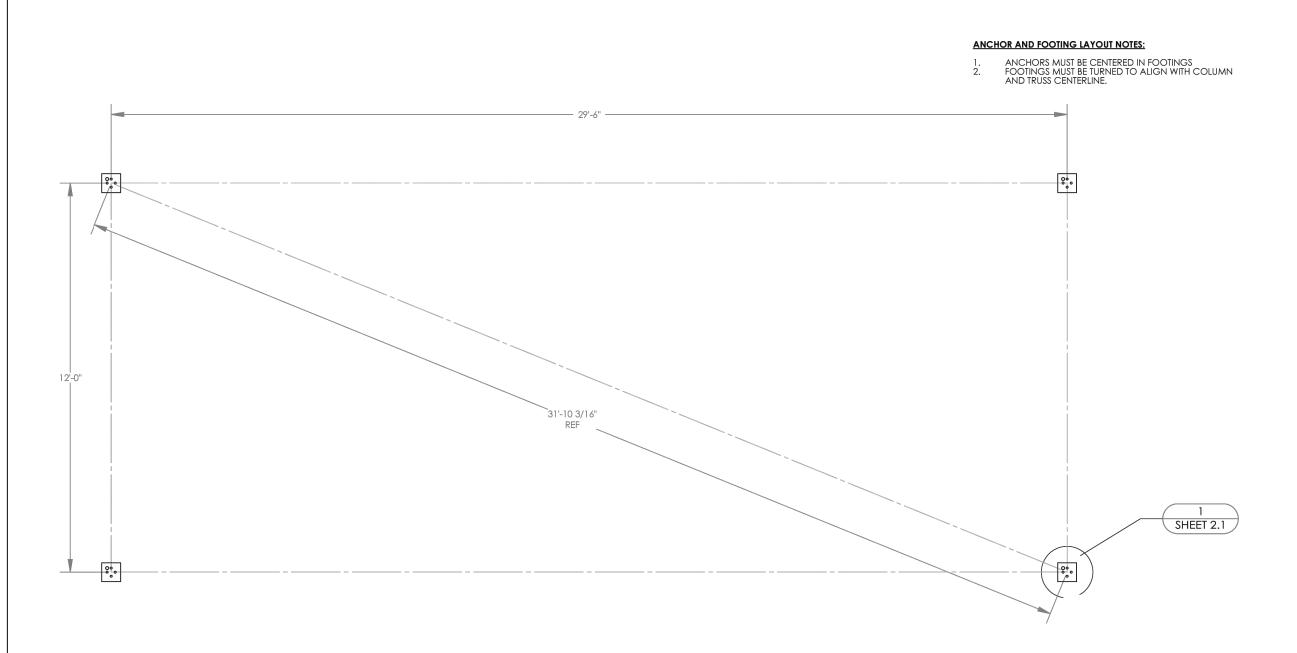


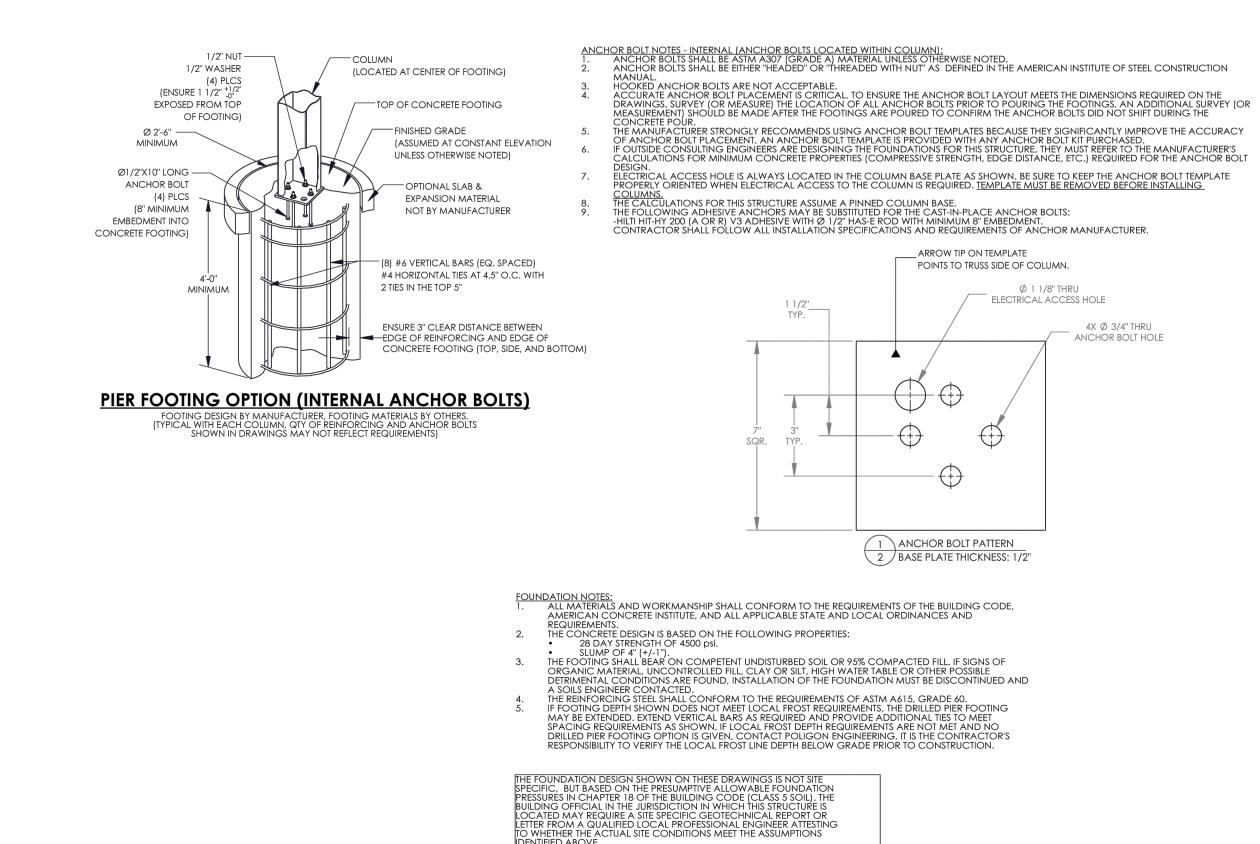Know what's **below**. Call before you dig.

SHADE SHELTER - ANCHOR AND FOOTING LAYOUT

SHADE SHELTER - ANCHOR AND FOOTING DETAILS

NOT TO SCALE

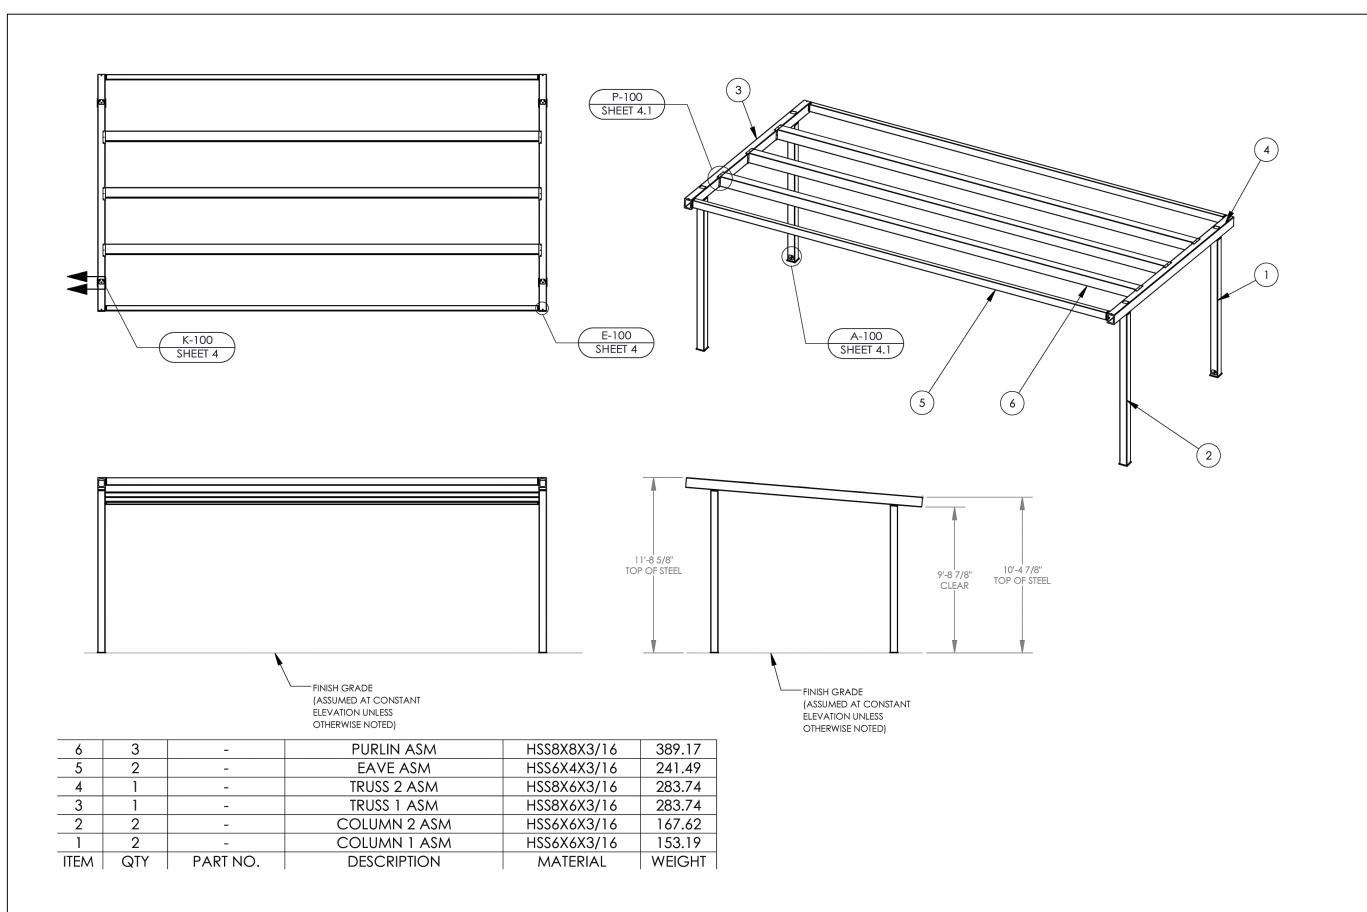

SHADE SHELTER - STRUCTURAL FRAMING PLAN

NOT TO SCALE





LEARNING LANDSCAPES DESIGN, LLC



DIVISION OF FACILITIES AND MAINTENANCE SERVICES

1124 NORTH 11TH STREET MILWAUKEE, WI 53205-0259 PHONE: 414-283-4600 FAX: 414-283-4682

SHEET NAME: SITE DETAILS	PROJECT NAME: 2023 GREEN INFRASTRUCTURE UPGRADES	PROJECT ADDRESS: MILWAUKEE GERMAN IMMERSION ELEMENTAF
ISSUED FOR:	REV:	DATE:

DRAWN BY:	ZWA
100% CD	 1/2 <u>3/202</u> 3
95% CD	 1 <u>2/22/2</u> 02

1<u>1/14/2</u>022

Г		
	DATE:	January 2023
	APPROVED BY:	ММ
	REVIEWED BY:	KW
	DRAWN BY:	ZWA

SEAL AND SIGNATURE

50% CD




PROJECT NUMBER: 7331 (DIVISION 1)


SITE NUMBER: 146

Know what's **below. Call** before you dig.

SHEET:

L404

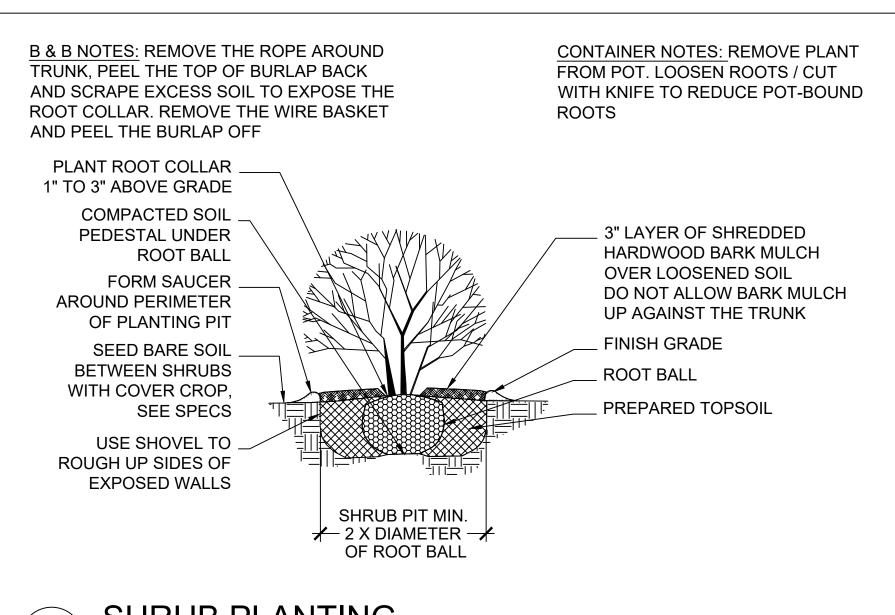

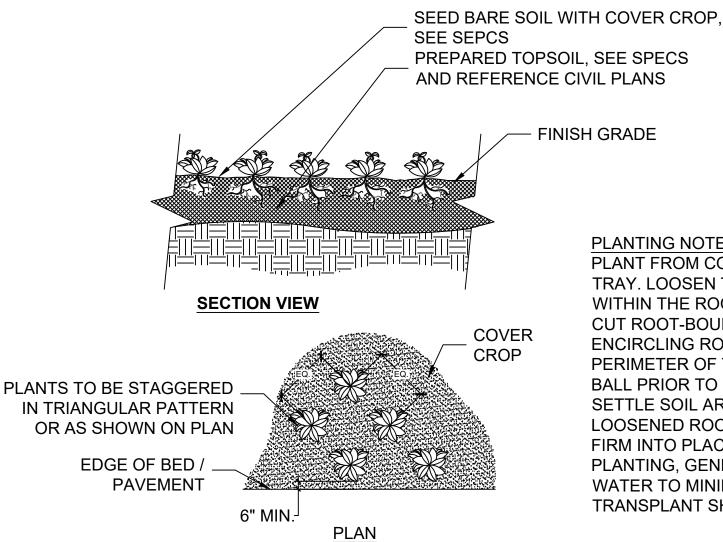


PLUG PLANTING

SECTION

PLANTING NOTES: REMOVE PLANT FROM CONTAINER OR TRAY. LOOSEN THE ROOTS WITHIN THE ROOT BALL AND CUT ROOT-BOUND ENCIRCLING ROOTS ON THE PERIMETER OF THE ROOT BALL PRIOR TO PLANTING. SETTLE SOIL AROUND THE LOOSENED ROOT BALL AND FIRM INTO PLACE. UPON PLANTING. GENEROUSLY WATER TO MINIMIZE TRANSPLANT SHOCK

0" 6" 12" 24"

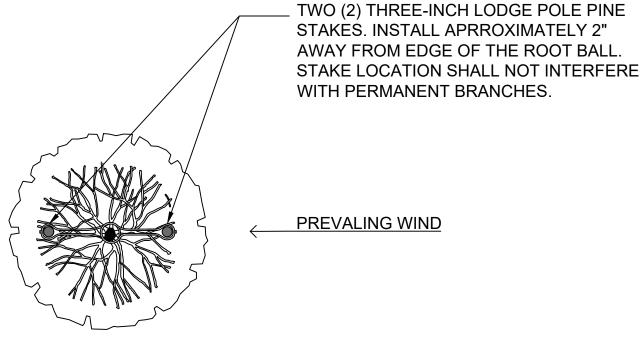


REFERENCE DETAIL 3/L501 FOR TREES LOCATED IN TO BE USED IN PLACE OF THIS DETAIL.



OPEN LAWN AREAS AND AS INDICATED ON THE PLANS FOR TREE INSTALLATION AND PROTECTION STAKING

0" 6" 12" 24"

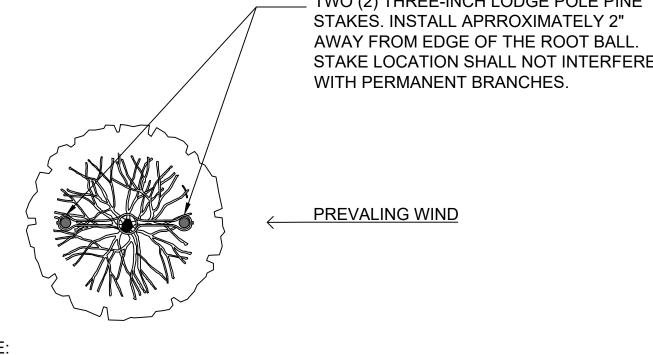

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DIVISION OF FACILITIES AND MAINTENANCE SERVICES

1124 NORTH 11TH STREET **MILWAUKEE, WI 53205-0259** PHONE: 414-283-4600 FAX: 414-283-4682

SHEET NAME: PLANTING DETAILS	PROJECT NAME:	2023 GREEN INFRASTRUCTURE UPGRADES	PROJECT ADDRESS: MILWAUKEE GERMAN IMMERSION ELEMENTARY SCHOOL 3778 N. 82ND STREET, MILWAUKEE, WI 53222
ISSUED FOR	<u>:</u> R	EV:	DATE:
50% CD	_		1 <u>1/14/2</u> 022
95% CD	_		1 <u>2/22/2</u> 022
100% CD			1/2 <u>3/202</u> 3
	_		
	_		
DRAWN BY:			ZWA
REVIEWED E	3Y:		KW
APPROVED	BY:		MM

APPROVED BY: DATE: January 2023

SEAL AND SIGNATURE William. NSCONS// KARRY WHITE ULA-822-14


CAPE ARCY PROJECT NUMBER: 7331 (DIVISION 1)


WAUWATOSA WIS.


SITE NUMBER: 146

SHEET: L500

Know what's **below**. Call before you dig.

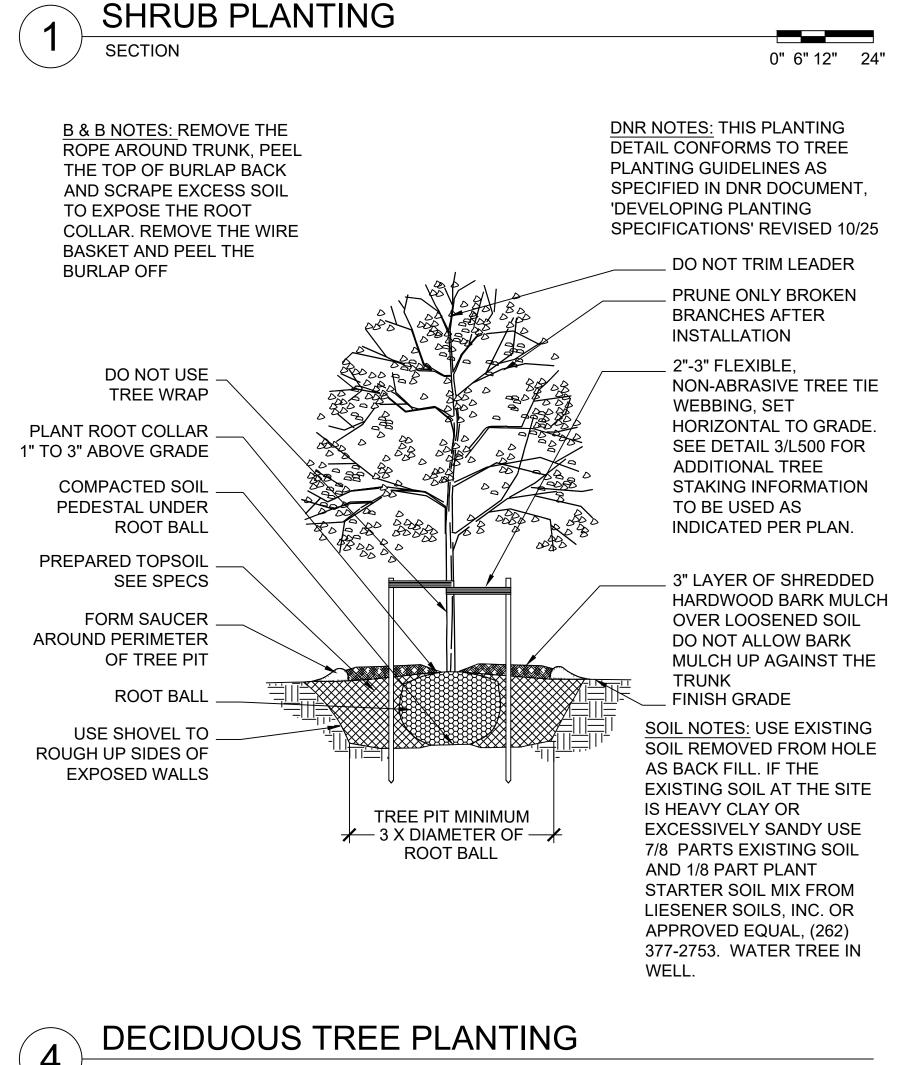

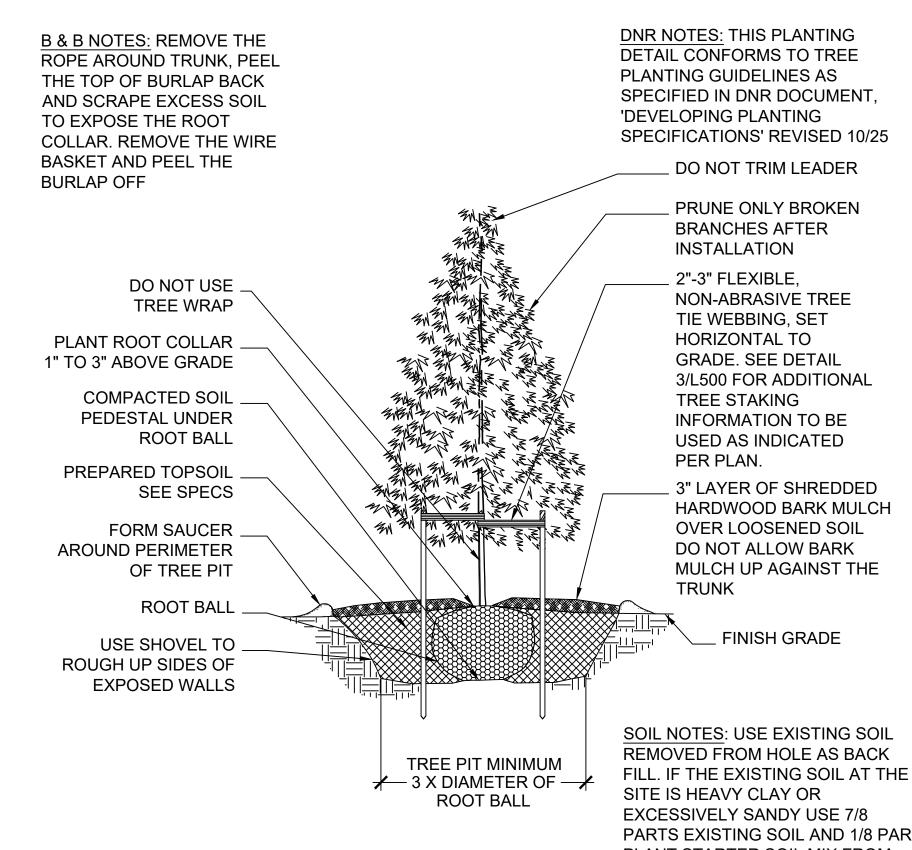

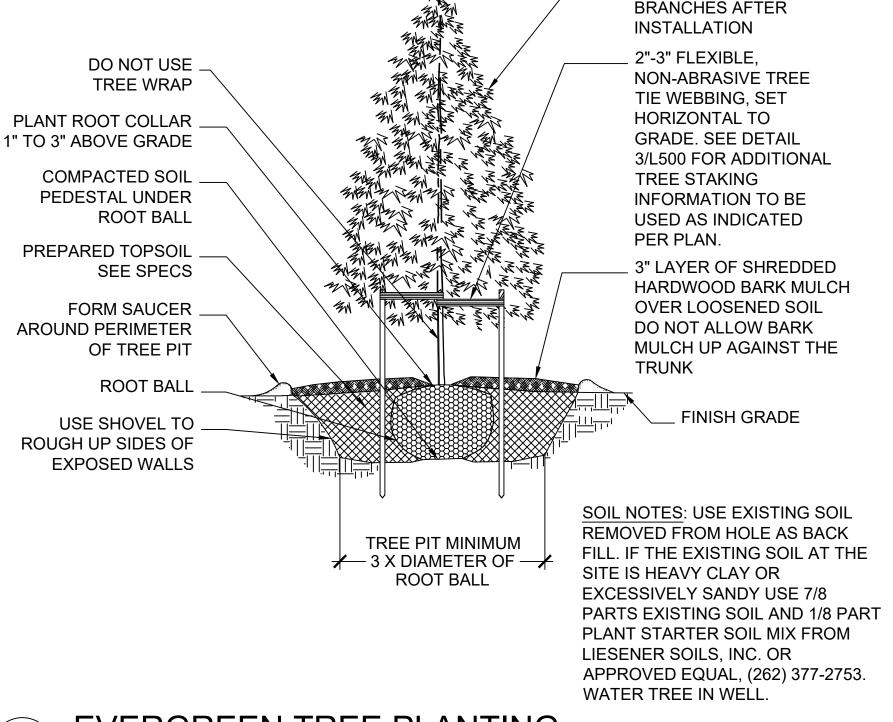


NTS

5

EVERGREEN TREE PLANTING

SECTION

NTS

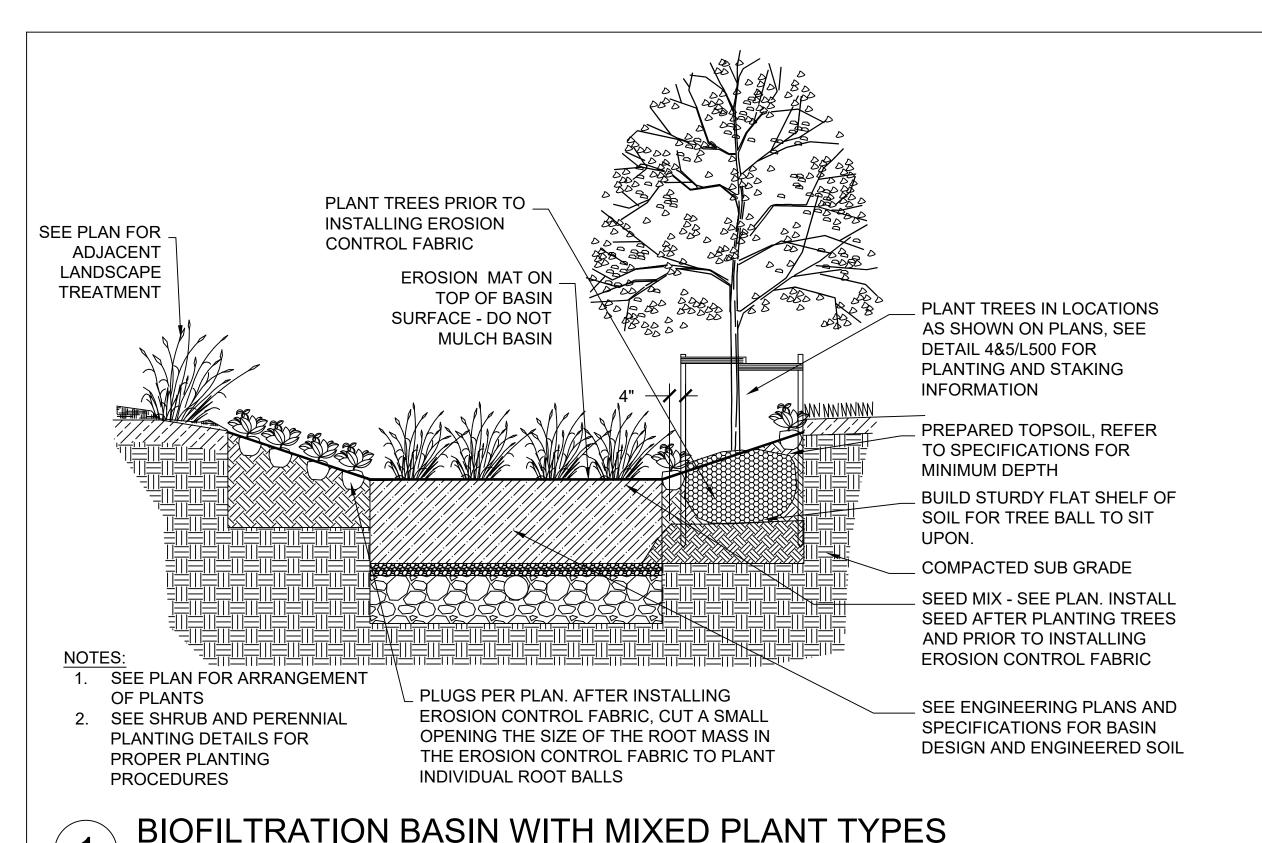

8"-12" THICK LIMESTONE STEPPER. LENGTH AND WIDTH OF BOULDERS
VARIES: 12" x12" MIN, 24"x24" MAX. BURY 1/3 OF BOULDER MINIMUM

COMPACTED AGGREGATE, BELOW STONE
STEPPER PATH ONLY

BIOSWALE SEED MIX
BETWEEN STEPPERS

BETWEEN STEPPERS

LENGTH VARIES - SEE PLAN

SEE ENGINEERING PLANS AND
SPECIFICATIONS FOR BASIN DESIGN

1. HEIGHT DIFFERENCE TO BE 6" MAXIMUM.


0" 6" 12" 24"

- 2. BOULDERS MUST REST IN A STABLE POSITION FULLY SUPPORTING ITS OWN WEIGHT. SUBGRADE AND SURROUNDING SOIL MUST BE STABLE AND CAPABLE OF SUPPORTING BOULDERS WITHOUT SETTLING
- 3. BOULDER EDGES SHALL BE SMOOTH AND ROUNDED. ALL SHARP POINTS AND EDGES SHALL BE REMOVED.



PLANTING NOTES

- CONTRACTOR SHALL INSPECT THE SITE AND BECOME FAMILIAR WITH EXISTING CONDITIONS RELATED TO THE NATURE AND SCOPE OF WORK.
- 2. CONTRACTOR SHALL VERIFY LOCATION OF UNDERGROUND AND ABOVE GROUND UTILITIES AND PROVIDE THE NECESSARY PROTECTION BEFORE CONSTRUCTION BEGINS.
- 3. CONTRACTOR SHALL VERIFY PLAN LAYOUT AND DIMENSIONS SHOWN AND BRING TO THE ATTENTION OF THE PRIME CONSULTANT DISCREPANCIES WHICH MAY COMPROMISE THE DESIGN AND/OR INTENT OF THE PROJECT'S LAYOUT.
- 4. CONTRACTOR SHALL ASSURE COMPLIANCE WITH APPLICABLE CODES AND REGULATIONS GOVERNING THE WORK AND/OR MATERIALS SUPPLIED.
- 5. CONTRACTOR SHALL PROTECT EXISTING ROADS, CURBS/GUTTERS, TRAILS, SIDEWALKS, TREES, LAWNS AND OTHER SITE ELEMENTS DURING CONSTRUCTION OPERATIONS. DAMAGE TO SAME SHALL BE REPAIRED AT NO ADDITIONAL COST TO THE OWNER.
- 6. CONTRACTOR TO MAINTAIN EXISTING GRADE WITHIN THE TREE CANOPY LINE (MINIMUM) OF TREES TO BE PRESERVED AND PROTECTED UNLESS OTHERWISE INDICATED ON THE PLANS. REFERENCE SPECIFICATIONS FOR ADDITIONAL TREE PROTECTION INFORMATION.
- 7. NO PRUNING SHALL BE PERFORMED ON TREES TO BE PRESERVED EXCEPT BY APPROVED ARBORIST.
- 8. NO EQUIPMENT SHALL OPERATE INSIDE THE DRIP LINE (AT MINIMUM) OF TREES TO BE PRESERVED.
- 9. HAND WORK ONLY AND NO MACHINERY OR MATERIAL STORAGE WITHIN DRIP LINE OF TREES TO BE PRESERVED.
- 10. EXISTING TREES TO REMAIN SHALL BE FERTILIZED AND PRUNED TO REMOVE DEAD WOOD, DAMAGED, AND/OR RUBBING BRANCHES.
- 11. CONTRACTOR SHALL COORDINATE THE PHASES OF CONSTRUCTION AND PLANTING INSTALLATION WITH OTHER CONTRACTORS WORKING ON THE SITE.
- 12. CONTRACTOR TO COMPLETE SOIL PREPARATION PER SPECIFICATIONS.
- 13. CONTRACTOR TO SUPPLY AND INSTALL SOD, TREES, SHRUBS, PERENNIALS, GRASSES, PLUGS, AND GROUNDCOVERS.
- 14. PROPOSED PLANT MATERIAL SHALL COMPLY WITH THE LATEST EDITION OF THE AMERICAN STANDARD FOR NURSERY STOCK, ANSI Z60.1 UNLESS NOTED OTHERWISE. DECIDUOUS SHRUBS SHALL HAVE AT LEAST 5 CANES AT THE SPECIFIED HEIGHT. ORNAMENTAL TREES SHALL HAVE NO "V" CROTCHES AND SHALL BEGIN BRANCHING NO LOWER THAN 3 FEET ABOVE ROOT BALL. SHADE TREES SHALL BEGIN BRANCHING NO LOWER THAN 6' ABOVE FINISHED GRADE.
- 15. ALL PLANTS AND TREES SHALL BE PLANTED PER DETAILS AND SPECS.
- 16. ALL TREES, AS IDENTIFIED ON THE PLANS, SHALL BE STAKED AS SHOWN ON THE PLANTING DETAILS UNLESS NOTED OTHERWISE ON THE PLANS.
- 17. NO PLANTS SHALL BE INSTALLED UNTIL FINAL GRADES AND CONSTRUCTION HAS BEEN COMPLETED IN THE IMMEDIATE AREA.
- 18. WHEN QUANTITIES ARE LISTED THEY ARE FOR THE CONTRACTOR'S CONVENIENCE ONLY. ALL COUNTS MUST BE VERIFIED BY THE CONTRACTOR. IN THE CASE OF A DISCREPANCY BETWEEN THE LEGEND AND THE PLAN, PLANTS INDICATED ON THE PLAN SHALL SUPERCEDE QUANTITIES LISTED IN THE LEGEND. SPECIFICATIONS AND DETAILS TAKE PRECEDENCE OVER NOTES.
- 19. NO PLANT MATERIAL SUBSTITUTIONS WILL BE ACCEPTED UNLESS APPROVAL IS REQUESTED OF THE LANDSCAPE ARCHITECT BY THE LANDSCAPE CONTRACTOR PRIOR TO THE SUBMISSION OF BID AND/OR QUOTATION.
- 20. ADJUSTMENTS IN LOCATION OF PROPOSED PLANT MATERIAL MAY BE NEEDED IN FIELD. PRIME CONSULTANT MUST BE NOTIFIED PRIOR TO THE ADJUSTMENT OF PLANTS.
- 21. CONTRACTOR SHALL VERIFY PLANT QUANTITIES SHOWN ON THE PLAN AND PROVIDE A LIST TO THE CLIENT IDENTIFYING THE SPECIES AND SIZES TO BE USED THROUGHOUT THE PROJECT. THE LANDSCAPE ARCHITECT AND THE OWNER'S REPRESENTATIVE RESERVES THE RIGHT TO REJECT ANY SUBSTANDARD PLANT MATERIAL. REJECTED MATERIAL SHALL BE REMOVED FROM THE PROJECT SITE IMMEDIATELY.

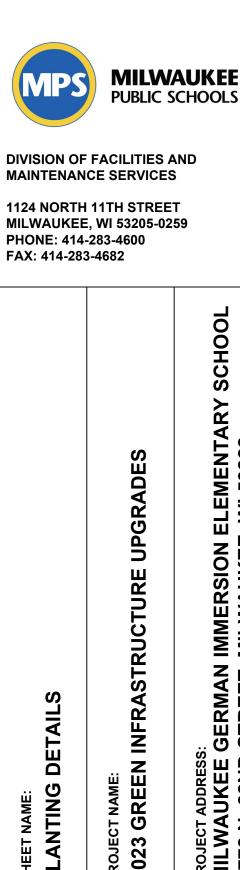

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SHEET PLAN	PROJE(PROJE MILW 3778
ISSUED FOR	: REV:	DATE:
50% CD		1 <u>1/14/2</u> 022
95% CD		1 <u>2/22/2</u> 02
100% CD		1/2 <u>3/202</u> 3

RAWN BY:	ZWA		
EVIEWED BY:	KW		
PPROVED BY:	ММ		
ATE:	January 2023		
KERRY WHITE LA-822-14 WAUWATOSA			
WIC			


PROJECT NUMBER: 7331 (DIVISION 1)

SITE NUMBER: 146

Know what's **below. Call** before you dig.

L501

SHEET:

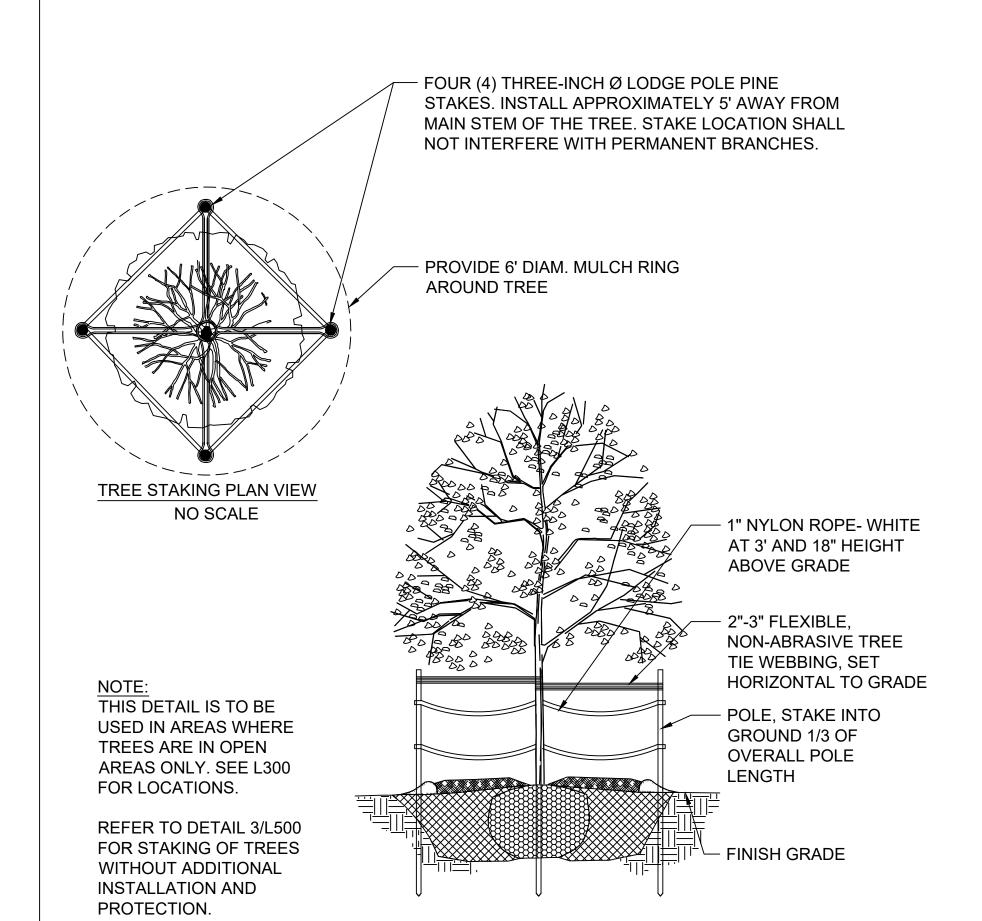

SECTION

TREE INSTALLATION AND PROTECTION STAKING
SECTION NTS